
METROLINIC

Integrated Transport. Integrated Life.

Draft Railway Order 2022



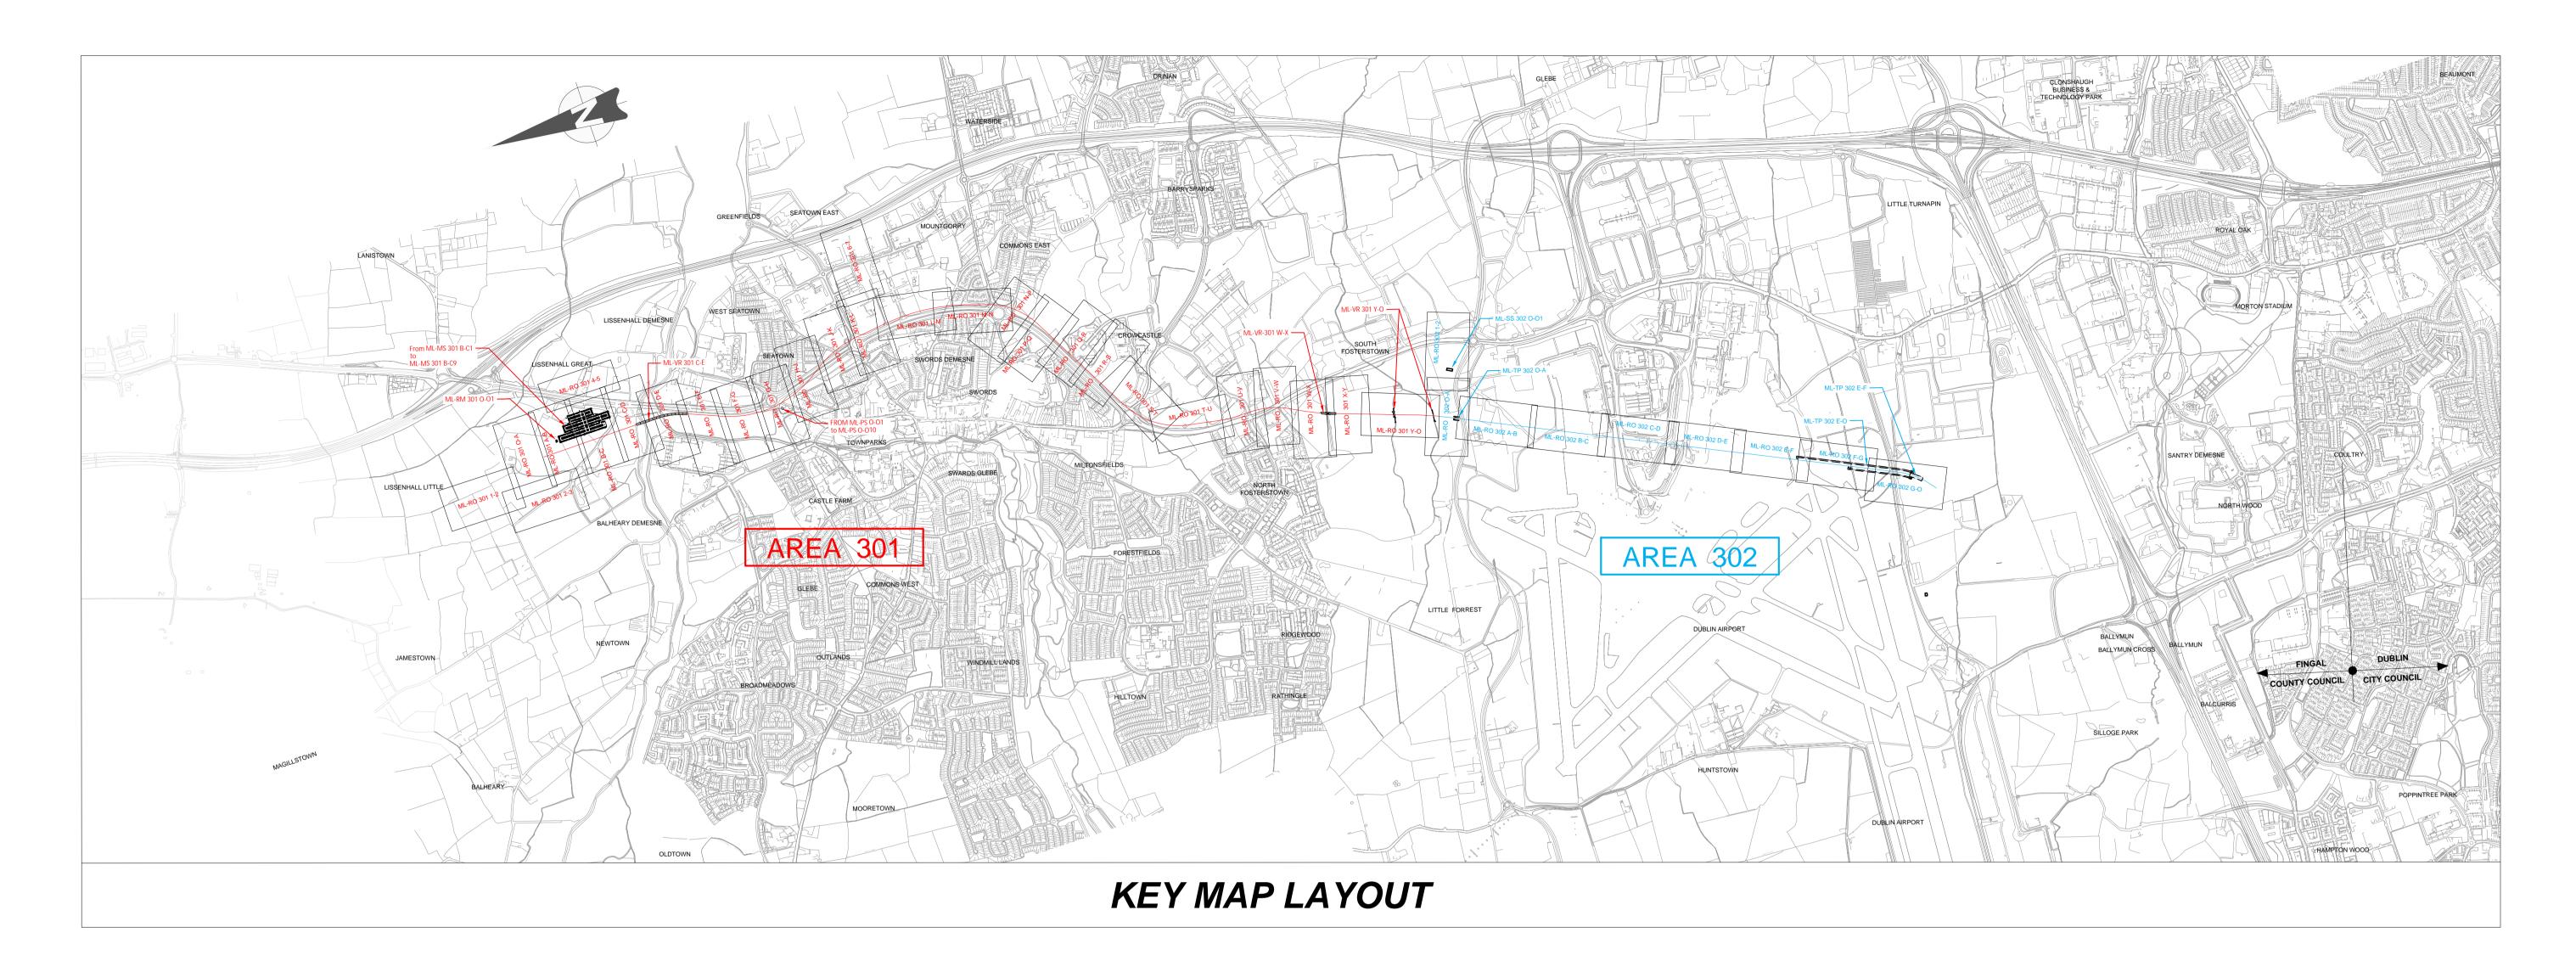

Area	Plan Drawing No.	Internal Drawing No.	Drawing Title
Area 301	ML-RM 301 O-O1	ML1-JAI-SRD-ROUT_XX-DR-Y-09001	RADIO BASE STATION & ANTENNA -ESTUARY
Area 301	ML-MS 301 B-C1	ML1-JAI-SRD-ROUT_XX-DR-Y-06001	PARK & RIDE - LOCATION PLAN
Area 301	ML-MS 301 B-C2	ML1-JAI-SRD-ROUT_XX-DR-Y-06002	PARK & RIDE - GENERAL GROUND FLOOR PLAN
Area 301	ML-MS 301 B-C3	ML1-JAI-SRD-ROUT_XX-DR-Y-06003	PARK & RIDE - GENERAL FIRST FLOOR PLAN
Area 301	ML-MS 301 B-C4	ML1-JAI-SRD-ROUT_XX-DR-Y-06004	PARK & RIDE - GENERAL SECOND FLOOR PLAN
Area 301	ML-MS 301 B-C5	ML1-JAI-SRD-ROUT_XX-DR-Y-06005	PARK & RIDE - GENERAL THIRD FLOOR PLAN
Area 301	ML-MS 301 B-C6	ML1-JAI-SRD-ROUT_XX-DR-Y-06006	PARK & RIDE - GENERAL FORTH FLOOR PLAN
Area 301	ML-MS 301 B-C7	ML1-JAI-SRD-ROUT_XX-DR-Y-06007	PARK & RIDE - OFFICE ENLARGED PLAN
Area 301	ML-MS 301 B-C8	ML1-JAI-SRD-ROUT_XX-DR-Y-06008	PARK & RIDE - GENERAL ELEVATIONS
Area 301	ML-MS 301 B-C9	ML1-JAI-SRD-ROUT_XX-DR-Y-06009	PARK & RIDE - GENERAL SECTIONS
Area 301	ML-VR 301 C-E	ML1-JAI-SRD-ROUT_XX-DR-Y-04002	BROADMEADOW VIADUCT - PLAN LAYOUT AND LONGITUDINAL SECTION
Area 301	ML-VR-301 W-X	ML1-JAI-SRD-ROUT_XX-DR-Y-04003	FOSTERSTOWN ACCOMODATION BRIDGE
Area 301	ML-VR 301 Y-O	ML1-JAI-SRD-ROUT_XX-DR-Y-01006	CULVERTS SHEET 1
Area 301	ML-VR 301 Y-O	ML1-JAI-SRD-ROUT_XX-DR-Y-01006	CULVERTS SHEET 2
Area 301	ML-PS 0-01	ML1-JAI-SRD-ROUT_XX-DR-Y-09007	SWORDS PUMPING STATION - PUMPING STATION
Area 301	ML-PS O-O2	ML1-JAI-SRD-ROUT_XX-DR-Y-09008	SWORDS PUMPING STATION - WEST ELEVATION
Area 301	ML-PS 0-03	ML1-JAI-SRD-ROUT_XX-DR-Y-09009	SWORDS PUMPING STATION - NORTH ELEVATION
Area 301	ML-PS O-O4	ML1-JAI-SRD-ROUT_XX-DR-Y-09010	SWORDS PUMPING STATION - CONTROL BUILDING ELEVATIONS
Area 301	ML-PS O-O5	ML1-JAI-SRD-ROUT_XX-DR-Y-09011	SWORDS PUMPING STATION - CONTROL BUILDING PLAN
Area 301	ML-PS O-O6	ML1-JAI-SRD-ROUT_XX-DR-Y-09012	SWORDS PUMPING STATION - SUMP ACCESS COVER LAYOUT
Area 301	ML-PS O-O7	ML1-JAI-SRD-ROUT_XX-DR-Y-09013	SWORDS PUMPING STATION - EAST ELEVATION
Area 301	ML-PS O-O8	ML1-JAI-SRD-ROUT_XX-DR-Y-09014	SWORDS PUMPING STATION - SOUTH ELEVATION
Area 301	ML-PS O-O9	ML1-JAI-SRD-ROUT_XX-DR-Y-09015	SWORDS PUMPING STATION - CROSS SECTION
Area 301	ML-PS O-O10	ML1-JAI-SRD-ROUT_XX-DR-Y-09016	SWORDS PUMPING STATION - PROPOSED GENERAL ARRANGEMENT PLAN
Area 302	ML-SS 302 O-O1	ML1-JAI-SRD-ROUT_XX-DR-Y-08001	SURFACE SUBSTATION (PLAN VIEW AND PROFILE)
Area 302	ML-TP 302 O-A	ML1-JAI-SRD-ROUT_XX-DR-Y-01001	PLAN LAYOUT FOR AIRPORT NORTH PORTAL (PLAN VIEW AND LONGITUDINAL)
Area 302	ML-TP 302 E-F	ML1-JAI-SRD-ROUT_XX-DR-Y-01002	PLAN LAYOUT FOR AIRPORT SOUTH PORTAL (PLAN VIEW AND LONGITUDINAL)
Area 302	ML-TP 302 E-O	ML1-JAI-SRD-ROUT_XX-DR-Y-01003	AIRPORT VENTILATION AND EMERGENCY ACCESS TUNNELS - PLAN AND CROSS SECTIONS
Area 302	ML-RO 302 O-A	ML1-JAI-SRD-ROUT_XX-DR-Y-08009	HV SURFACE SUBSTATION - NORTH PORTAL (ELEVATIONS)
Area 302	N/A	ML1-JAI-SRD-ROUT_XX-DR-Y-08014	ESBN & METROLINK 110KV SUBSTATION COMPOUND PLAN VIEW NORTH PORTAL
Area 302	N/A	ML1-JAI-SRD-ROUT_XX-DR-Y-08015	ESBN & METROLINK 110KV SUBSTATION COMPOUND ELEVATION NORTH PORTAL
All	ML-TP 000 O-O1	ML1-JAI-SRD-ROUT_XX-DR-Y-01004	TYPICAL TUNNEL CROSS SECTIONS
All	ML-BT O-O1	ML1-JAI-SRD-ROUT_XX-DR-Y-07001	TYPICAL DETAILS FENCE TYPE A
All	ML-BT O-O2	ML1-JAI-SRD-ROUT_XX-DR-Y-07002	TYPICAL DETAILS FENCE TYPE B
All	ML-BT O-O3	ML1-JAI-SRD-ROUT_XX-DR-Y-07003	TYPICAL DETAILS FENCE TYPE C
All	ML-BT O-O4	ML1-JAI-SRD-ROUT_XX-DR-Y-07004	TYPICAL DETAILS FENCE TYPE D
All	ML-BT O-O5	ML1-JAI-SRD-ROUT_XX-DR-Y-07005	TYPICAL DETAILS FENCE TYPE E
All	ML-BT O-O6	ML1-JAI-SRD-ROUT_XX-DR-Y-07006	TYPICAL DETAILS FENCE TYPE F
All	ML-BT O-O7	ML1-JAI-SRD-ROUT_XX-DR-Y-07007	TYPICAL DETAILS FENCE TYPE G
All	ML-BT O-O8	ML1-JAI-SRD-ROUT_XX-DR-Y-07008	TYPICAL DETAILS FENCE TYPE H
All	ML-BT O-O9	ML1-JAI-SRD-ROUT_XX-DR-Y-07009	FLOODLIGHTING TYPICAL DETAIL
All	ML-BP O-O1	ML1-JAI-SRD-ROUT_XX-DR-Y-08008	BICYCLE PARKING BUILDING

RAILWAY WORKS - METROLINK

STRUCTURE DETAILS
FINGAL COUNTY COUNCIL AREA
BOOK 3 OF 3 (AREA ML301 TO ML302)










© National Roads Authority (NRA) 1994-2022. This drawing is confidential and the copyright in it is owned by NRA. This drawing must not be either loaned, copied or otherwise reproduced inwhole or in part or used for any purpose without the prior permission of NRA. Transport Infrastructure Ireland (TII) is an operational name of the National Roads Authority. © Ordnance Survey Ireland 2022/ OSi_NMA_273. All elevations are in metres and relate to OSi Geoid Model (OSGM02) Malin Head as defined by existing Project Control. All Co-ordinates are in Irish Transverse Mercator Grid (ITM) as defined by OSi active GPS station Tallaght College(TLLG).

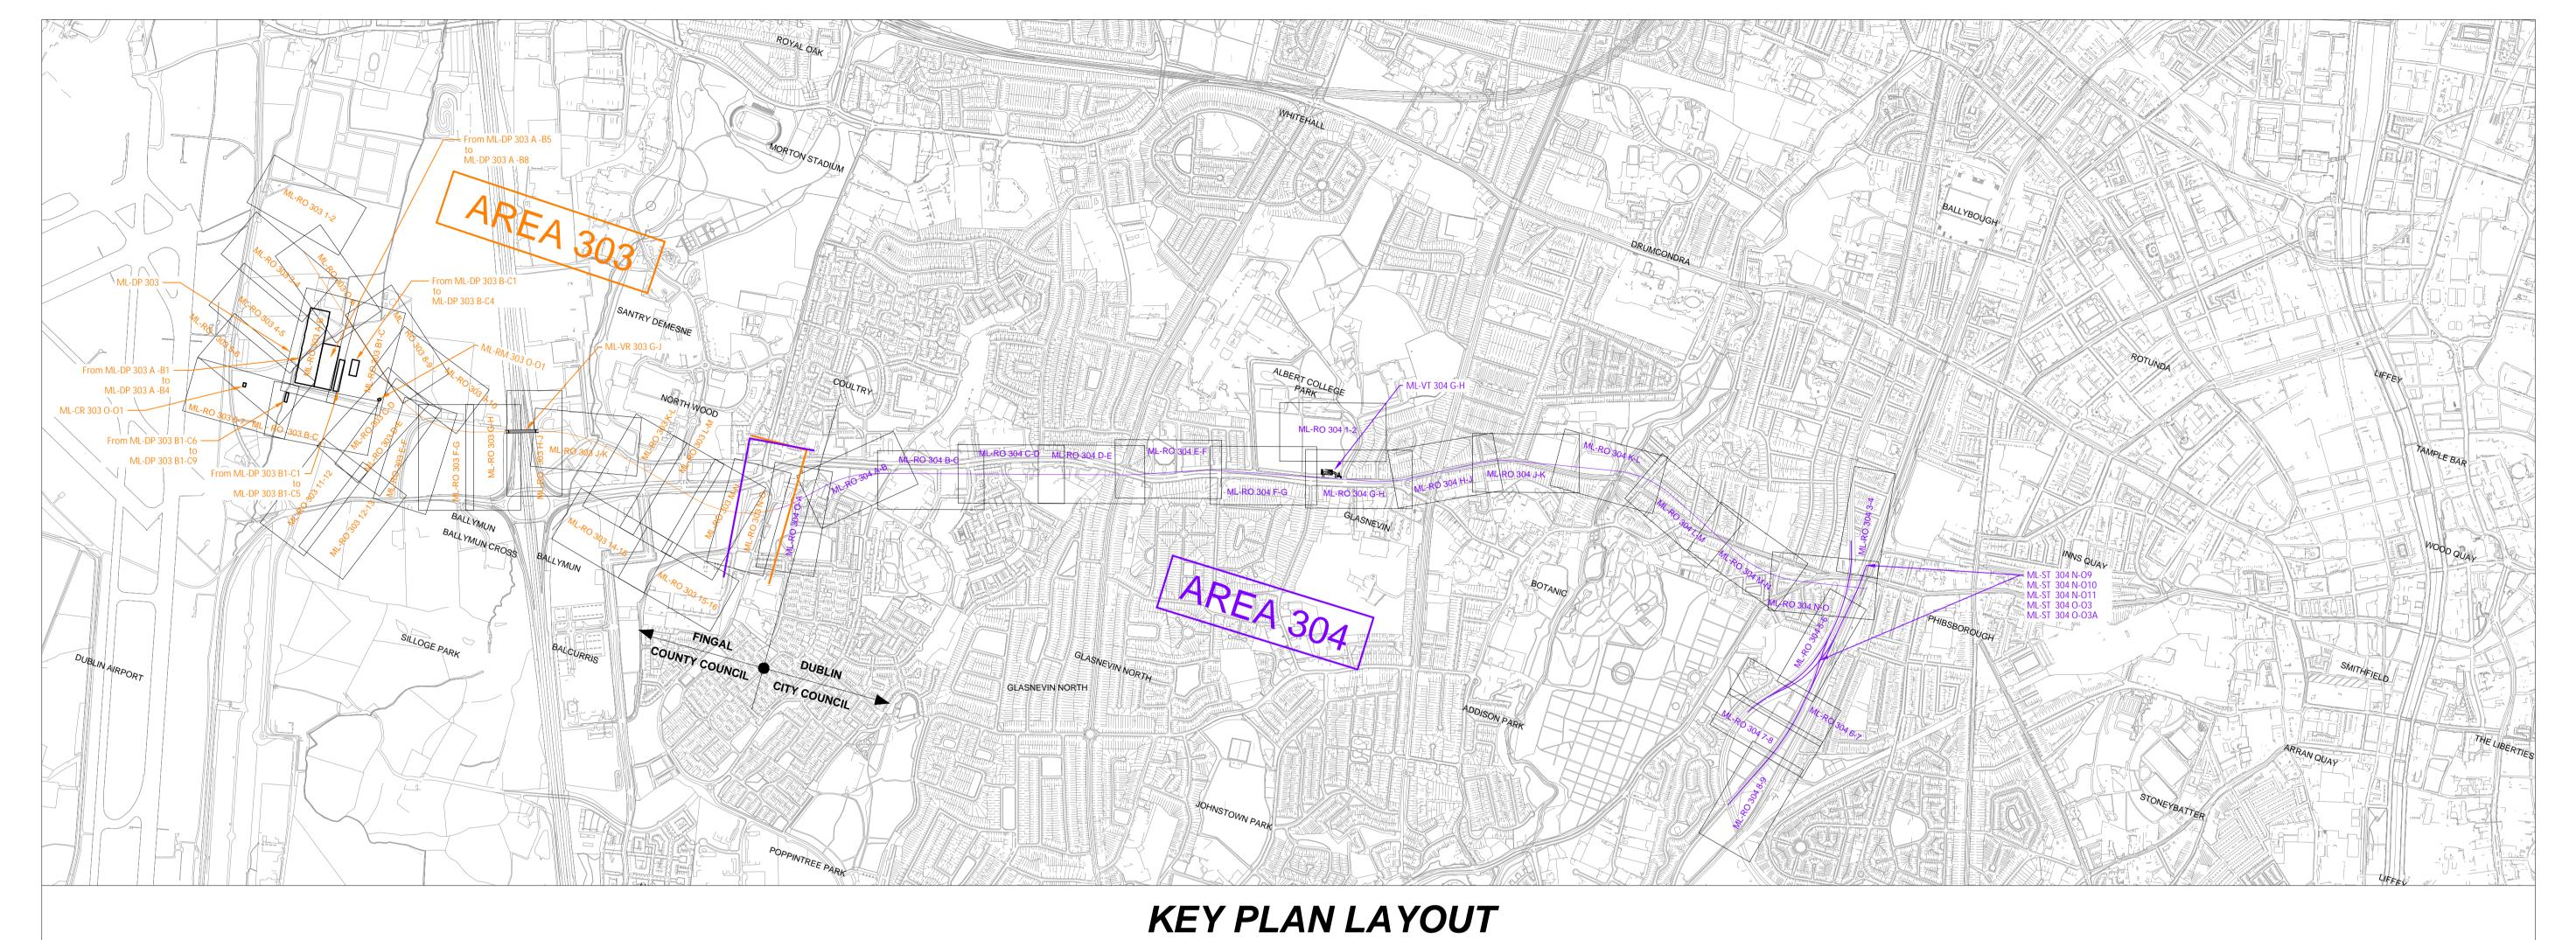

Internal Drawing No ML-DP 303 DEPOT GENERAL LAYOUT DEPOT. STABLING AREA (BUILDING G+G1) GROUND LEVEL PLAN Sheet 1 Area 303 ML-DP 303 A -B1 DEPOT. STABLING AREA (BUILDING G+G1) GROUND LEVEL PLAN Sheet 2 ML-DP 303 A -B1 ML1-JAI-SRD-ROUT_XX-DR-Y-05002 ML1-IAI-SRD-ROLIT XX-DR-Y-05002 DEPOT STABLING AREA (BUILDING G+G1) GROUND LEVEL PLAN Sheet 3 ML-DP 303 A -B1 Area 303 ML1-JAI-SRD-ROUT_XX-DR-Y-05003 DEPOT. STABLING AREA (BUILDING G+G1) ROOF LEVEL PLAN Sheet 1 Area 303 ML-DP 303 A -B2 ML1-JAI-SRD-ROUT_XX-DR-Y-05003 ML-DP 303 A -B2 DEPOT. STABLING AREA (BUILDING G+G1)ROOF LEVEL PLAN Sheet 2 ML1-JAI-SRD-ROUT_XX-DR-Y-05003 ML-DP 303 A -B2 DEPOT. STABLING AREA (BUILDING G+G1) ROOF LEVEL PLAN Sheet 3 Area 303 Area 303 ML-DP 303 A -B3 ML1-JAI-SRD-ROUT_XX-DR-Y-05004 DEPOT. STABLING AREA (BUILDING G+G1) SECTIONS Sheet 1 ML1-JAI-SRD-ROUT_XX-DR-Y-05004 ML-DP 303 A -B3 DEPOT. STABLING AREA (BUILDING G+G1) SECTIONS Sheet 2 ML1-TAI-SRD-ROLIT XX-DR-Y-05000 DEPOT. STABLING AREA (BUILDING G+G1) ELEVATIONS Sheet 1 ML-DP 303 A -B4 Area 303 ML1-JAI-SRD-ROUT_XX-DR-Y-05005 DEPOT. STABLING AREA (BUILDING G+G1) ELEVATIONS Sheet 2 Area 303 ML-DP 303 A -B4 Area 303 ML-DP 303 A -B5 ML1-JAI-SRD-ROUT_XX-DR-Y-05006 DEPOT. MAIN MAINTENANCE WORKSHOP & GENERAL STORAGE (BUILDING C) GROUND LEVEL PLAN Sheet 1 ML1-JAI-SRD-ROUT_XX-DR-Y-05006 DEPOT, MAIN MAINTENANCE WORKSHOP & GENERAL STORAGE (BLIILDING C) GROUND LEVEL PLAN Sheet 2 Area 303 ML-DP 303 A -B5 ML1-JAI-SRD-ROUT_XX-DR-Y-05007 Area 303 ML-DP 303 A -B6 DEPOT. MAIN MAINTENANCE WORKSHOP & GENERAL STORAGE (BUILDING C) ROOF LEVEL PLAN Sheet 1 DEPOT. MAIN MAINTENANCE WORKSHOP & GENERAL STORAGE (BUILDING C) ROOF LEVEL PLAN Sheet 2 ML-DP 303 A -B6 ML1-JAI-SRD-ROUT_XX-DR-Y-05007 ML1-JAI-SRD-ROUT XX-DR-Y-05008 ML-DP 303 A -B7 DEPOT. MAIN MAINTENANCE WORKSHOP & GENERAL STORAGE (BUILDING C) SECTIONS Area 303 ML1-JAI-SRD-ROUT_XX-DR-Y-05009 DEPOT. MAIN MAINTENANCE WORKSHOP & GENERAL STORAGE (BUILDING C) ELEVATIONS Area 303 ML-DP 303 A -B8 ML-DP 303 B1-C1 ML1-JAI-SRD-ROUT_XX-DR-Y-05010 DEPOT. MAIN OFFICES AND ADMINISTRATION/STAFF (BUILDING D) GROUND LEVEL PLAN Area 303 ML-DP 303 B1-C2 ML1-JAI-SRD-ROUT_XX-DR-Y-05011 DEPOT. MAIN OFFICES AND ADMINISTRATION/STAFF (BUILDING D) FIRST LEVEL PLAN ML1-JAI-SRD-ROUT_XX-DR-Y-05012 Area 303 ML-DP 303 B1-C3 DEPOT. MAIN OFFICES AND ADMINISTRATION/STAFF (BUILDING D) ROOF LEVEL PLAN ML-DP 303 B1-C4 ML1-JAI-SRD-ROUT_XX-DR-Y-05013 DEPOT. MAIN OFFICES AND ADMINISTRATION/STAFF (BUILDING D) SECTIONS ML1-JAI-SRD-ROUT XX-DR-Y-05014 DEPOT, MAIN OFFICES AND ADMINISTRATION/STAFF (BUILDING D) ELEVATIONS Area 303 ML-DP 303 B1-C5 Area 303 ML-DP 303 B1-C6 ML1-JAI-SRD-ROUT_XX-DR-Y-05015 DEPOT. ELECTRICAL SUBESTATION AND DISTRIBUTION (BUILDING E) GROUND LEVEL PLAN ML-DP 303 B1-C7 ML1-JAI-SRD-ROUT_XX-DR-Y-05016 DEPOT. ELECTRICAL SUBESTATION AND DISTRIBUTION (BUILDING E) ROOF LEVEL PLAN ML1-JAI-SRD-ROUT_XX-DR-Y-05017 ML-DP 303 B1-C8 DEPOT, ELECTRICAL SUBESTATION AND DISTRIBUTION (BUILDING E) SECTIONS Area 303 Area 303 ML-DP 303 B1-C9 ML1-JAI-SRD-ROUT_XX-DR-Y-05018 DEPOT. ELECTRICAL SUBESTATION AND DISTRIBUTION (BUILDING E) ELEVATIONS Area 303 ML1-JAI-SRD-ROUT_XX-DR-Y-05019 DEPOT. PERMANENT WAY & MAINTENANCE BUILDING (BUILDING P) GROUND LEVEL PLAN ML1-JAI-SRD-ROUT XX-DR-Y-05020 Area 303 ML-DP 303 B-C2 DEPOT, PERMANENT WAY & MAINTENANCE BUILDING (BUILDING P) ROOF LEVEL PLAN ML1-JAI-SRD-ROUT_XX-DR-Y-05021 DEPOT. PERMANENT WAY & MAINTENANCE BUILDING (BUILDING P) SECTIONS ML-DP 303 B-C3 Area 303 ML-DP 303 B-C4 ML1-JAI-SRD-ROUT_XX-DR-Y-05022 DEPOT. PERMANENT WAY & MAINTENANCE BUILDING (BUILDING P) ELEVATIONS ML1-JAI-SRD-ROUT_XX-DR-Y-09002 RADIO BASE STATION & ANTENNA - DARDISTOWN ML-RM 303 O-O1 Area 303 Area 303 ML-VR 303 G-J ML1-JAI-SRD-ROUT_XX-DR-Y-04001 M50 VIADUCT - PLAN LAYOUT AND LONGITUDINAL SECTION Area 303 ML-CR 303 O-O1 ML1-JAI-SRD-ROUT_XX-DR-Y-08011 PROPOSED CHANGING ROOM COMPOUND - PLAN AND ELEVATION MI 1- IAI-SRD-ROUT XX-DR-Y-0100 Area 303 ML-RO 303 6-7 DEPOT MAIN ACCESS ROAD - CULVERT ML1-JAI-SRD-ROUT_XX-DR-Y-08010 ESBN HV SURFACE SUBSTATION - DARDISTOWN (ELEVATIONS) Area 303 ML-RO 303 A-B Area 303 ML1-JAI-SRD-ROUT_XX-DR-Y-08012 ESBN & METROLINK 110KV SUBSTATION COMPOUND PLAN VIEW DEPOT N/A ESBN & METROLINK 110KV SUBSTATION COMPOUND ELEVATION DEPOT Area 303 N/A ML1-JAI-SRD-ROUT_XX-DR-Y-08013 ML1-JAI-SRD-ROUT_XX-DR-Y-03001 PLAN LAYOUT FOR ALBERT COLLEGE SHAFT (PLAN VIEW AND LONGITUDINAL) ML-VT 304 G-H Area 304 Area 304 ML-ST 304 N-O9 ML1-JAI-SRD-MS11_XX-DR-Y-01001 GLASNEVIN HEAVY RAIL HORIZONTAL ALIGNMENT PLAN 1 ML1-JAI-SRD-MS11 XX-DR-Y-01002 Area 304 ML-ST 304 N-O10 GLASNEVIN HEAVY RAIL HORIZONTAL ALIGNMENT PLAN 2 ML1-JAI-SRD-MS11 XX-DR-Y-01003 ML-ST 304 N-O11 GLASNEVIN HEAVY RAIL HORIZONTAL ALIGNMENT PLAN 3 Area 304 GLASNEVIN HEAVY RAIL LONG SECTION 1 Area 304 ML-ST 304 O-O3 ML1-JAI-SRD-MS11_XX-DR-Y-01004

GLASNEVIN HEAVY RAIL LONG SECTION 2

ML1-JAI-SRD-MS11_XX-DR-Y-01005

Area 304

ML-ST 304 O-O3A

RAILWAY WORKS - METROLINK

STRUCTURES DETAILS
FINGAL COUNTY/DUBLIN CITY COUNCIL AREA
BOOK 3 OF 3 (AREA ML303 TO ML307)














© National Roads Authority (NRA) 1994-2022. This drawing is confidential and the copyright in it is owned by NRA. This drawing must not be either loaned, copied or otherwise reproduced inwhole or in part or used for any purpose without the prior permission of NRA. Transport Infrastructure Ireland (TII) is an operational name of the National Roads Authority. © Ordnance Survey Ireland 2022/ OSi_NMA_273. All elevations are in metres and relate to OSi Geoid Model (OSGM02) Malin Head as defined by existing Project Control. All Co-ordinates are in Irish Transverse Mercator Grid (ITM) as defined by OSi active GPS station Tallaght College(TLLG).

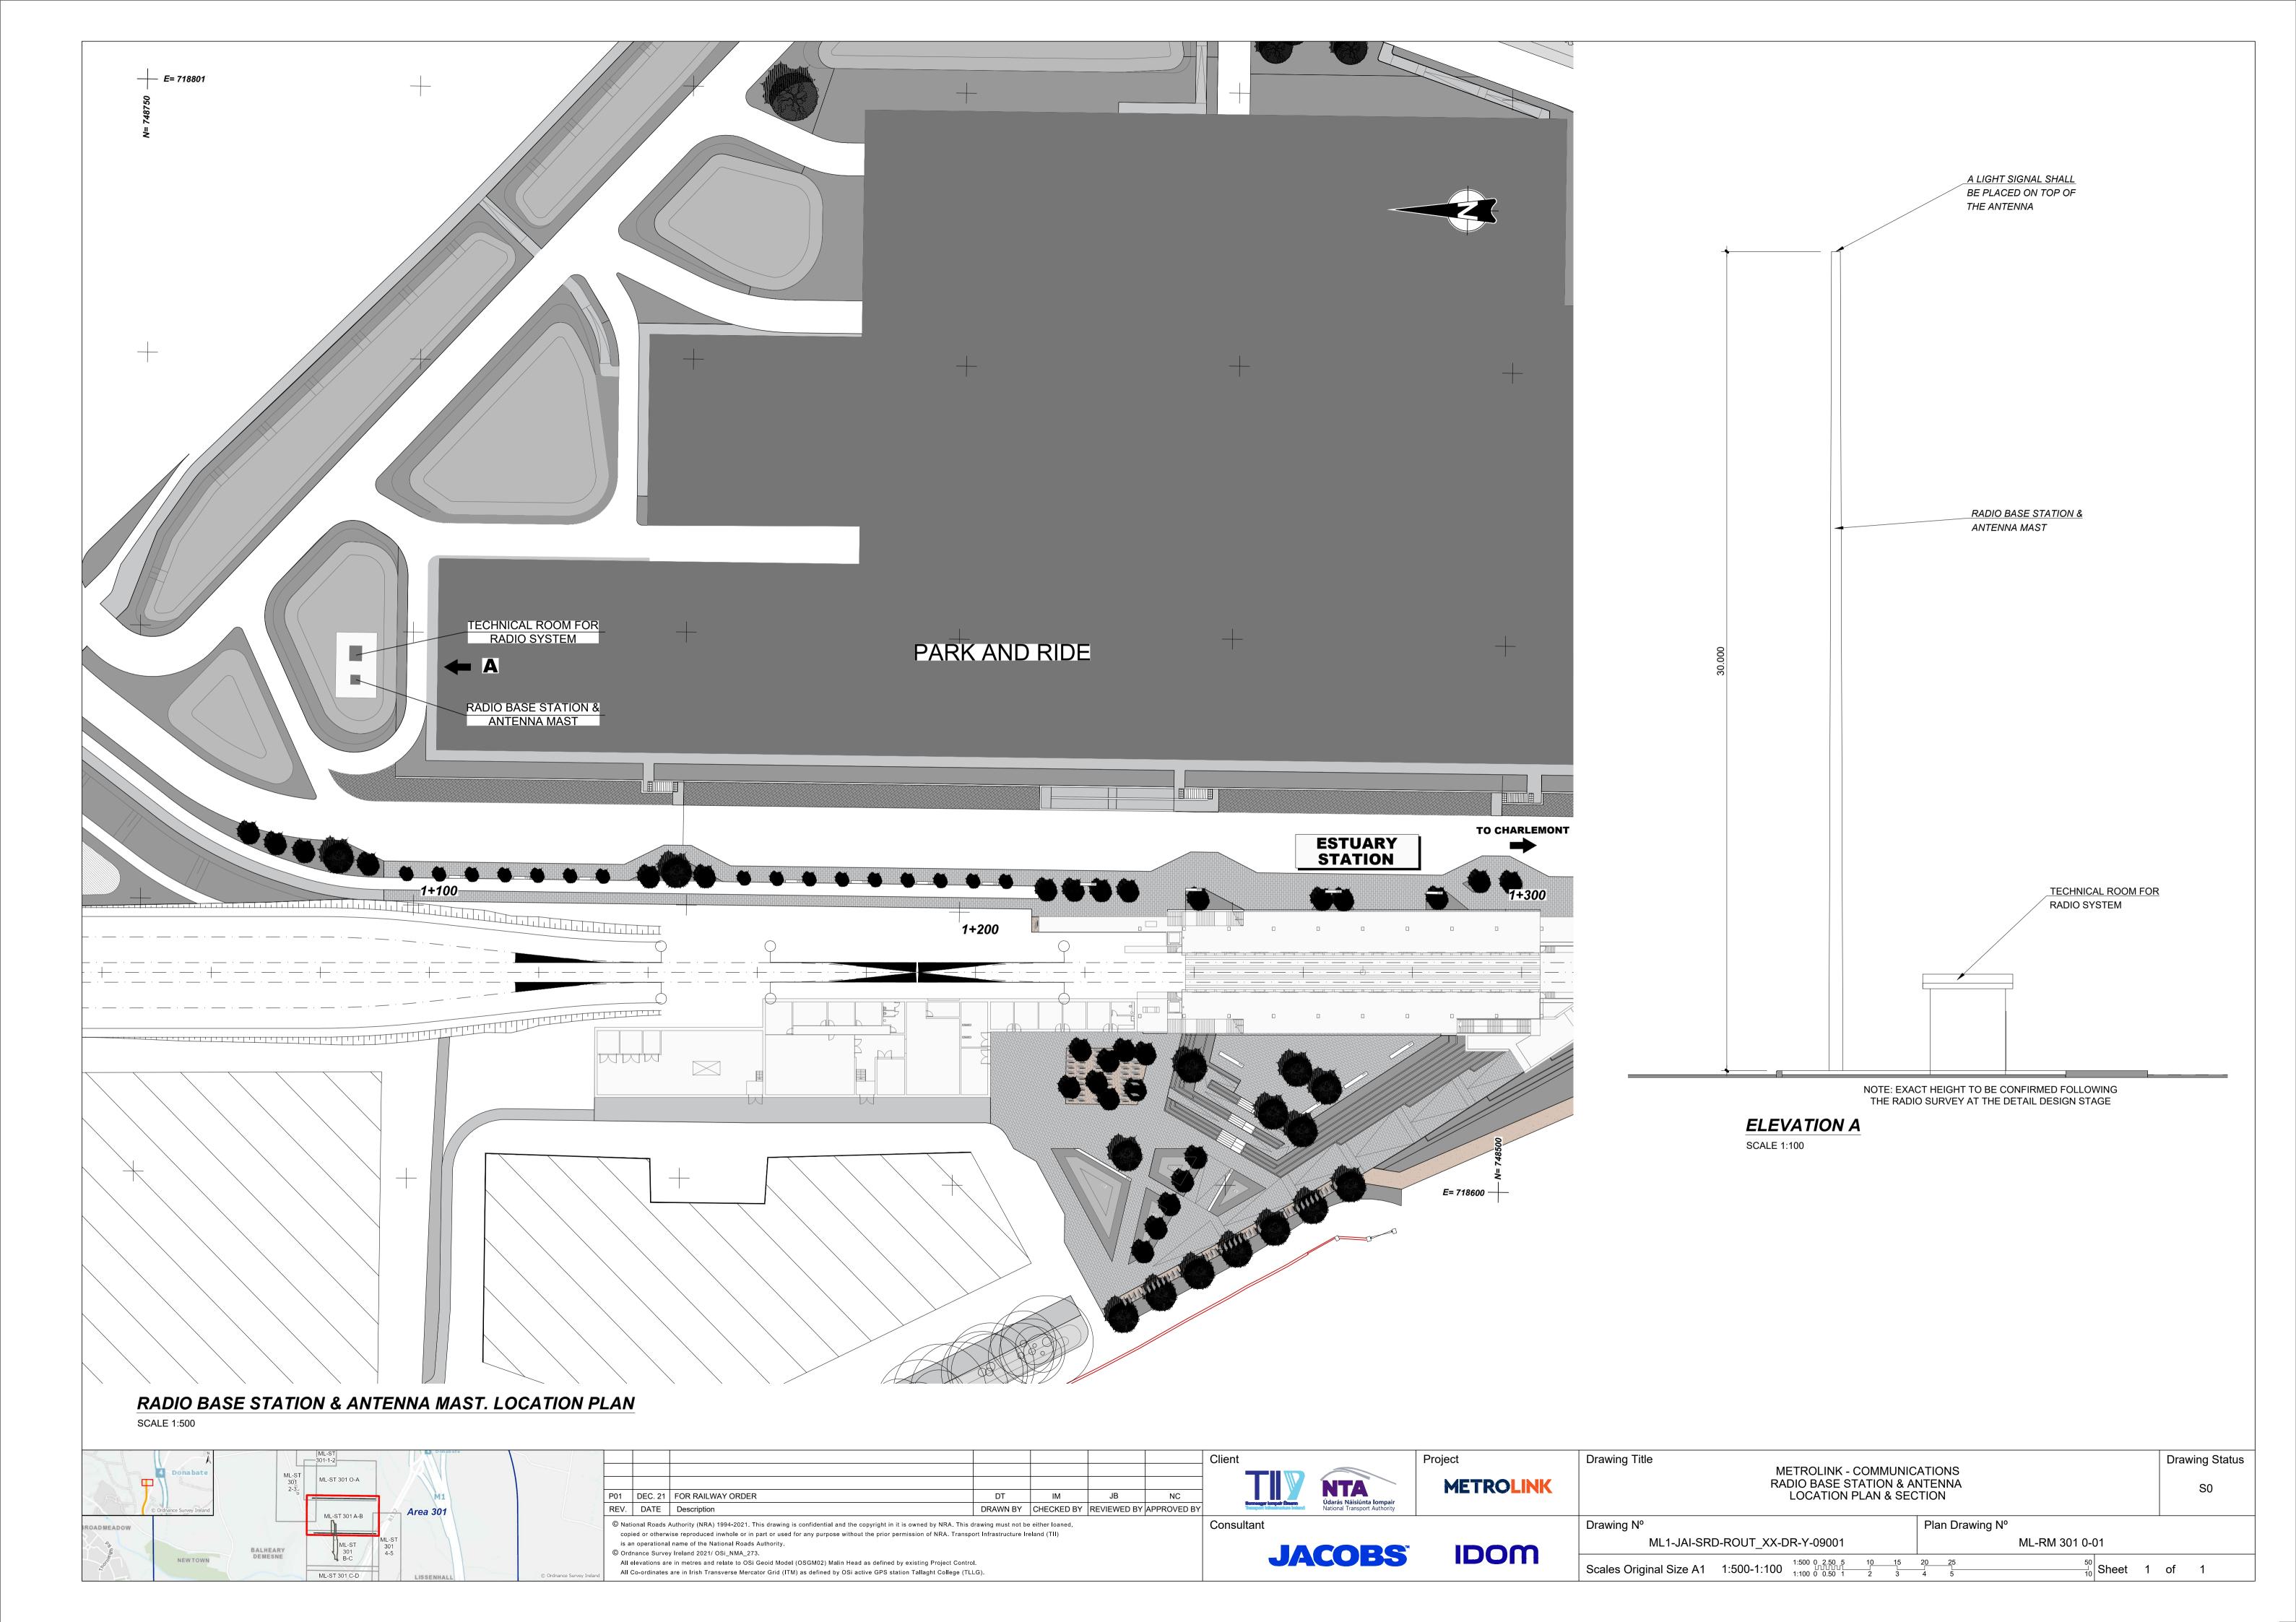


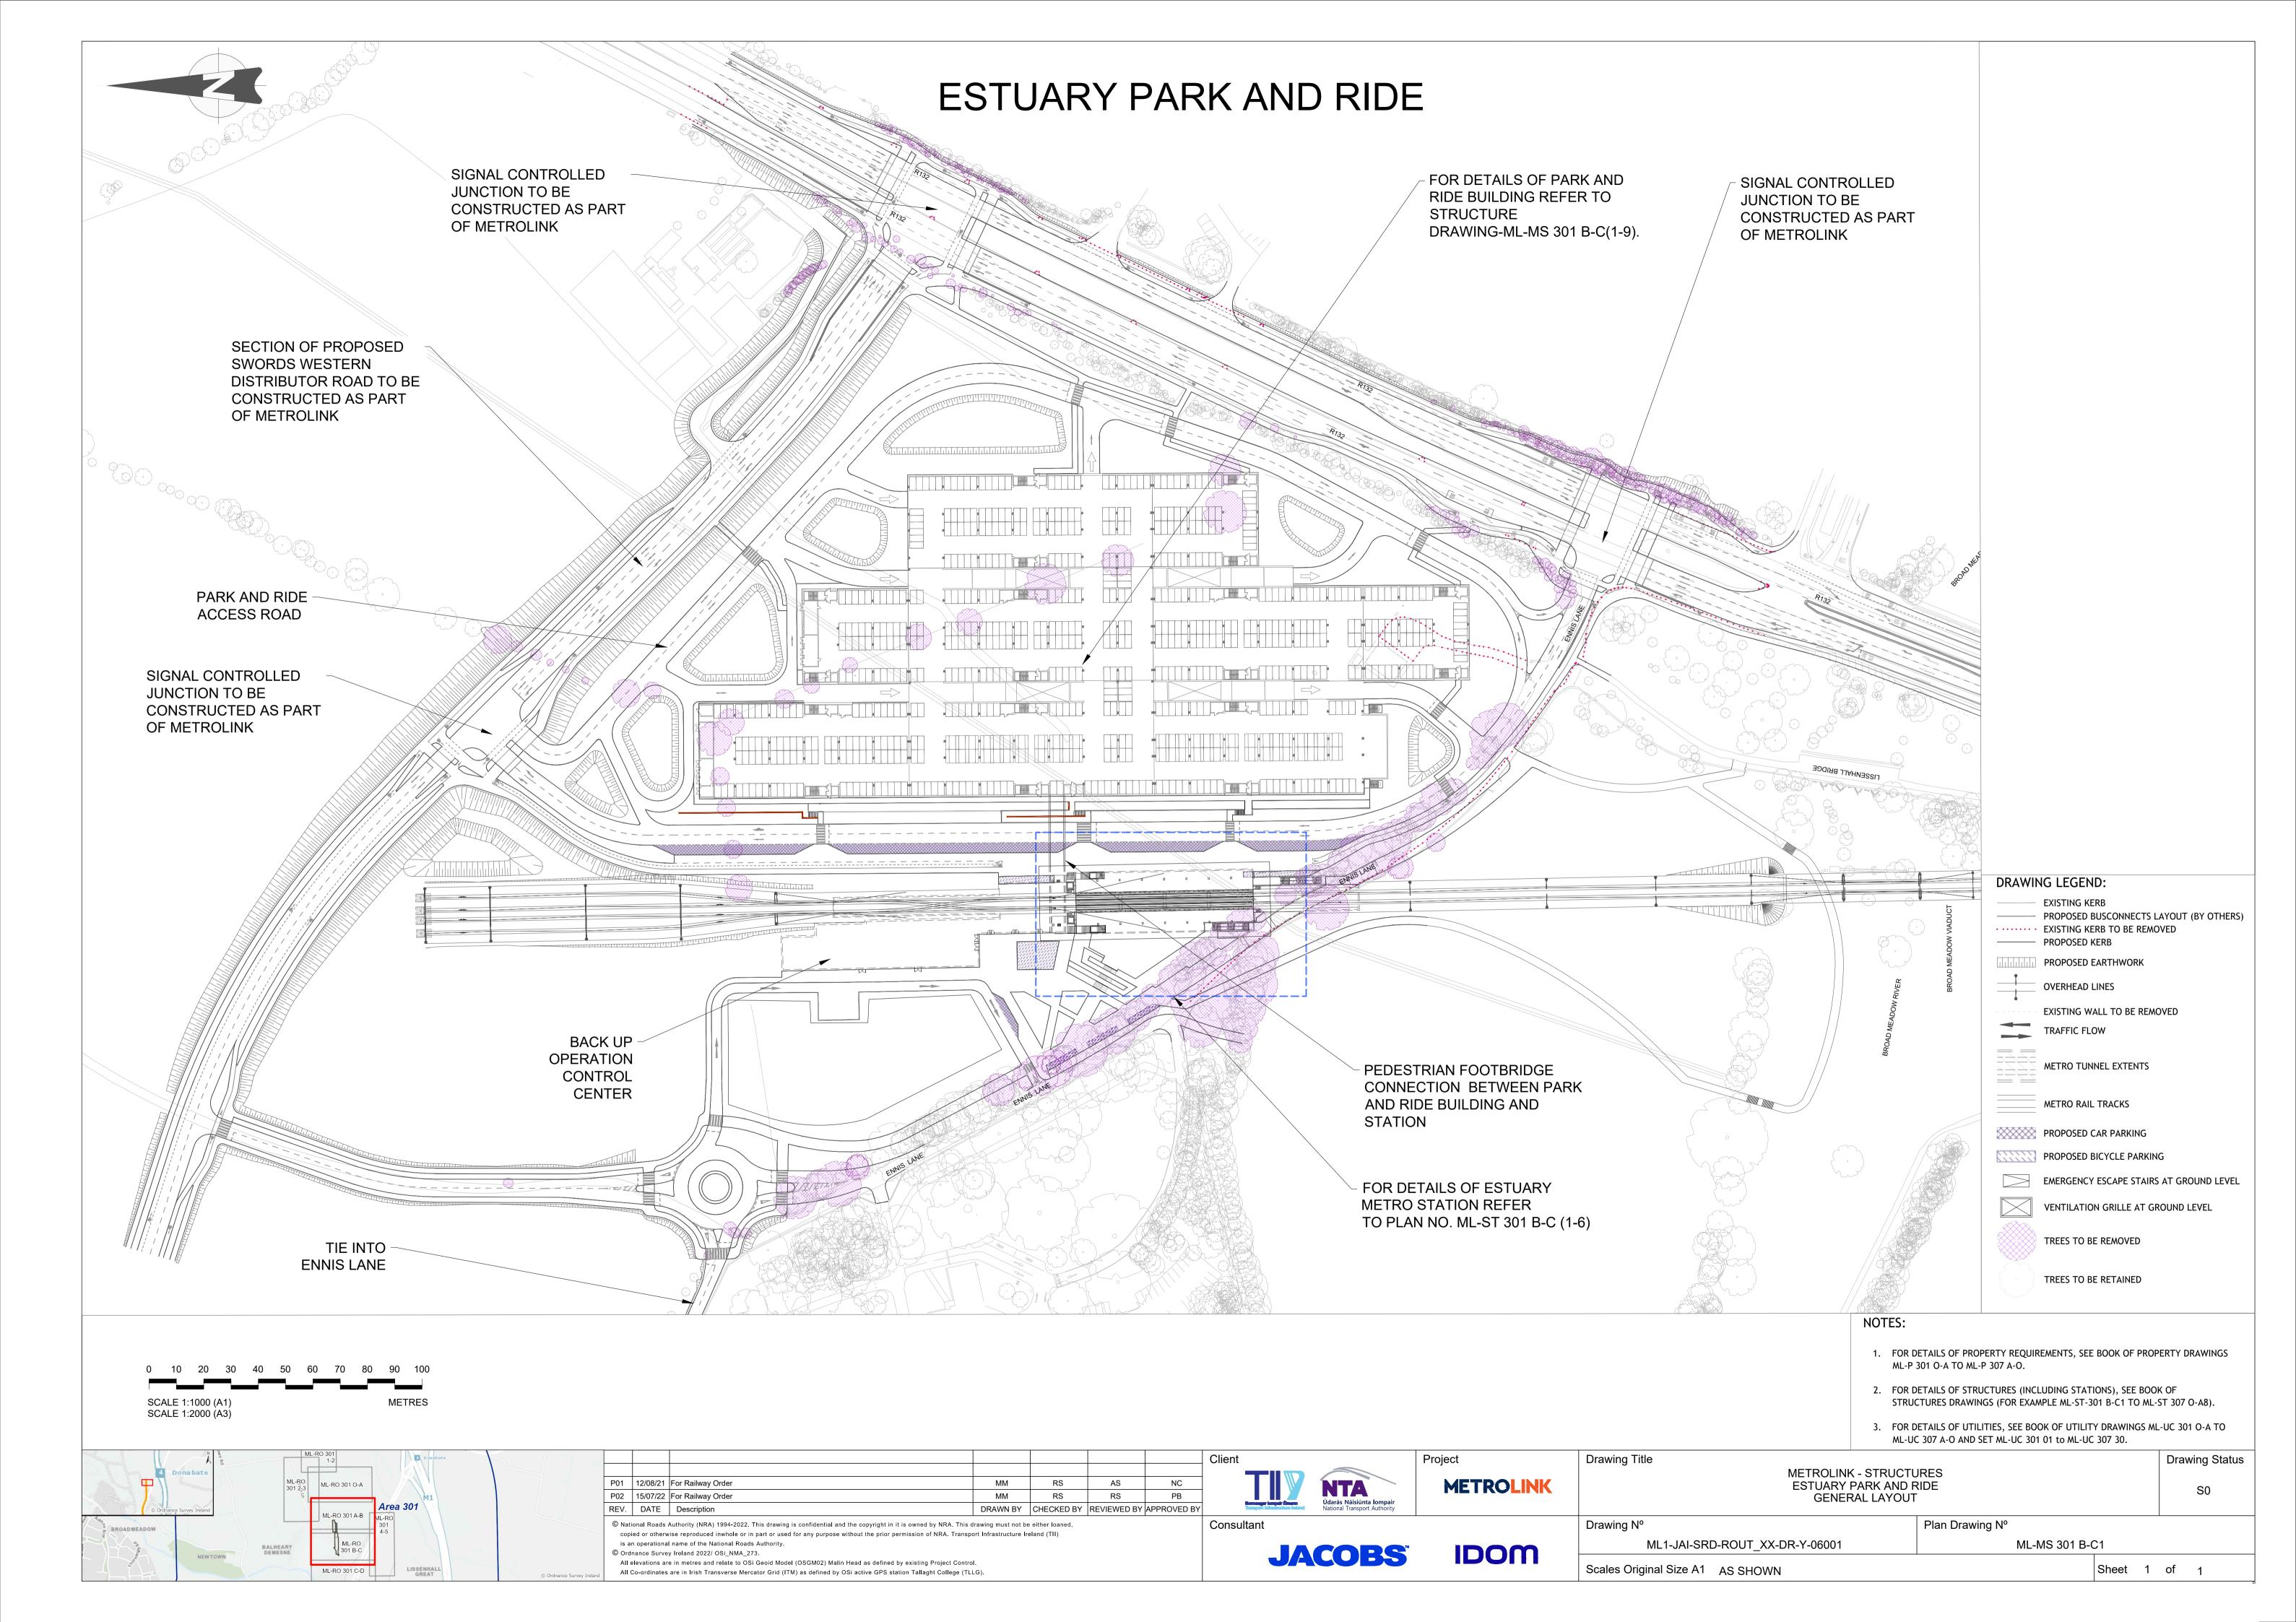


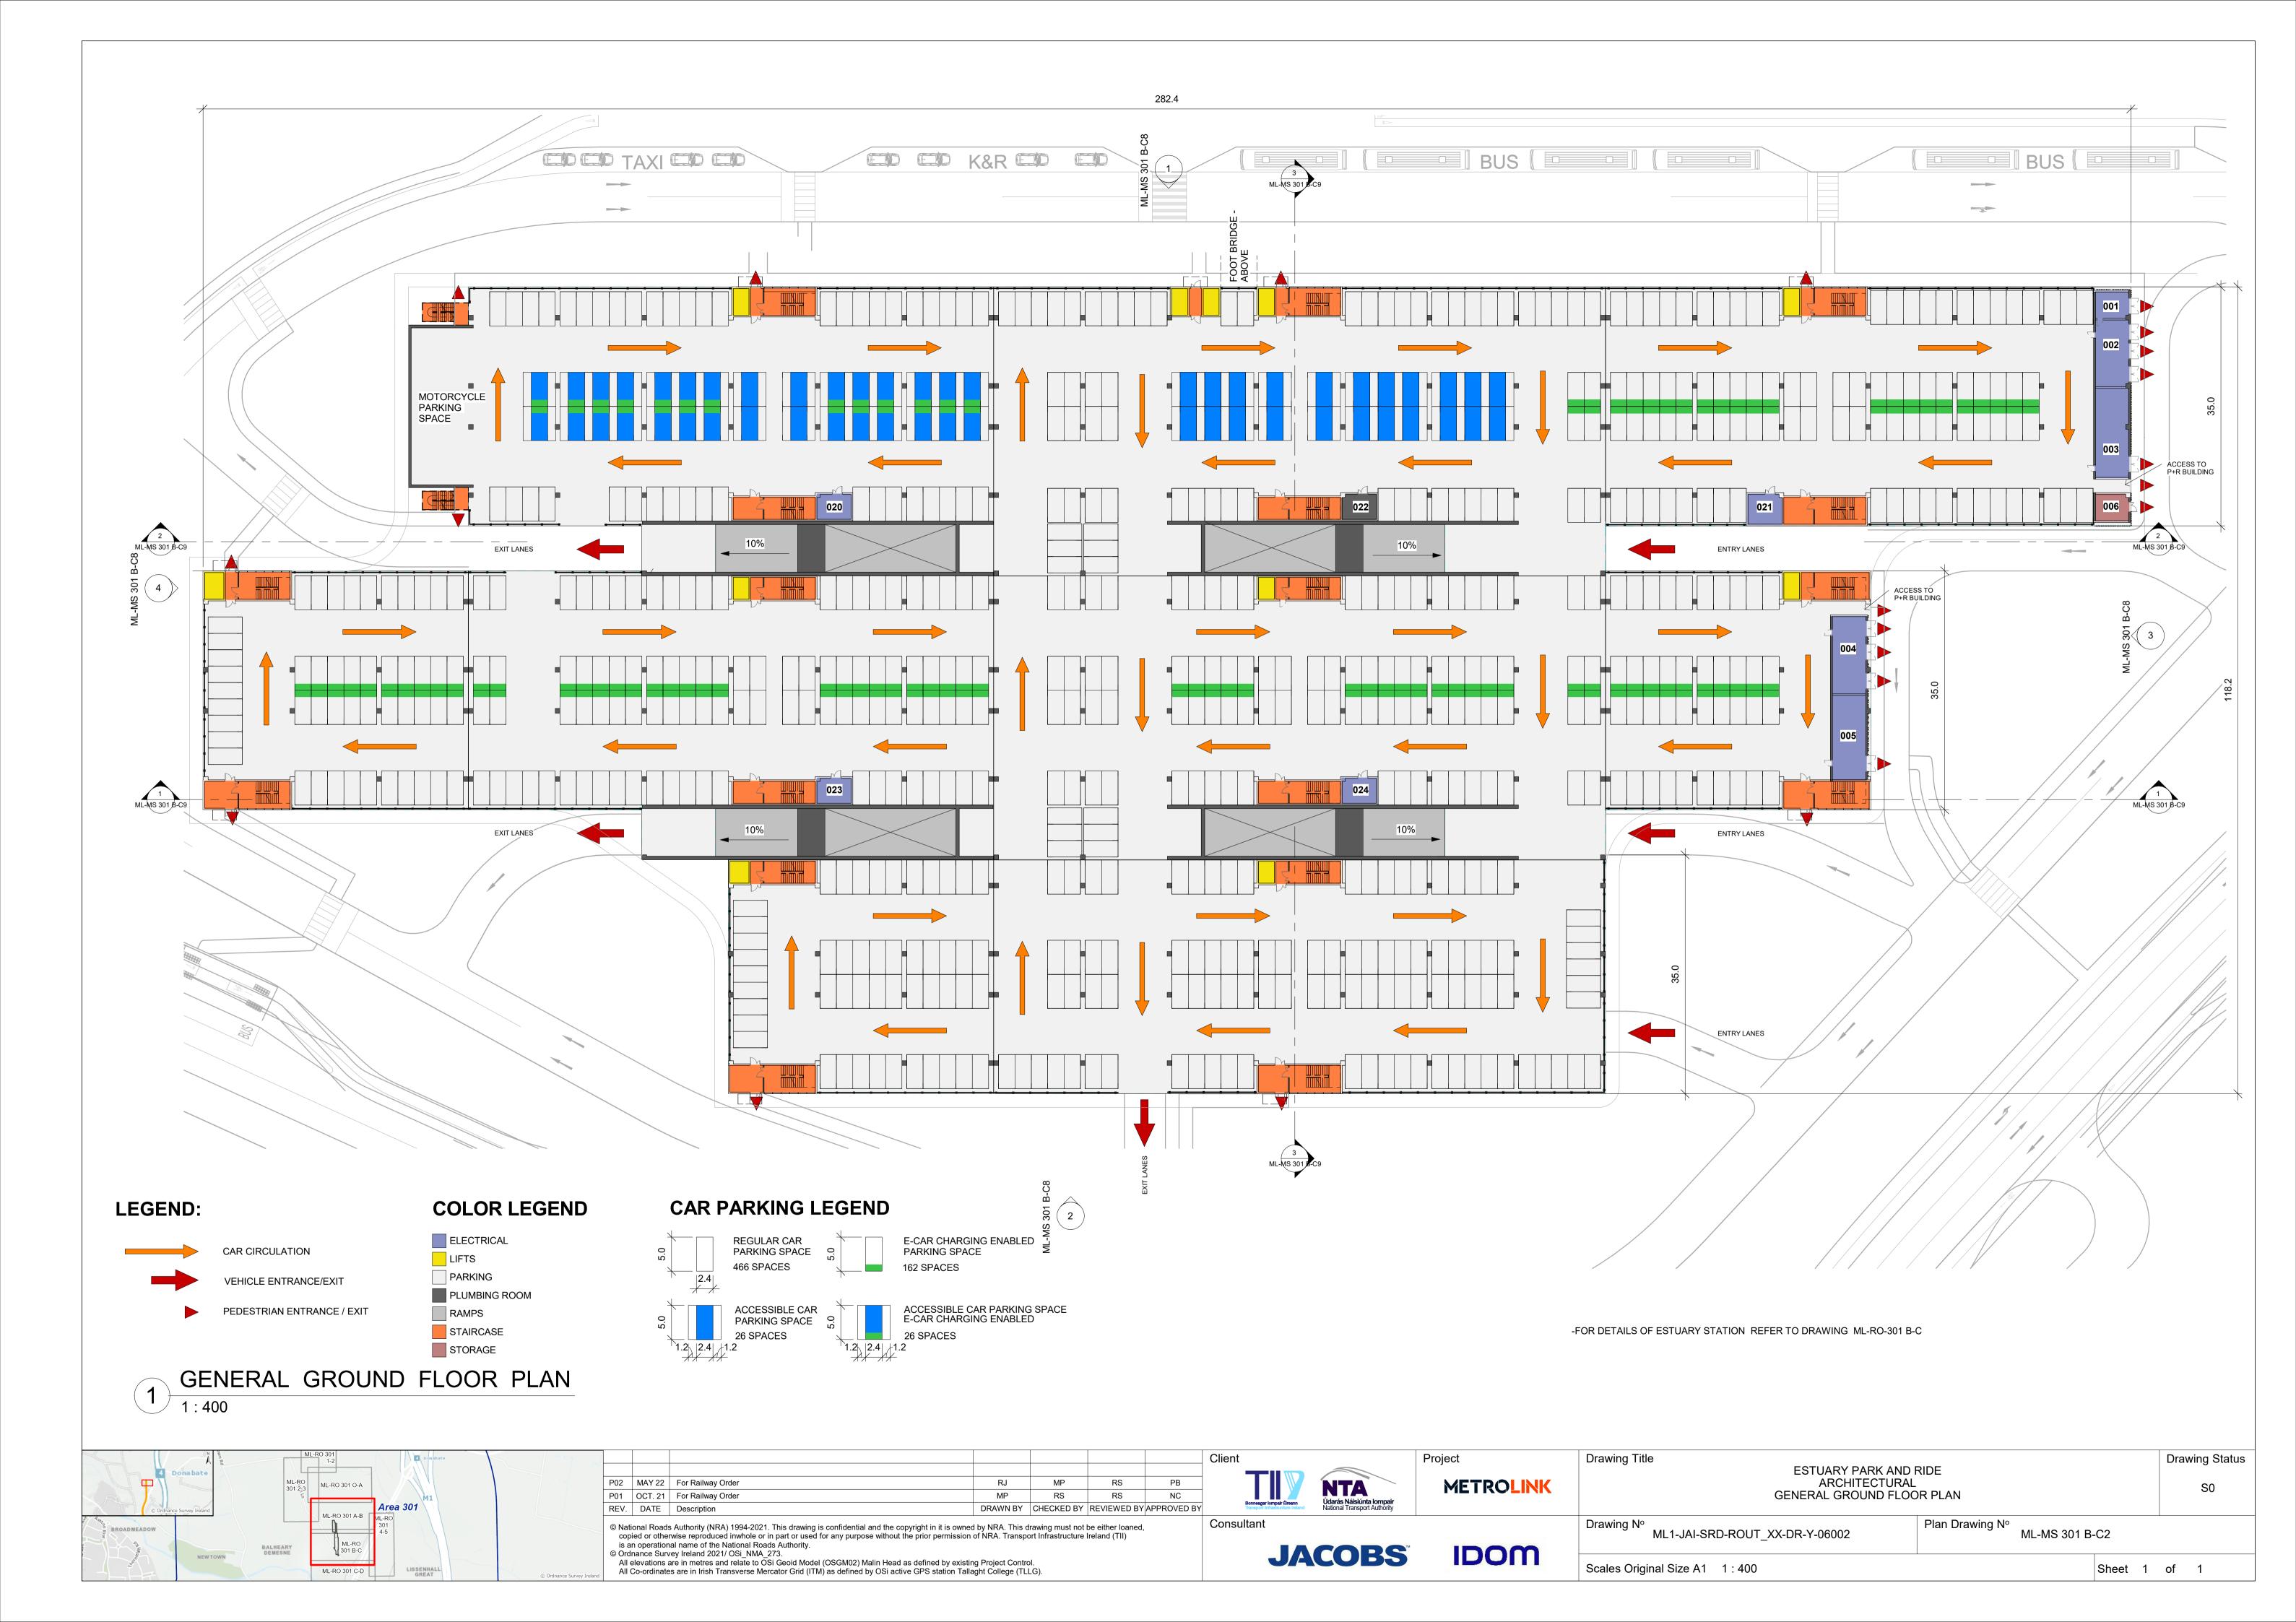


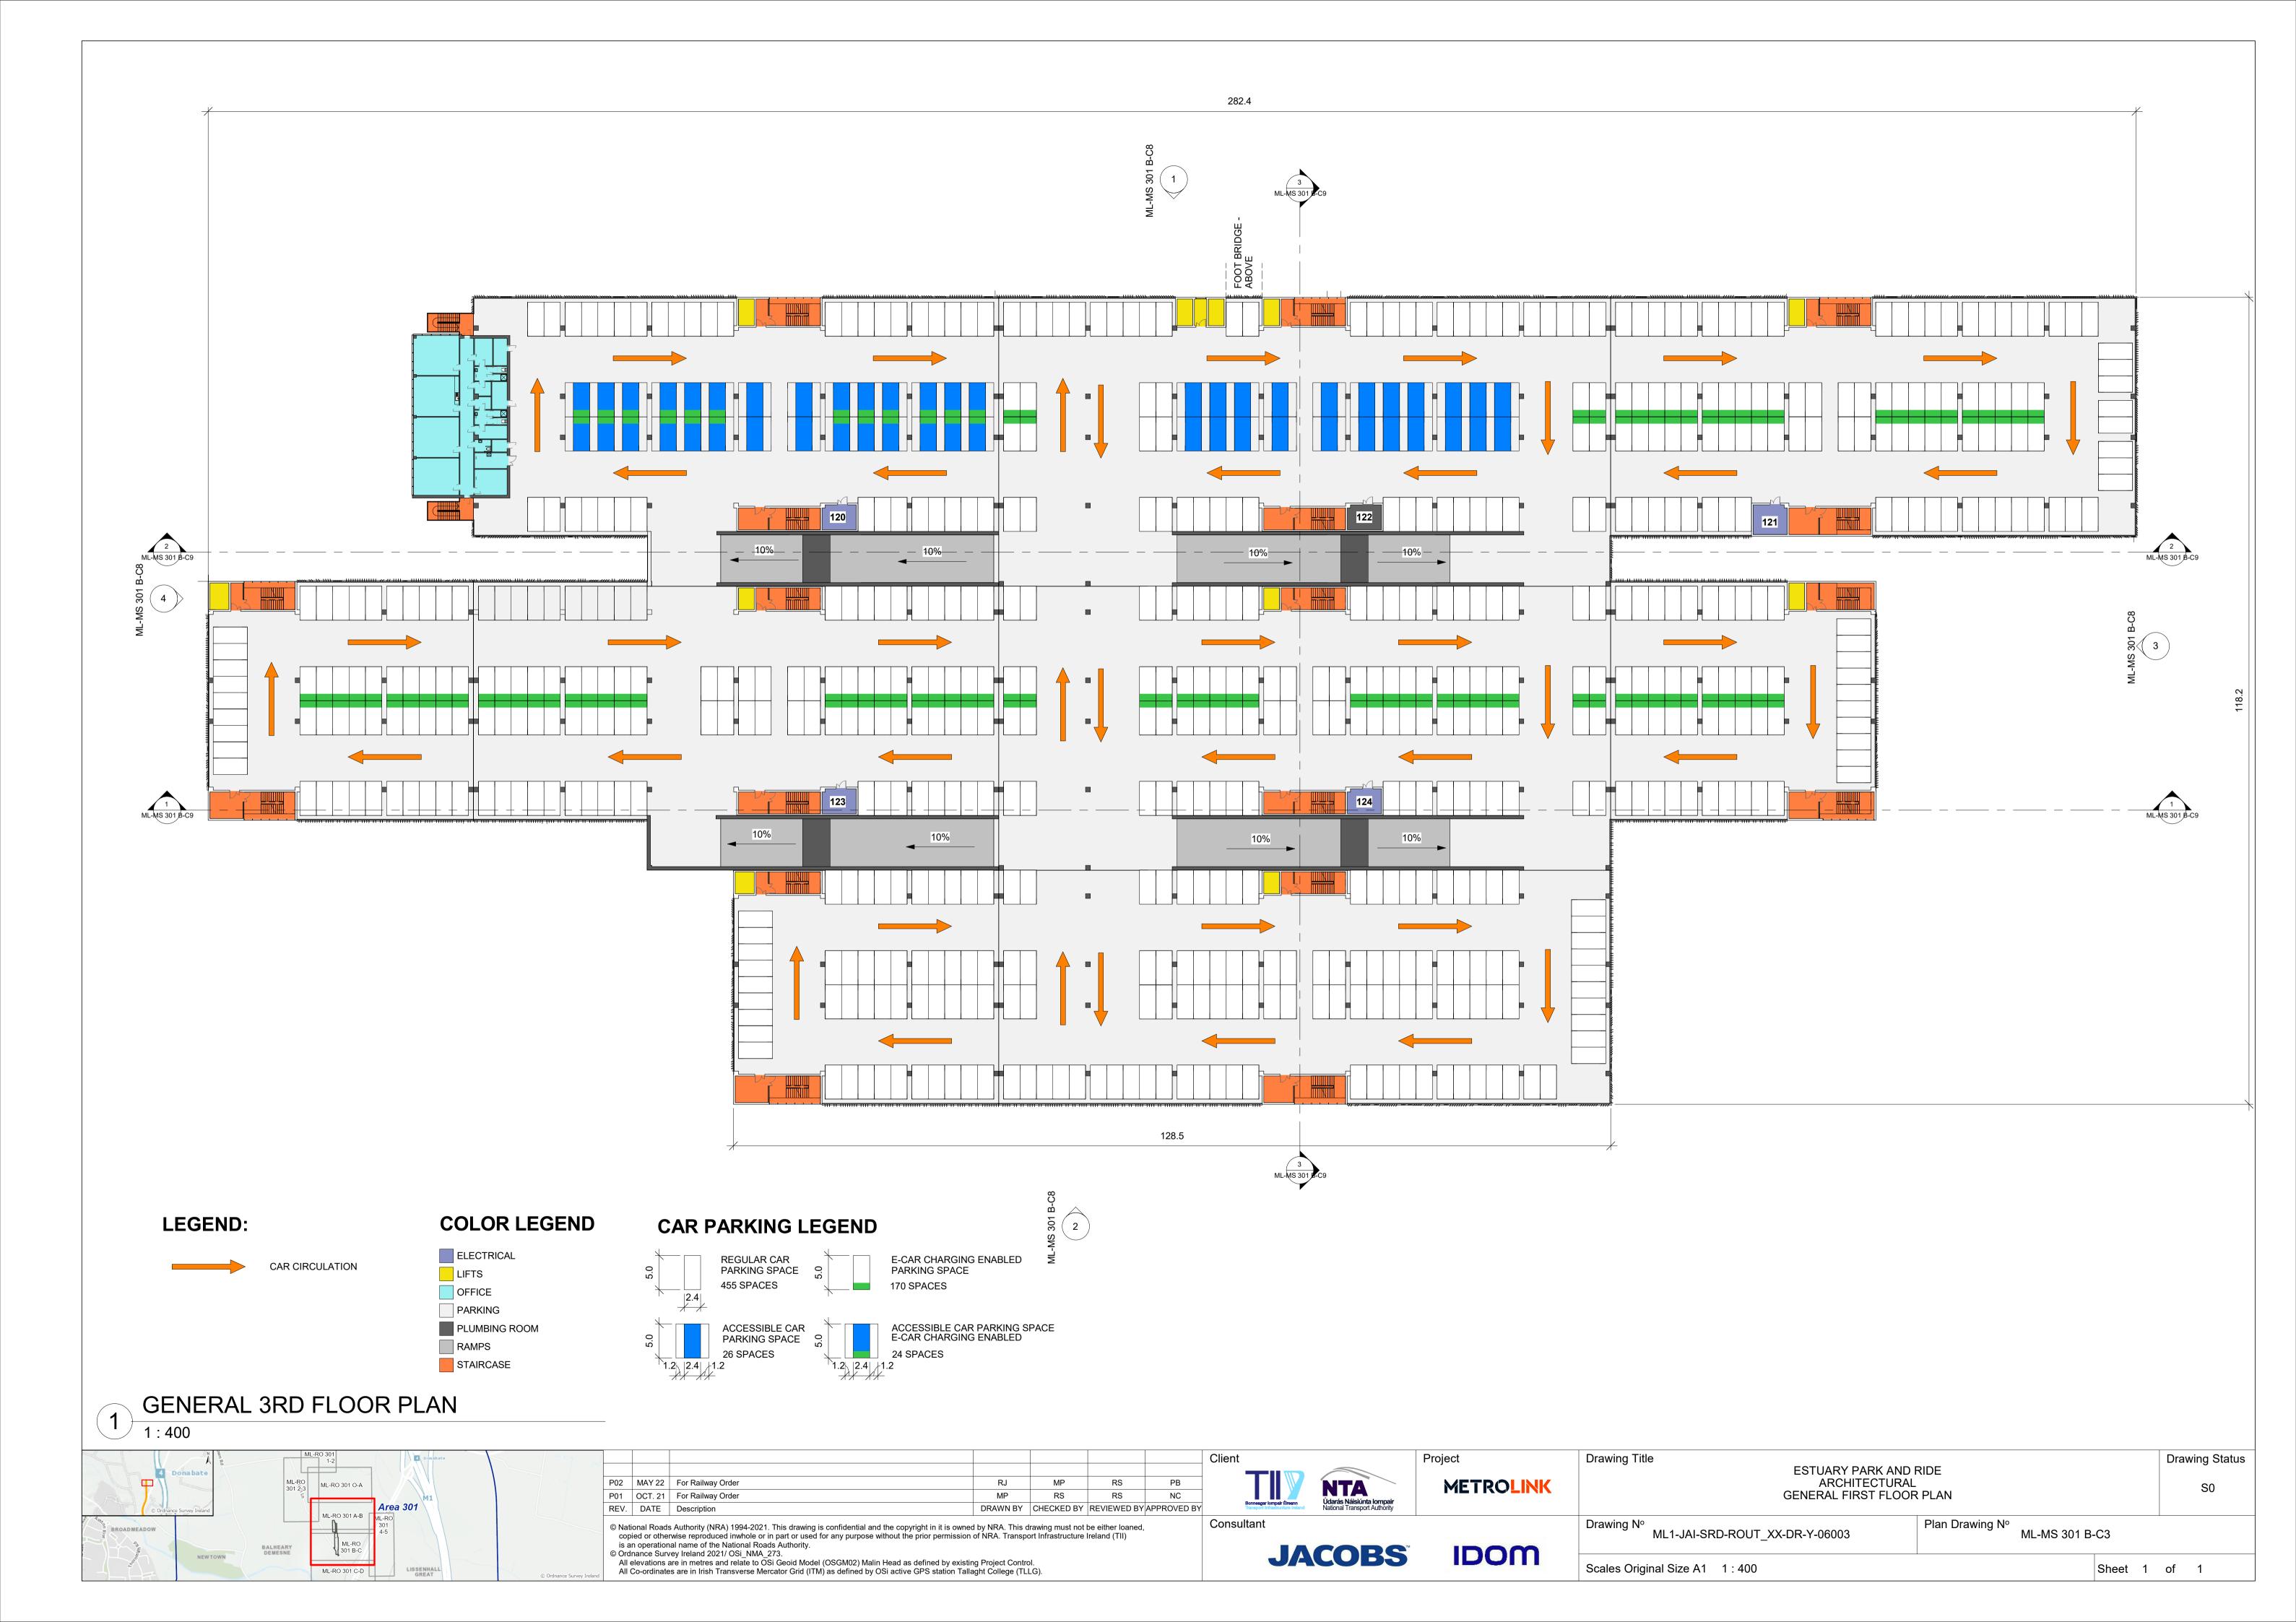

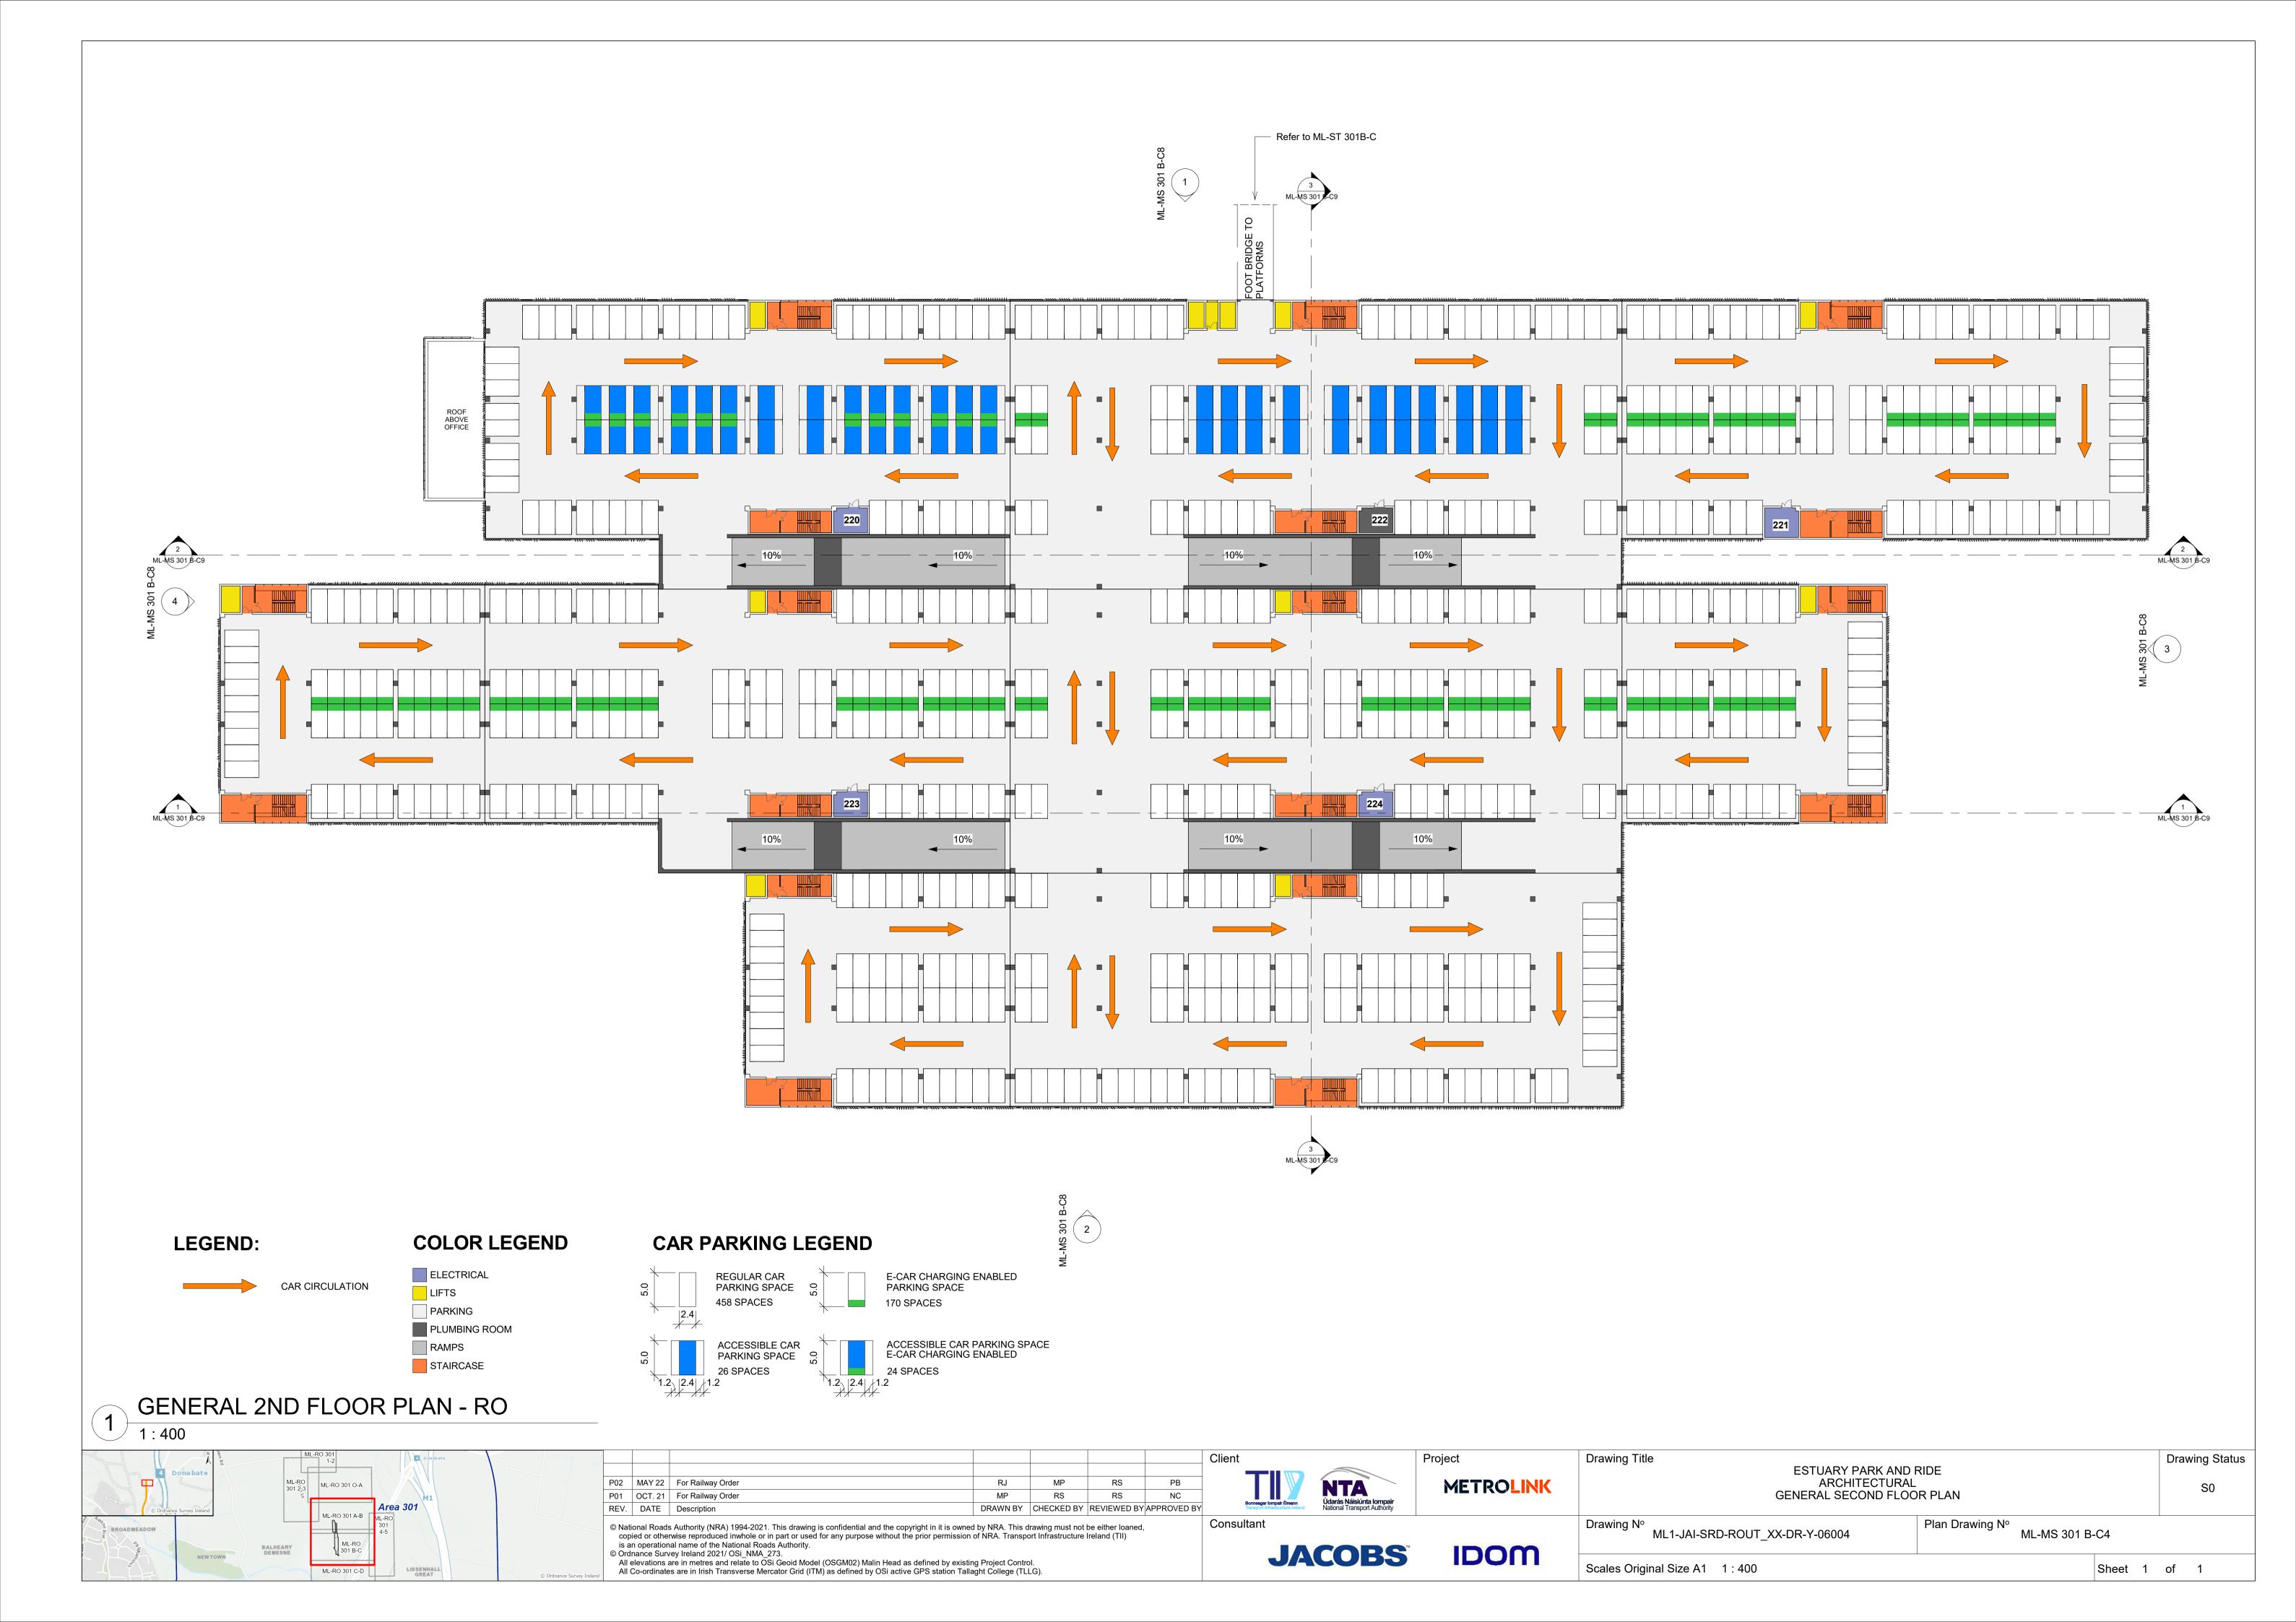

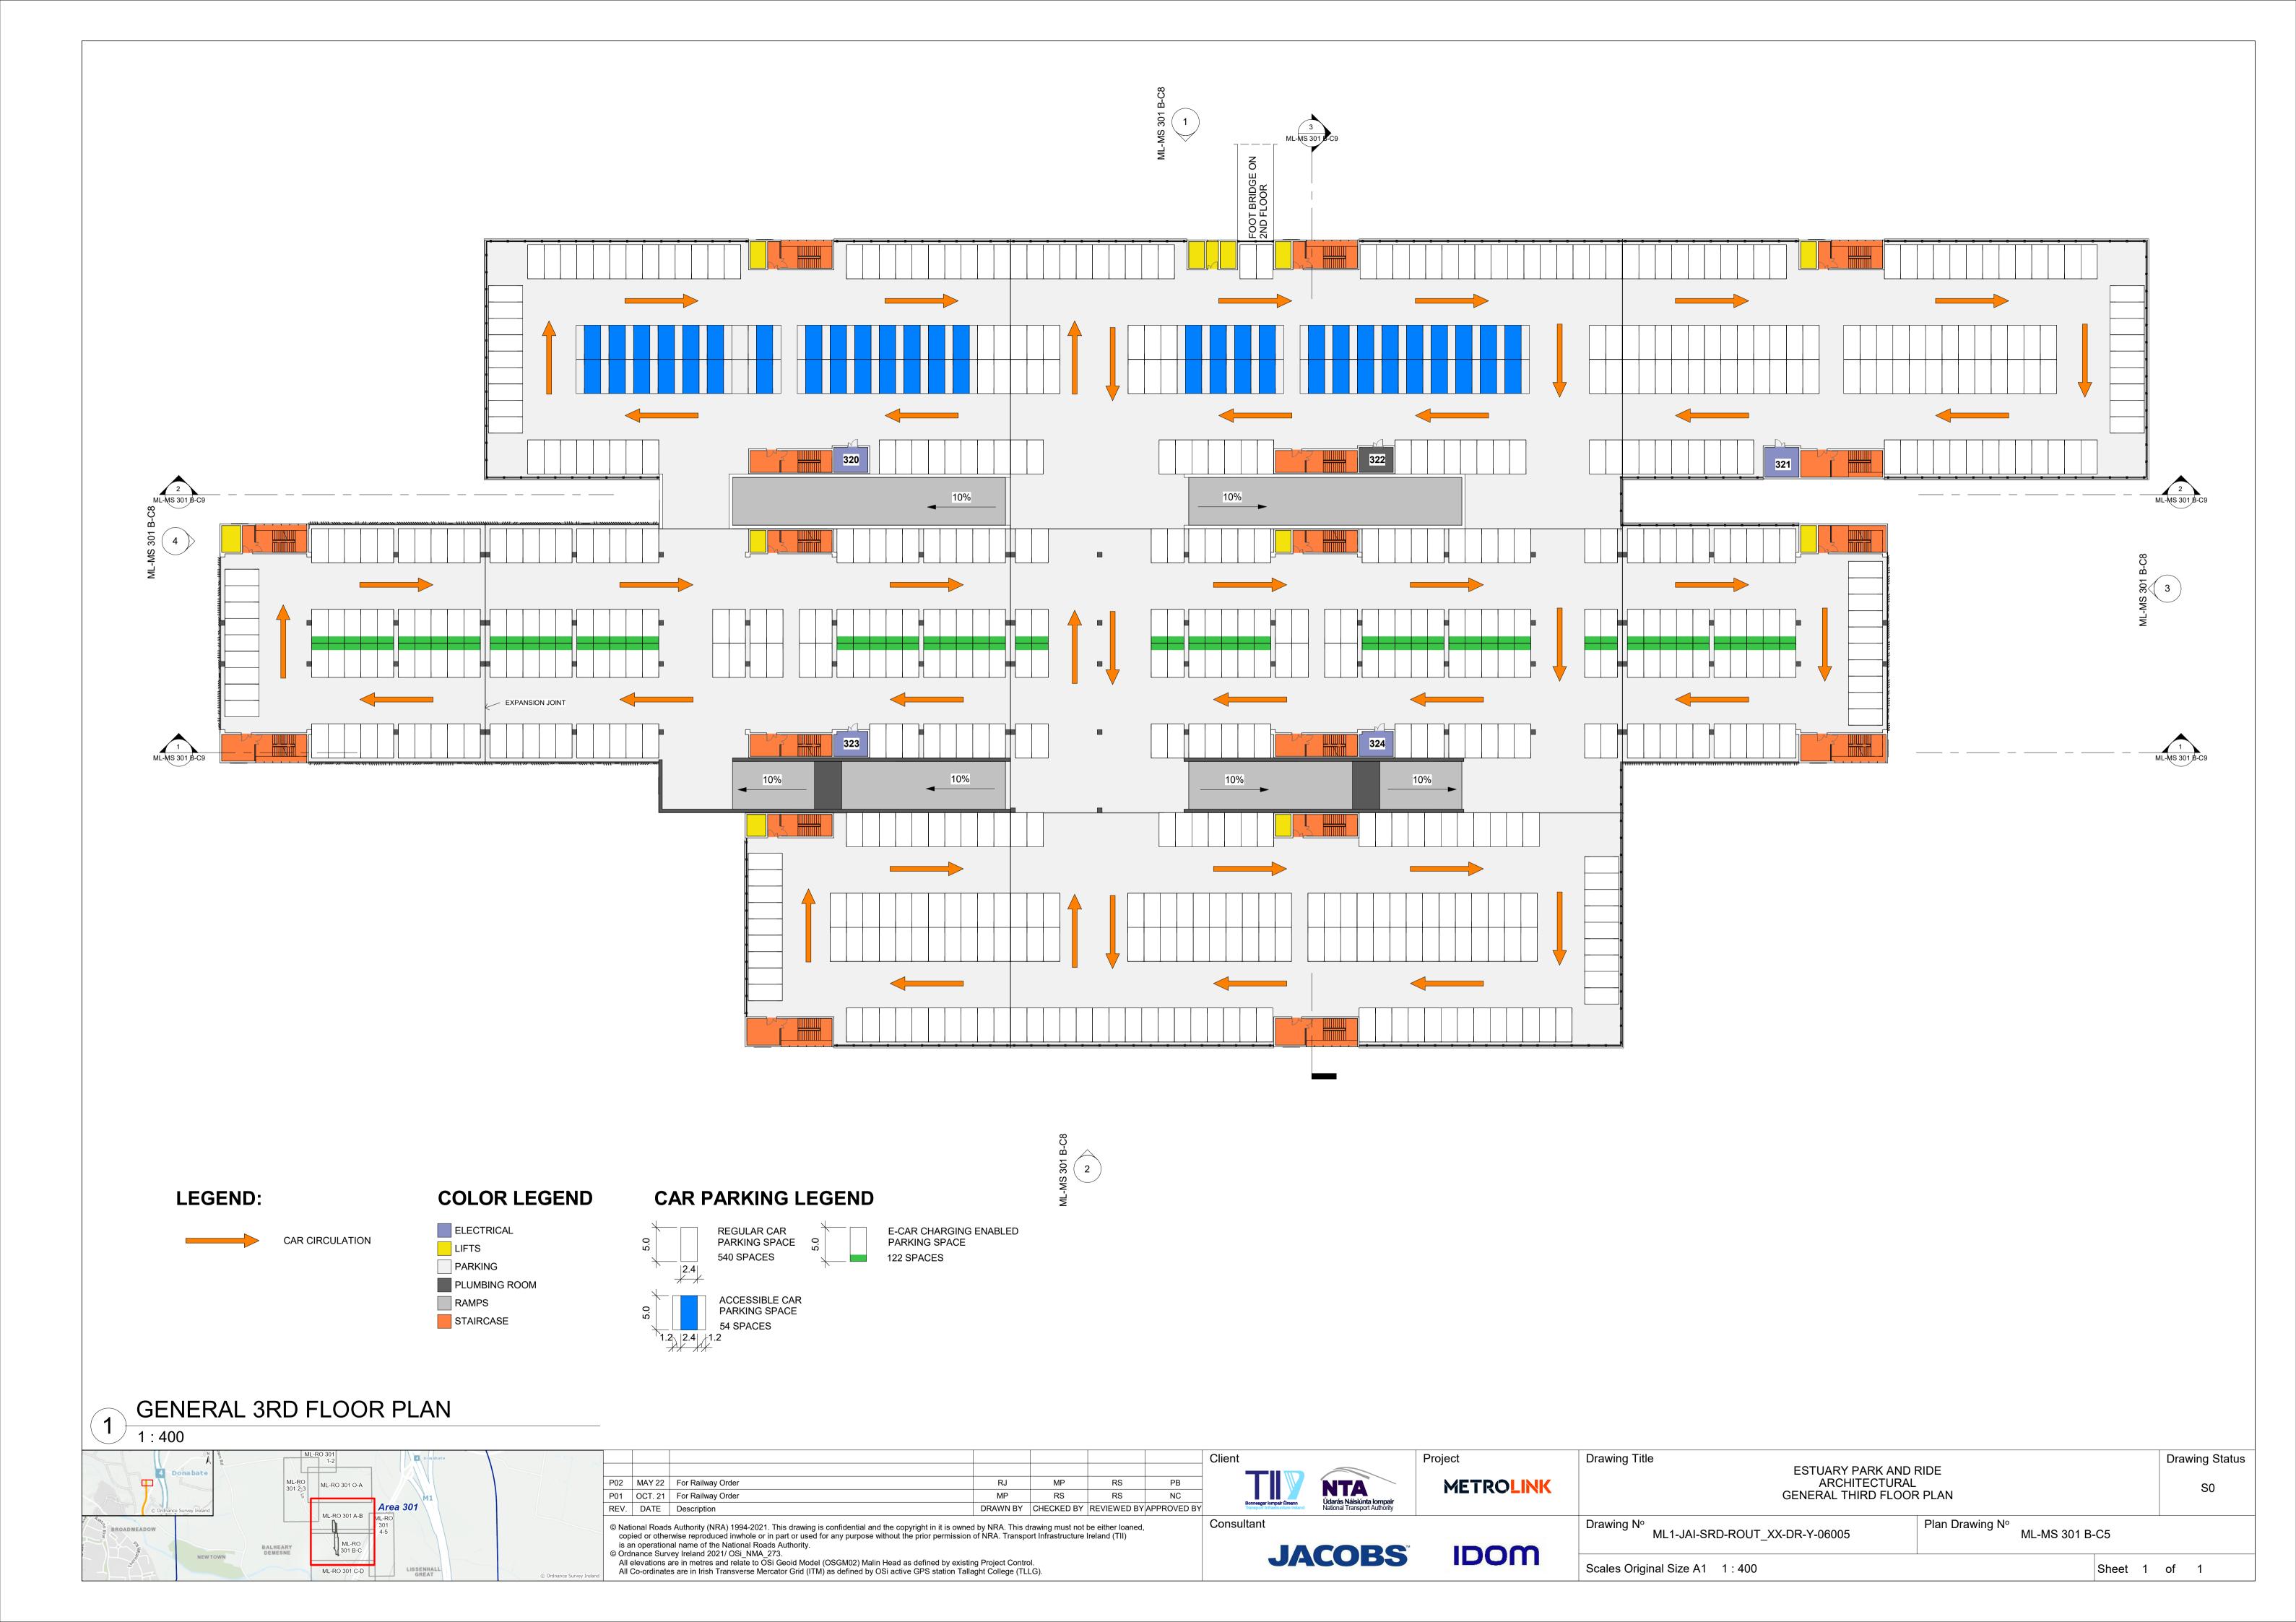

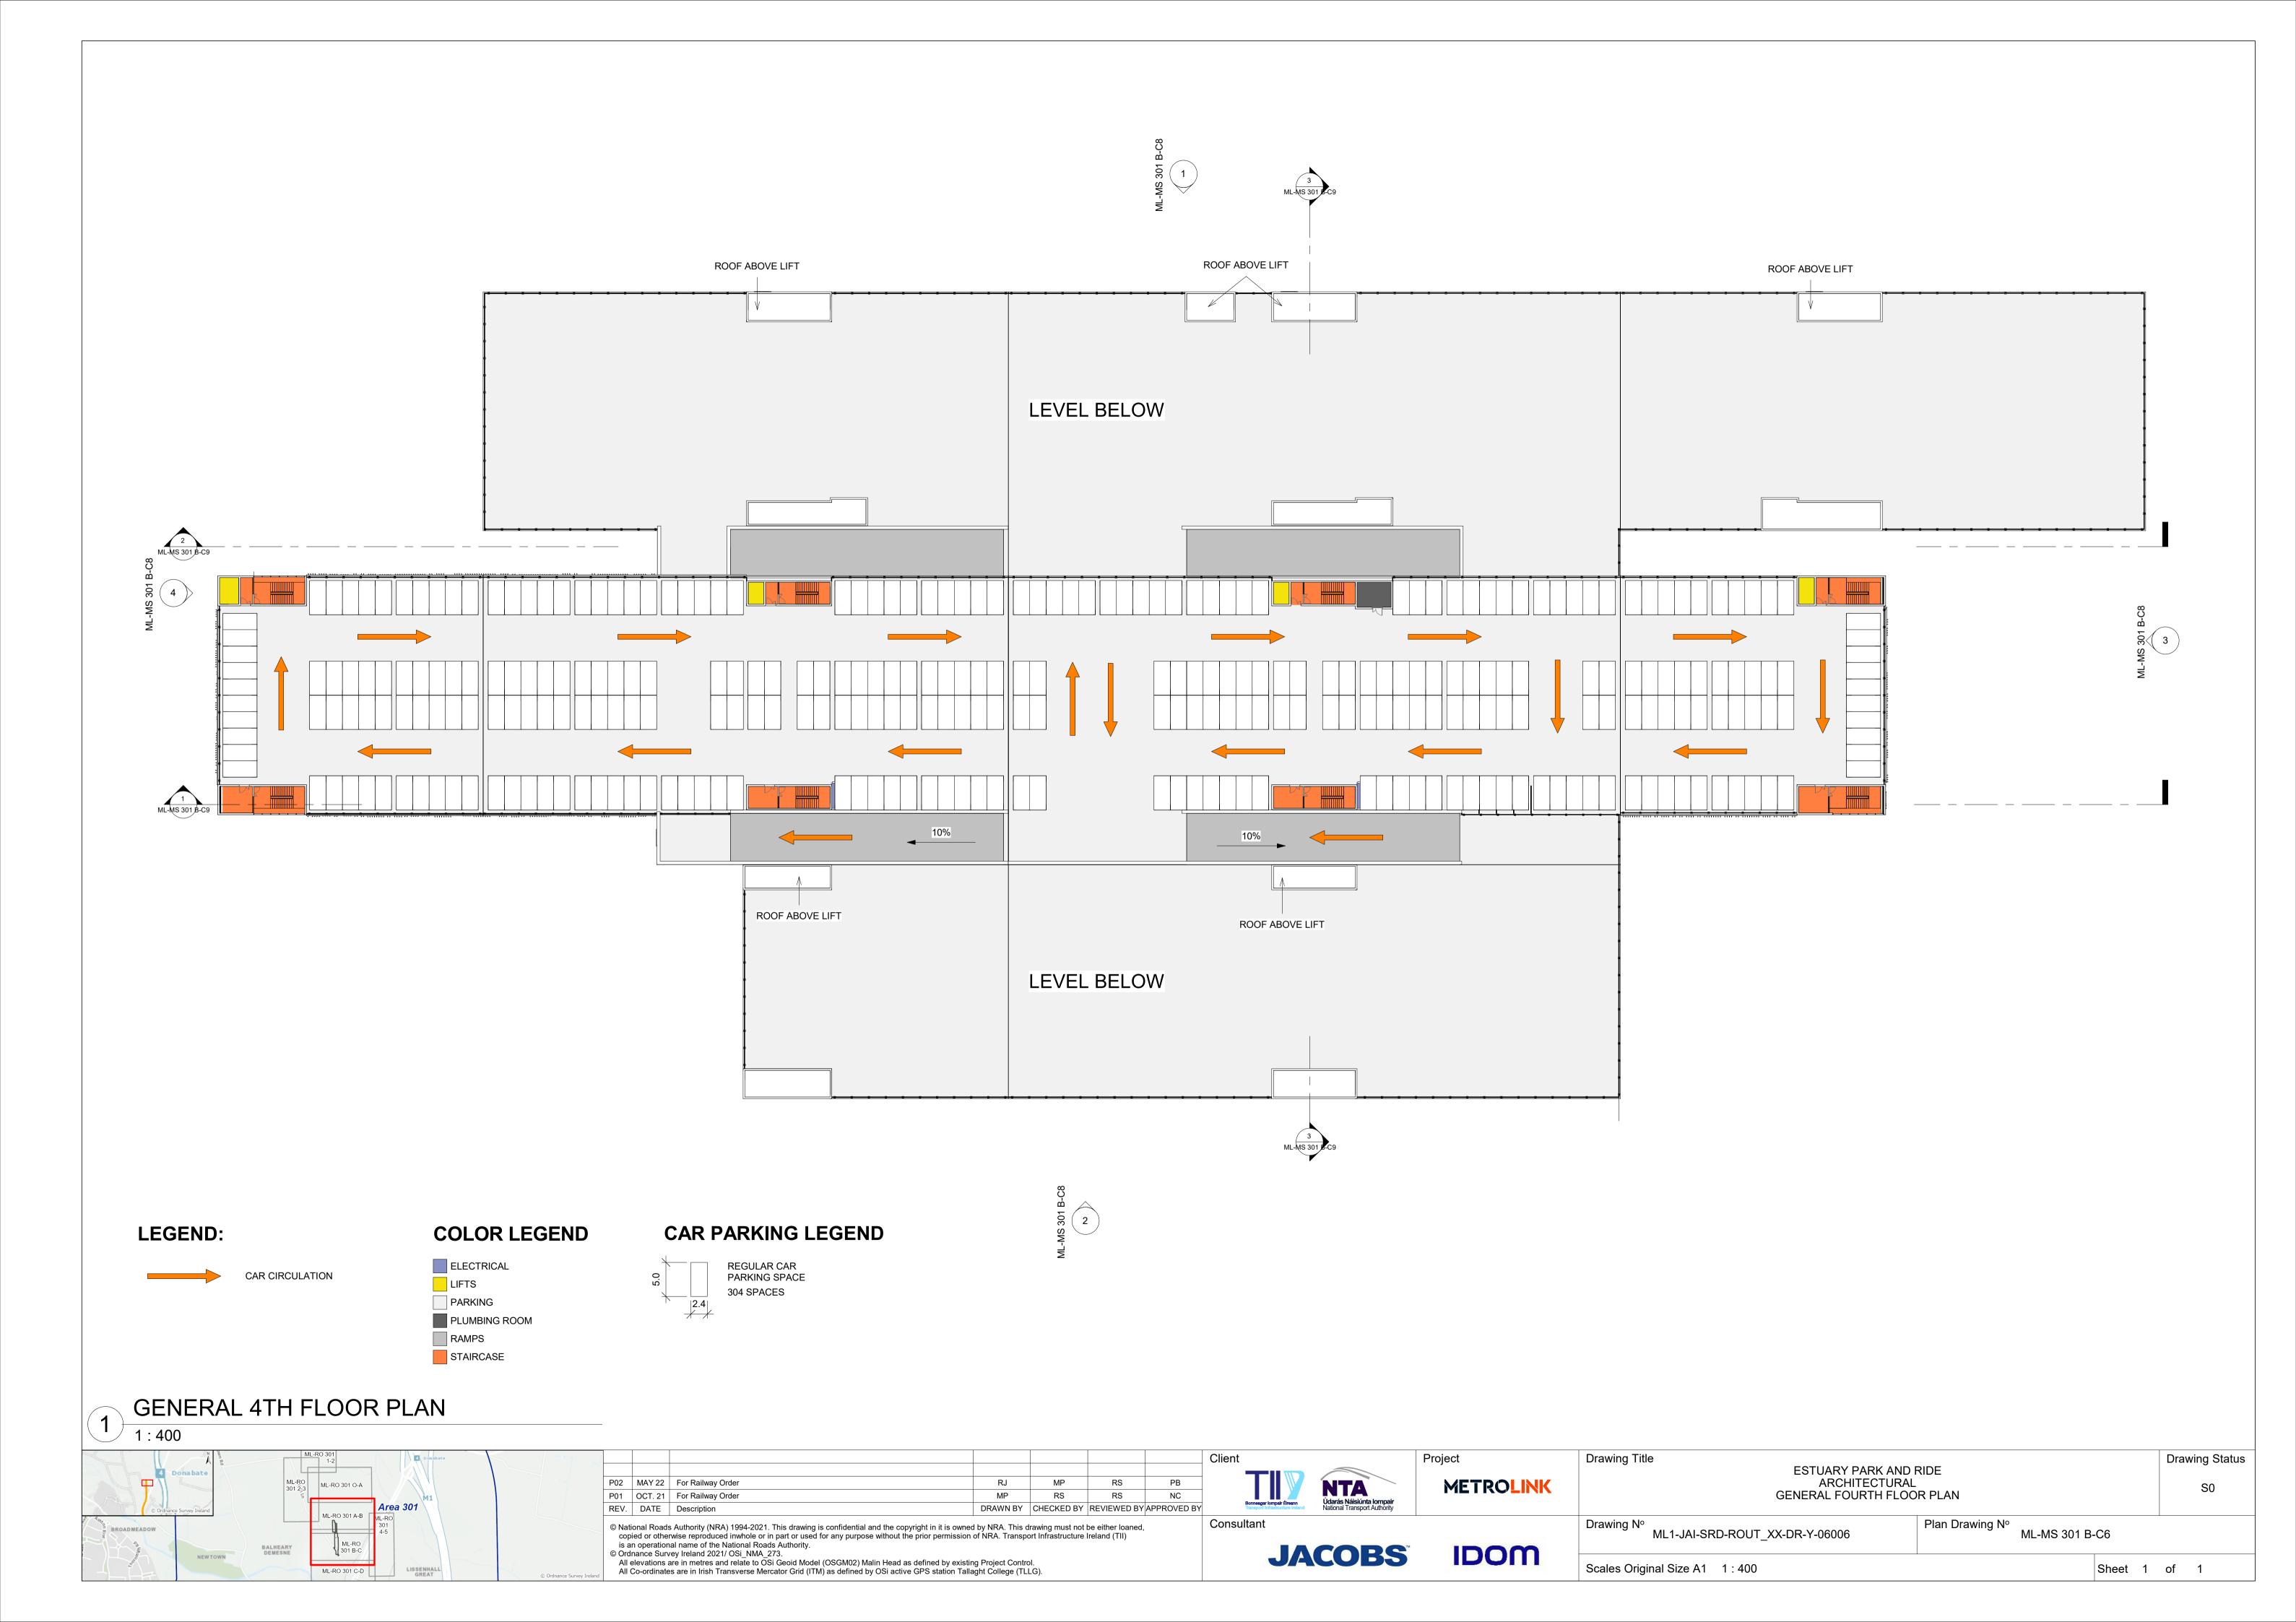


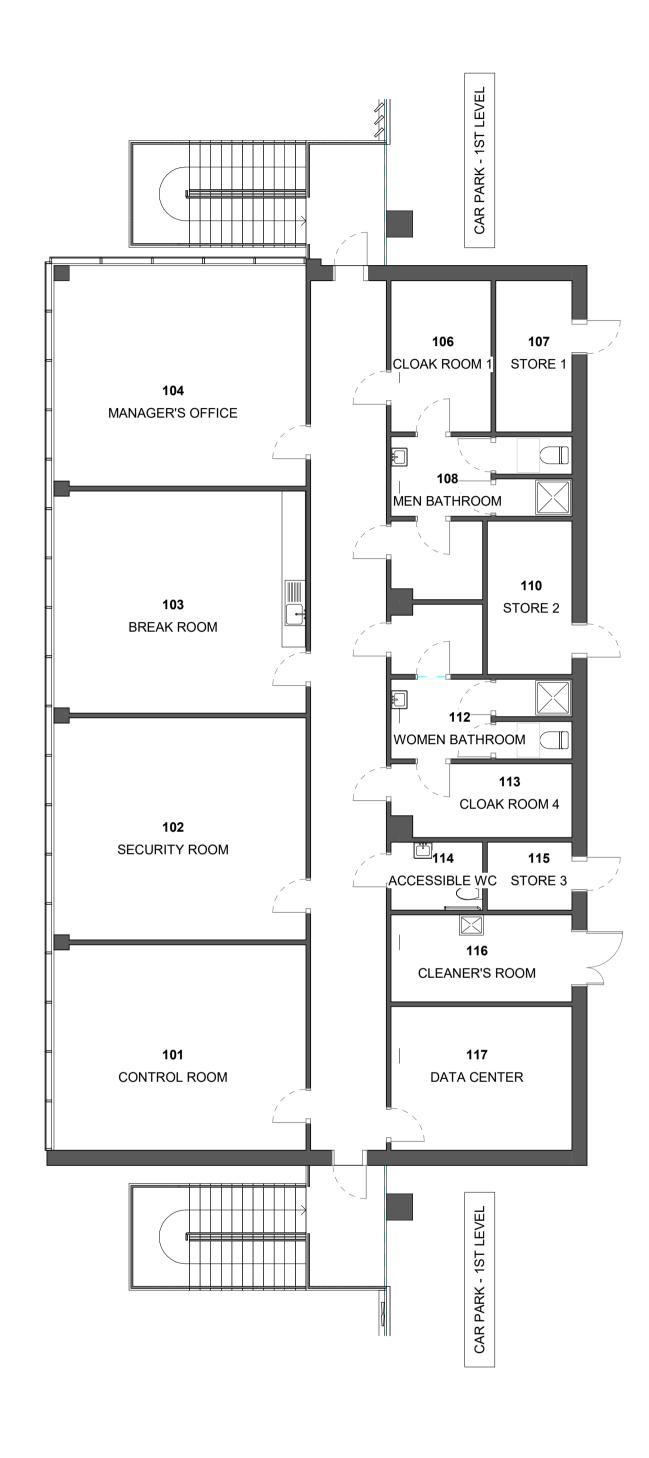


OFFICE AREA ENLARGED PLAN
1: 100


-FOR GENERAL GROUND FLOOR PLAN REFER TO DRAWING NoML-MS 301 B-C2
-FOR GENERAL FIRST FLOOR PLAN REFER TO DRAWING NoML-MS 301 B-C3
-FOR GENERAL SECOND FLOOR PLAN REFER TO DRAWING NoML-MS 301 B-C4
-FOR GENERAL THIRD FLOOR PLAN REFER TO DRAWING NoML-MS 301 B-C5
-FOR GENERAL FOURTH FLOOR PLAN REFER TO DRAWING NoML-MS 301 B-C6

ML-RO 301 1-2 Donabate					Client		Project	Drawing Title		Drawing Status
ML-RO 301 O-A	P02 MAY 22 For Railway Order	RJ MP	P R	RS PB	_ 7	NTA	METROLINK	ESTUARY PARK AND ARCHITECTURA	AL .	S0
Area 301	P01 OCT. 21 For Railway Order REV. DATE Description DF	MP RS	S R	RS NC WED BY APPROVED I	Bonne Transp	sager lompair Éireann port infresanuculure Ireland Vidarás Náisiúnta Iompair National Transport Authority	METICOLINI	OFFICE ENLARGED	PLAN	30
ML-RO 301 A-B ML-RO 301 A-B ML-RO 301 A-5 ML-RO 301 A-5 ML-RO 301 B-C	© National Roads Authority (NRA) 1994-2021. This drawing is confidential and the copyright in it is owned by National Roads are reproduced inwhole or in part or used for any purpose without the prior permission of NR is an operational name of the National Roads Authority. © Ordnance Survey Ireland 2021/ OSi NMA 273.	JRA. This drawing mu	ust not be either	r loaned,	Consultar		IDOM	Drawing N° ML1-JAI-SRD-ROUT_XX-DR-Y-06007	Plan Drawing N° ML-MS 301 B-	C7
ML-RO 301 C-D LISSENHALL GREAT © Ordnance Survey Ireland	All elevations are in metres and relate to OSi Geoid Model (OSGM02) Malin Head as defined by existing Properties are in Irish Transverse Mercator Grid (ITM) as defined by OSi active GPS station Tallaght (oject Control. College (TLLG).				JACOB5	IDOM	Scales Original Size A1 As indicated		Sheet 1 of 1

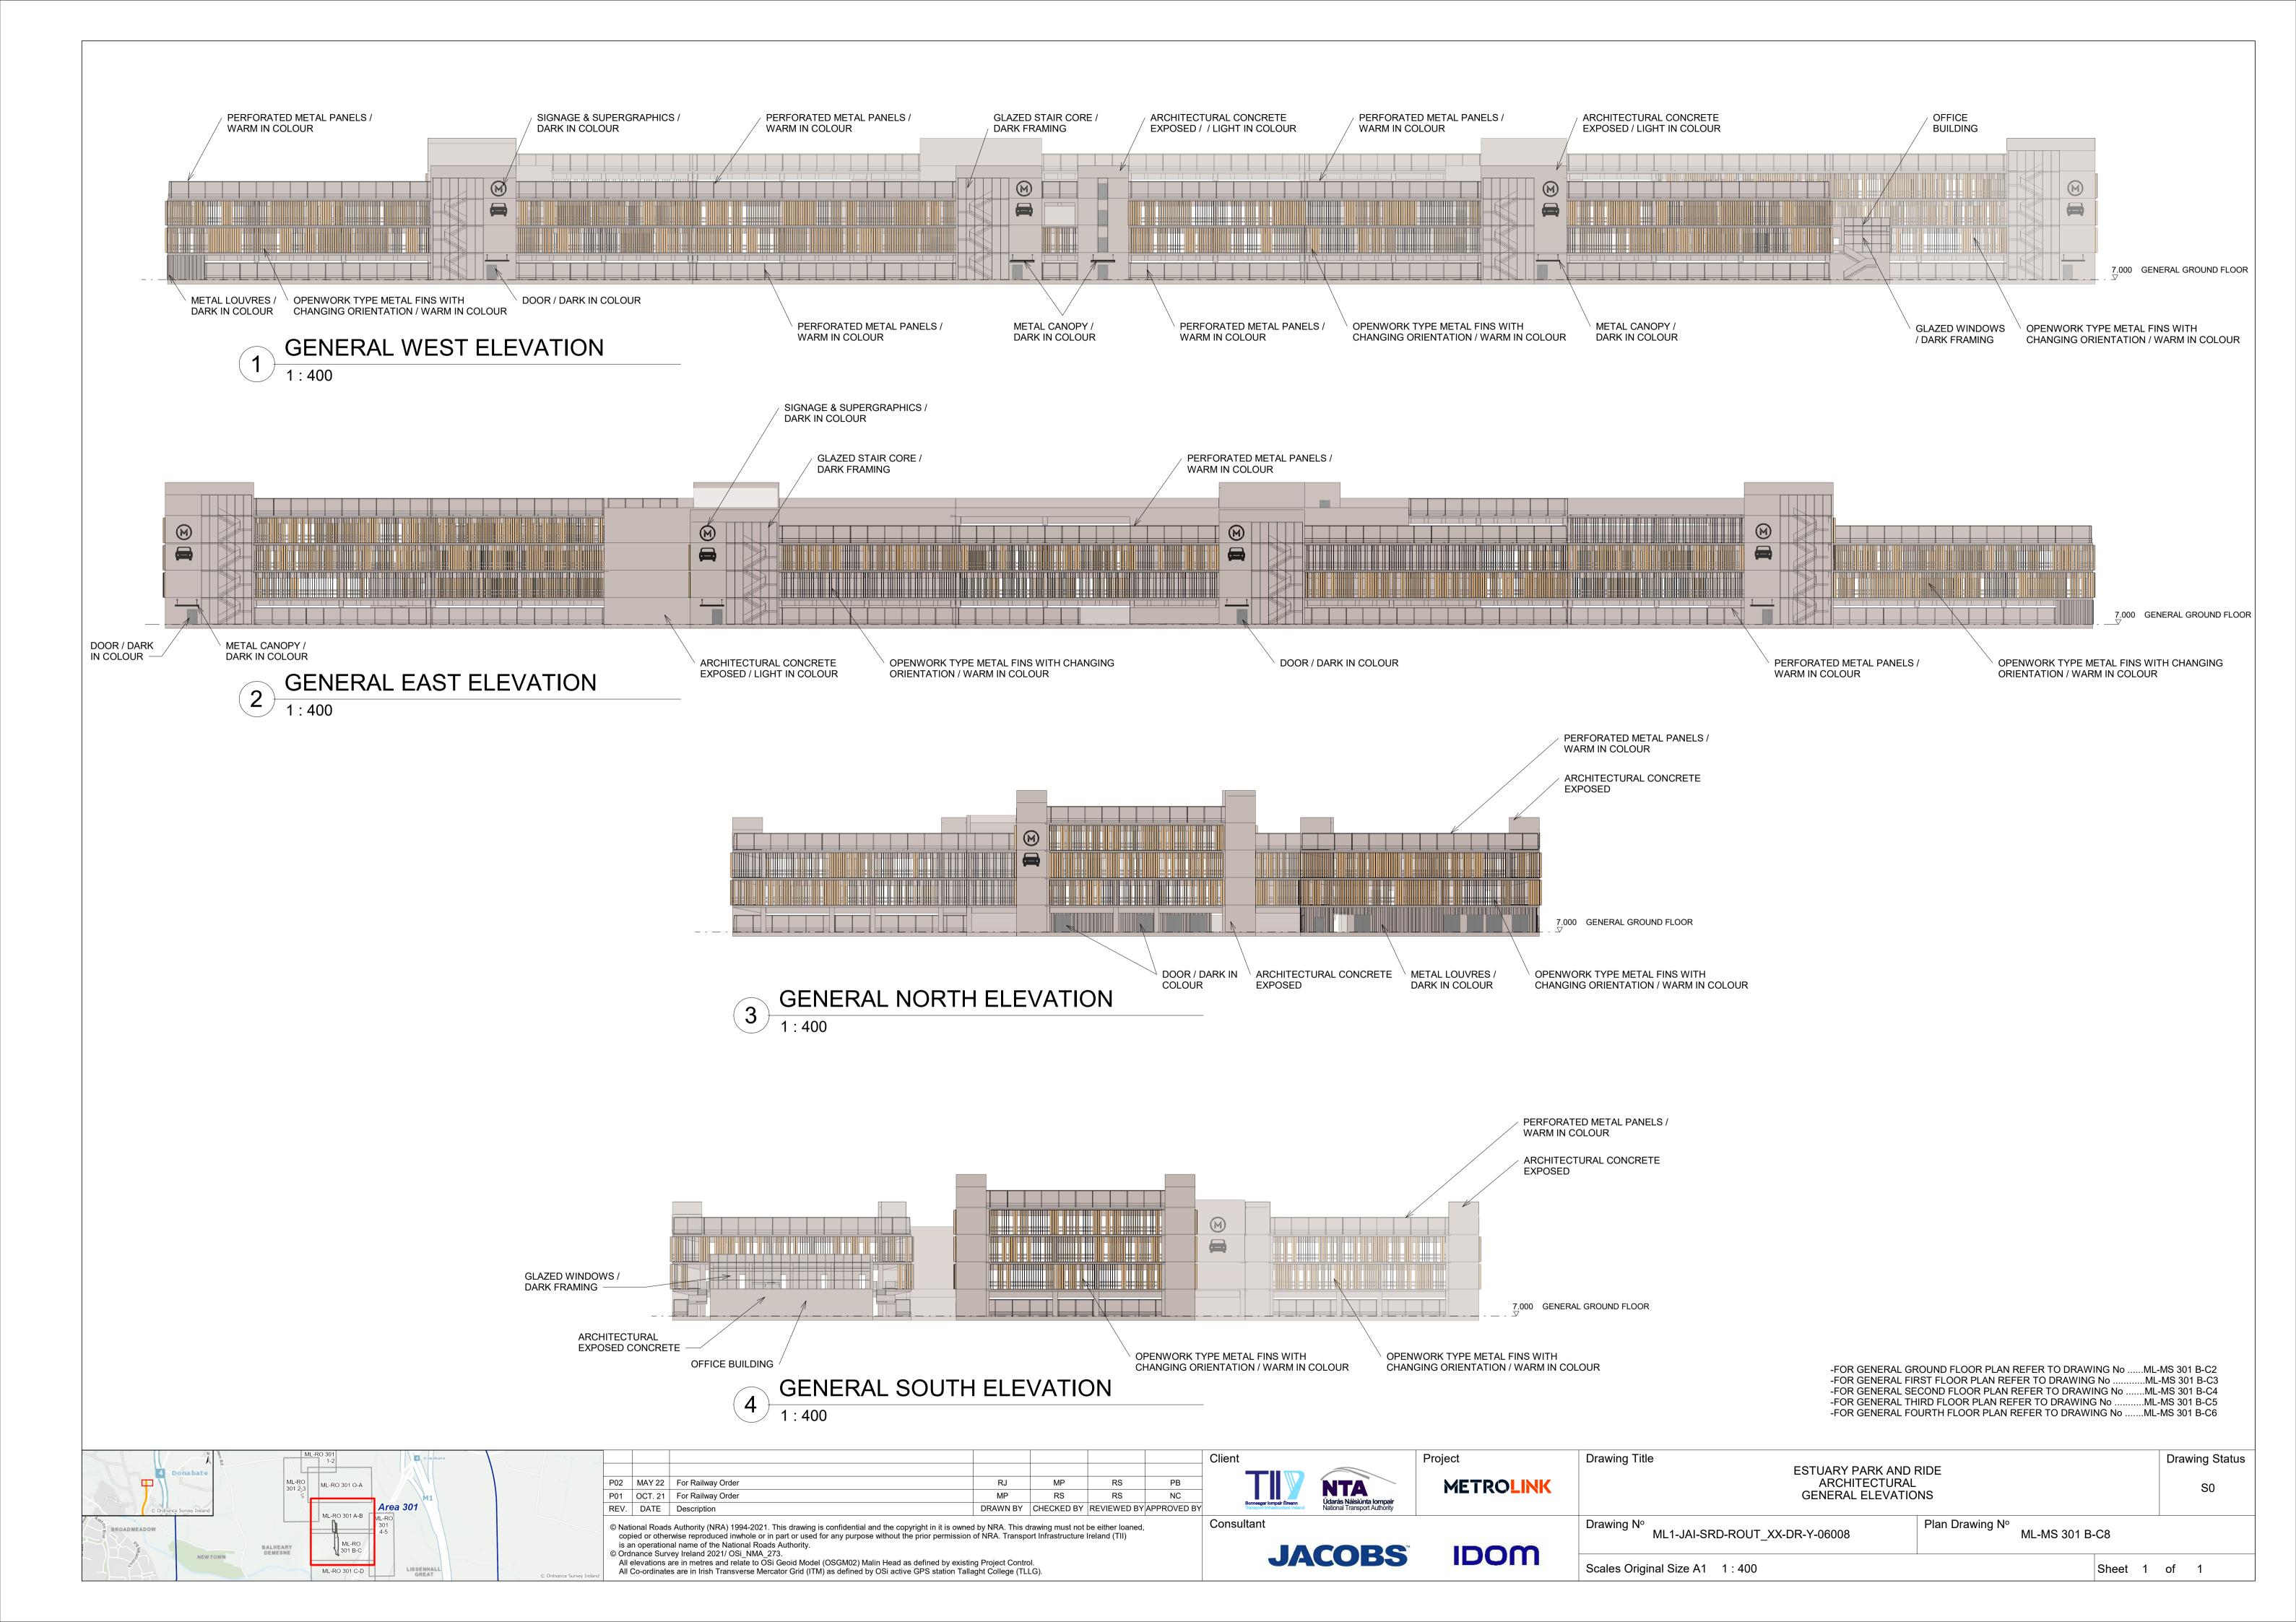


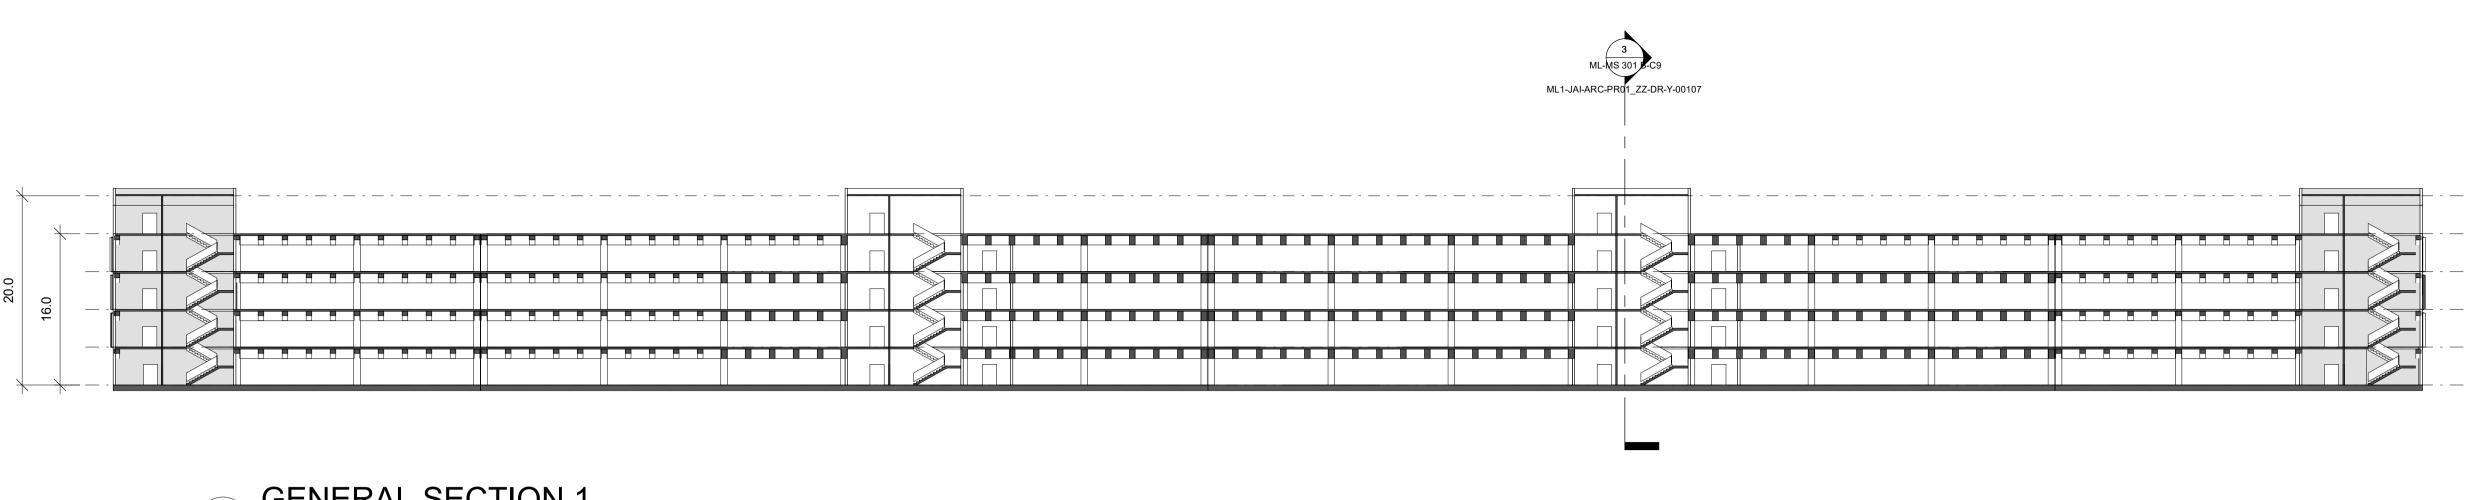

GENERAL SECTION 1
1:400

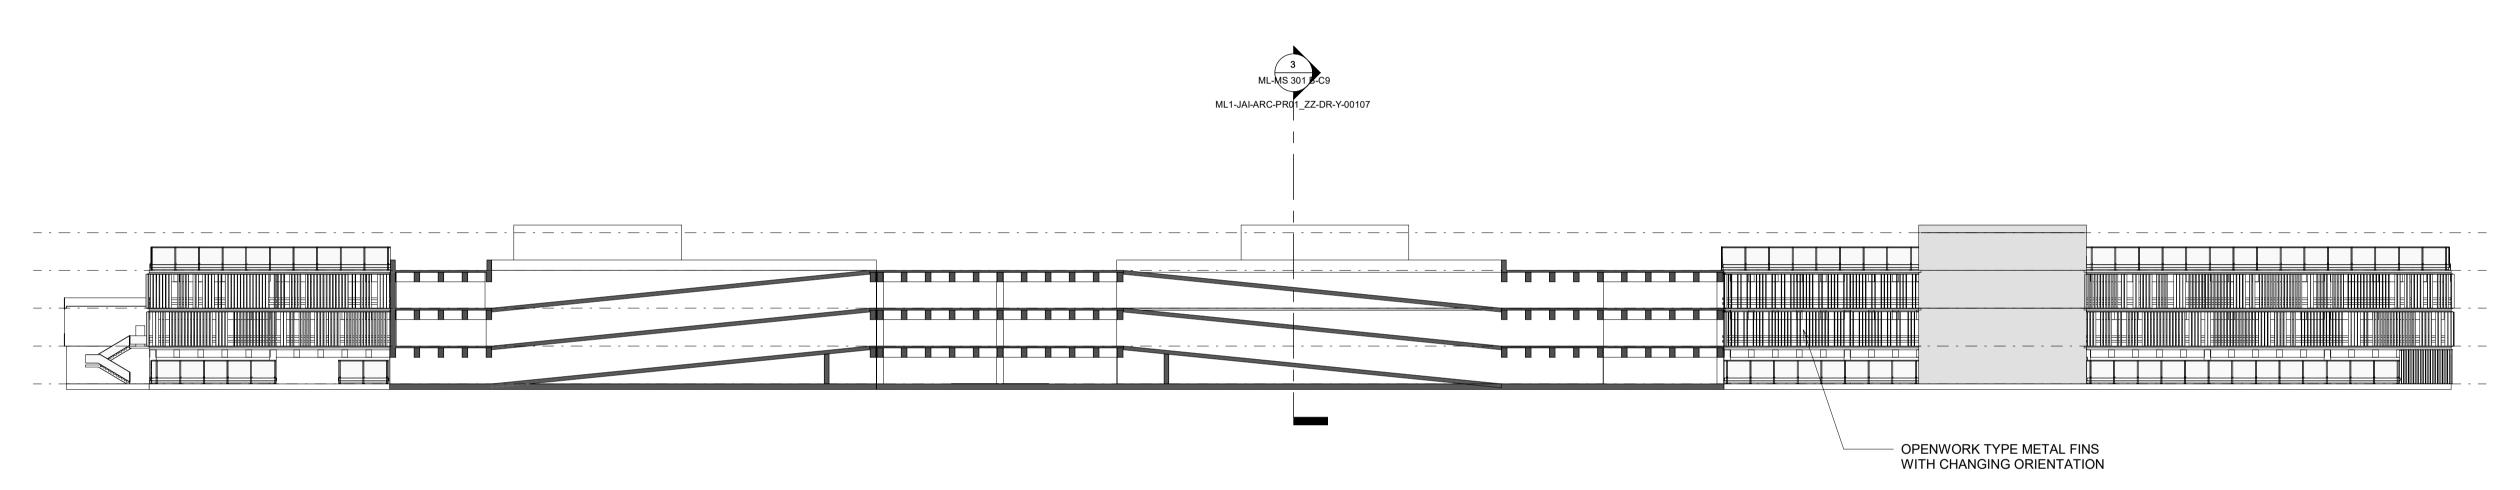

GENERAL SECTION 2

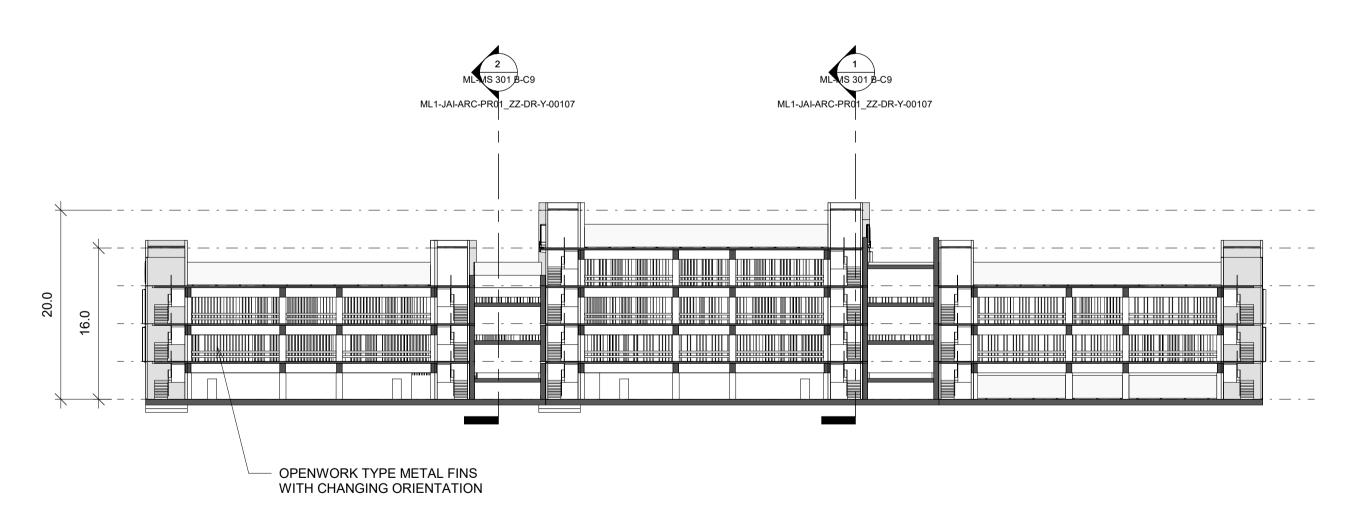


GENERAL SECTION 3


1:400


Drawing Status Drawing Title ESTUARY PARK AND RIDE ARCHITECTURAL Údarás Náisiúnta lompair National Transport Authority **METROLINK** RS PB P02 MAY 22 For Railway Order S0 GENERAL SECTIONS NC P01 OCT. 21 For Railway Order RS RS REV. DATE Description DRAWN BY CHECKED BY REVIEWED BY APPROVED BY Drawing N° ML1-JAI-SRD-ROUT_XX-DR-Y-06009 Plan Drawing Nº Consultant © National Roads Authority (NRA) 1994-2021. This drawing is confidential and the copyright in it is owned by NRA. This drawing must not be either loaned, copied or otherwise reproduced inwhole or in part or used for any purpose without the prior permission of NRA. Transport Infrastructure Ireland (TII) ML-MS 301 B-C9 is an operational name of the National Roads Authority. **JACOBS** IDOM © Ordnance Survey Ireland 2021/ OSi_NMA_273. All elevations are in metres and relate to OSi Geoid Model (OSGM02) Malin Head as defined by existing Project Control. Scales Original Size A1 1 : 400 Sheet 1 of 1 All Co-ordinates are in Irish Transverse Mercator Grid (ITM) as defined by OSi active GPS station Tallaght College (TLLG).


-FOR GENERAL GROUND FLOOR PLAN REFER TO DRAWING NoML-MS 301 B-C2


-FOR GENERAL FIRST FLOOR PLAN REFER TO DRAWING NoML-MS 301 B-C3 -FOR GENERAL SECOND FLOOR PLAN REFER TO DRAWING NoML-MS 301 B-C4 -FOR GENERAL THIRD FLOOR PLAN REFER TO DRAWING NoML-MS 301 B-C5 -FOR GENERAL FOURTH FLOOR PLAN REFER TO DRAWING NoML-MS 301 B-C6

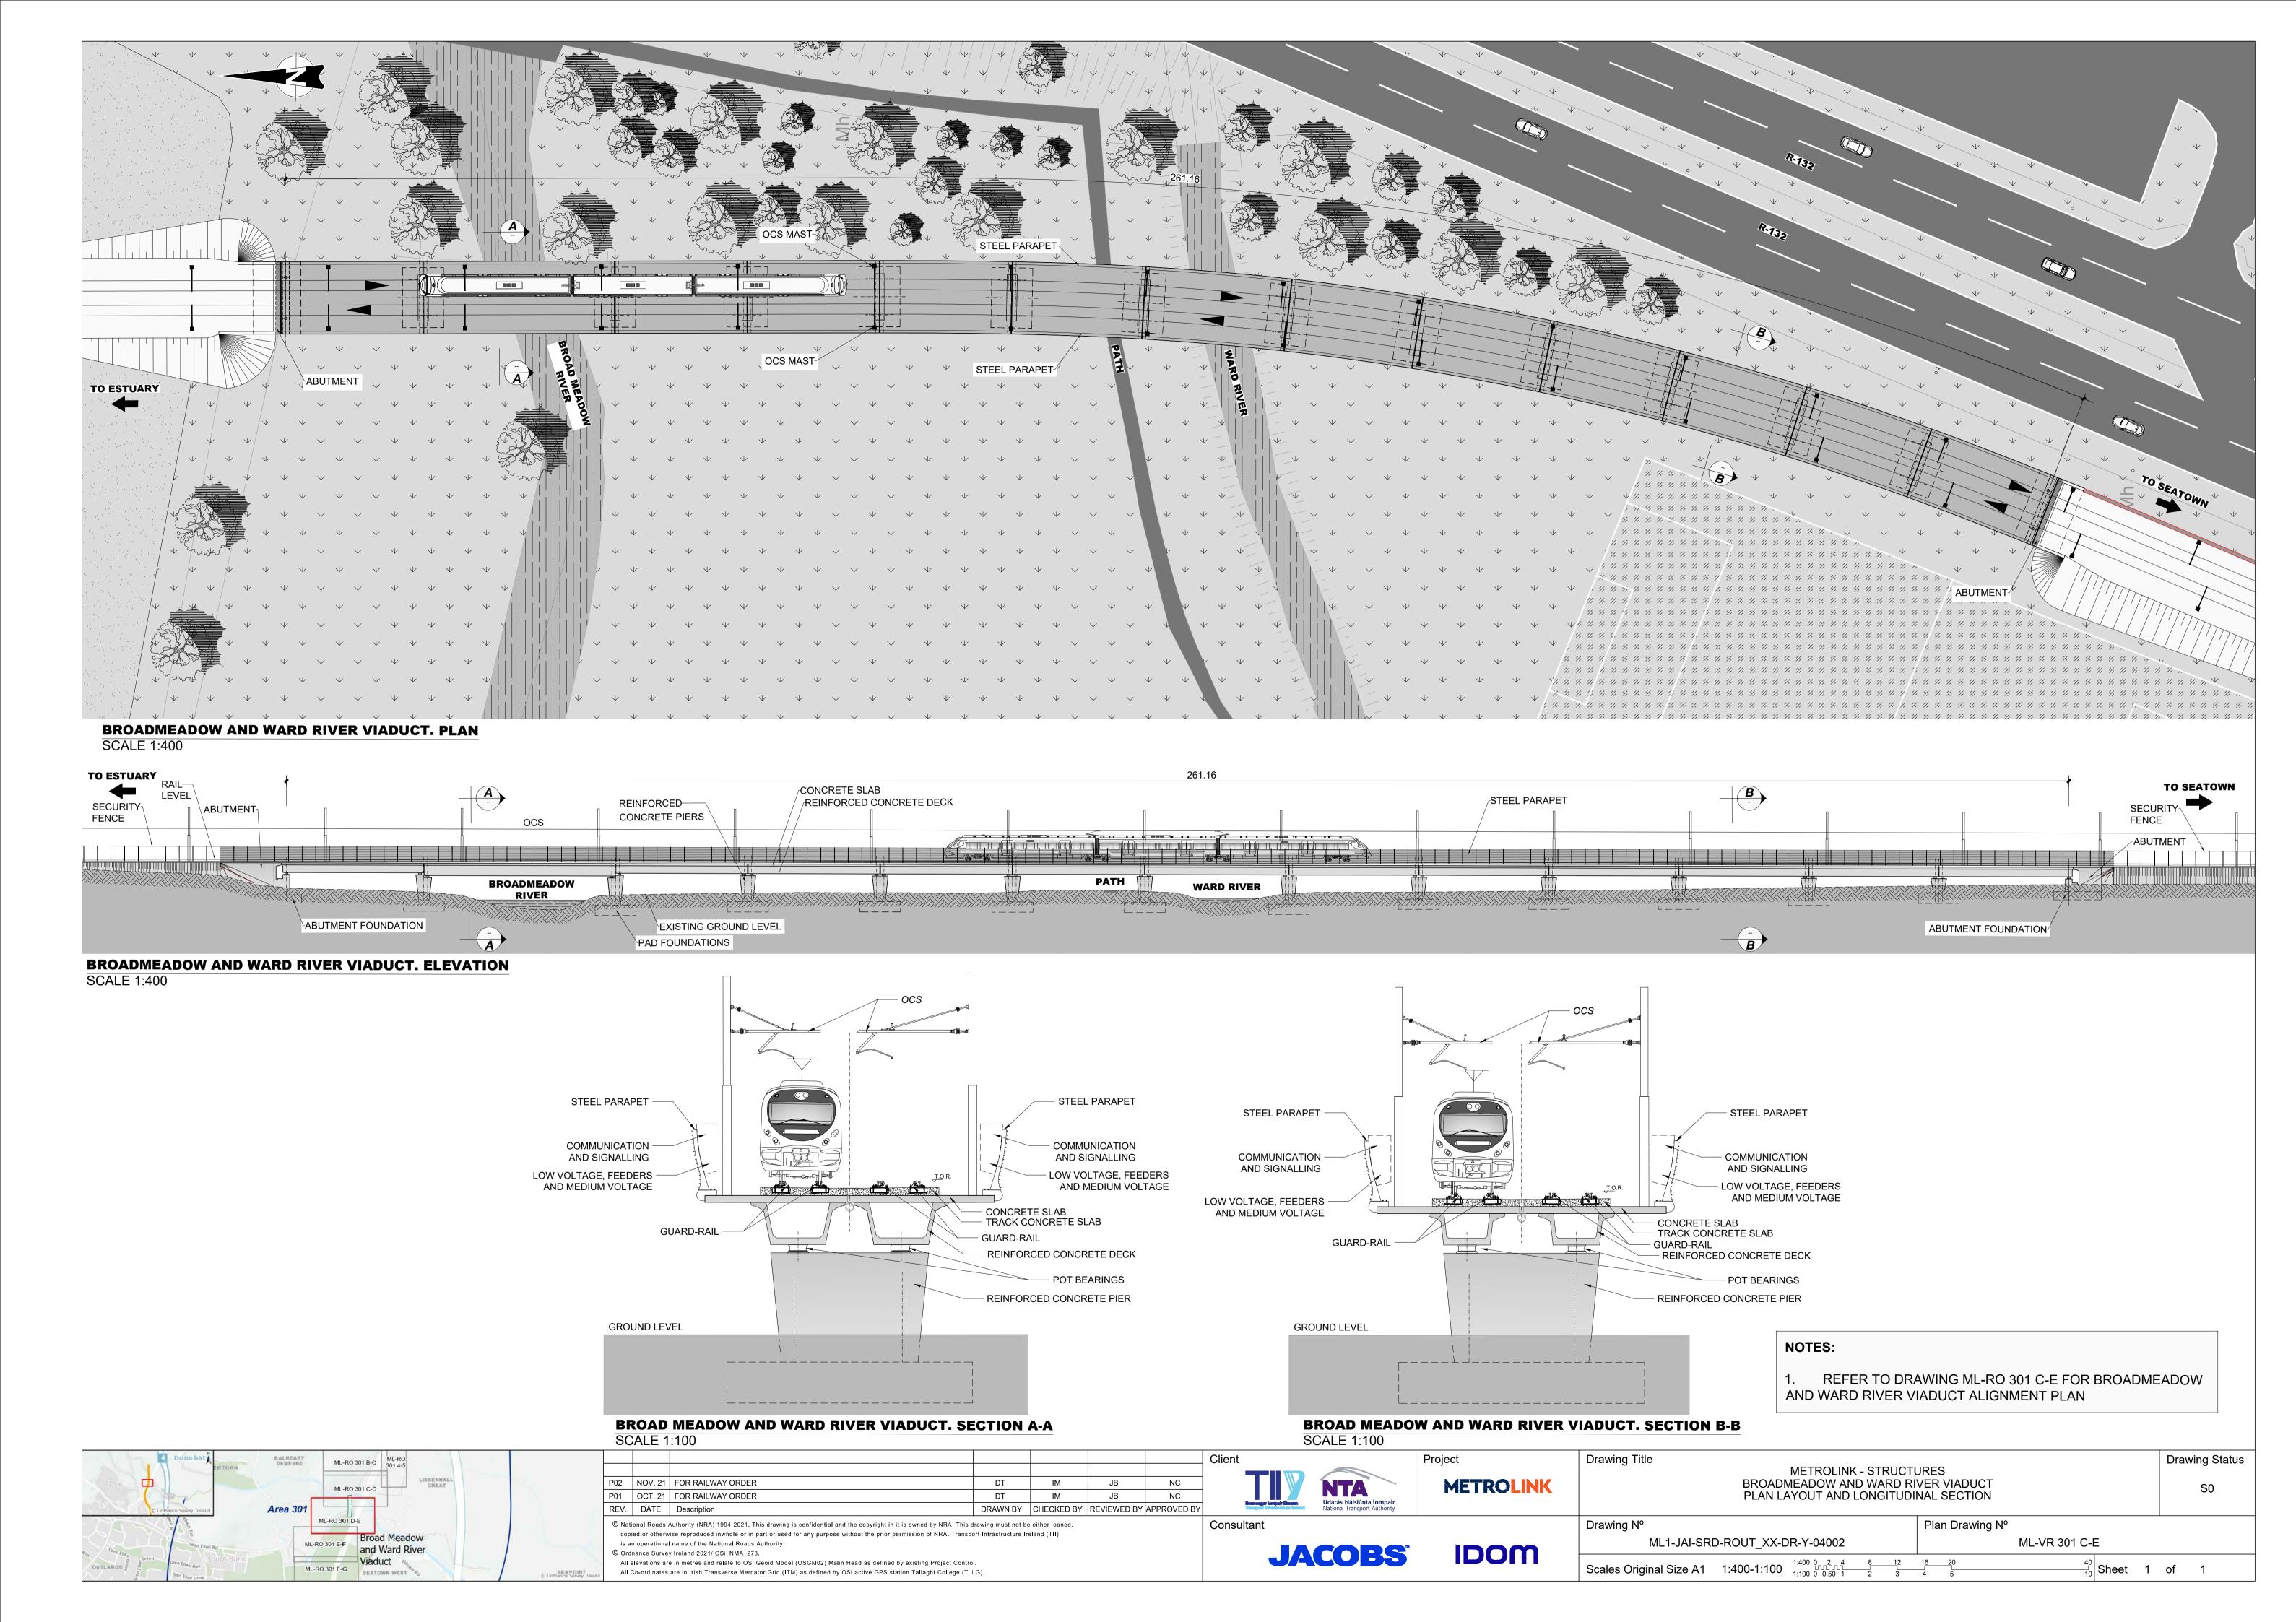


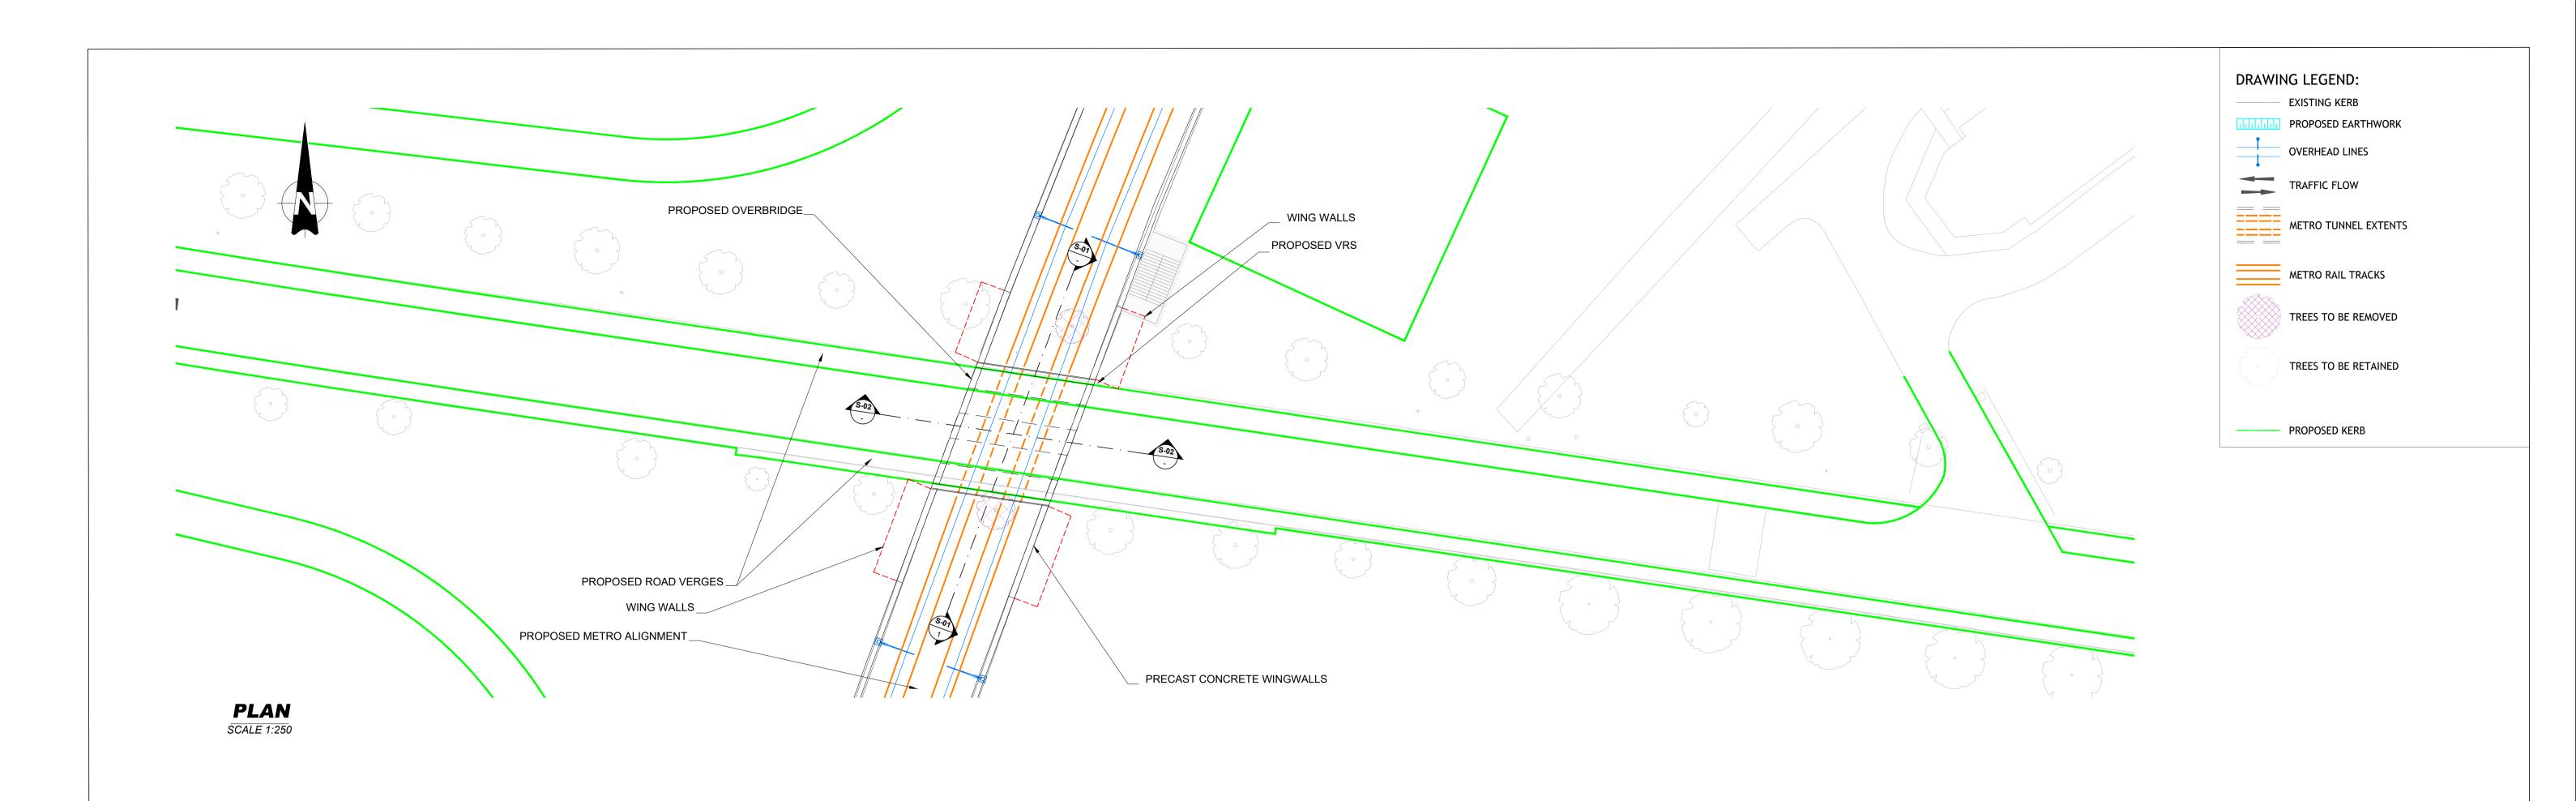

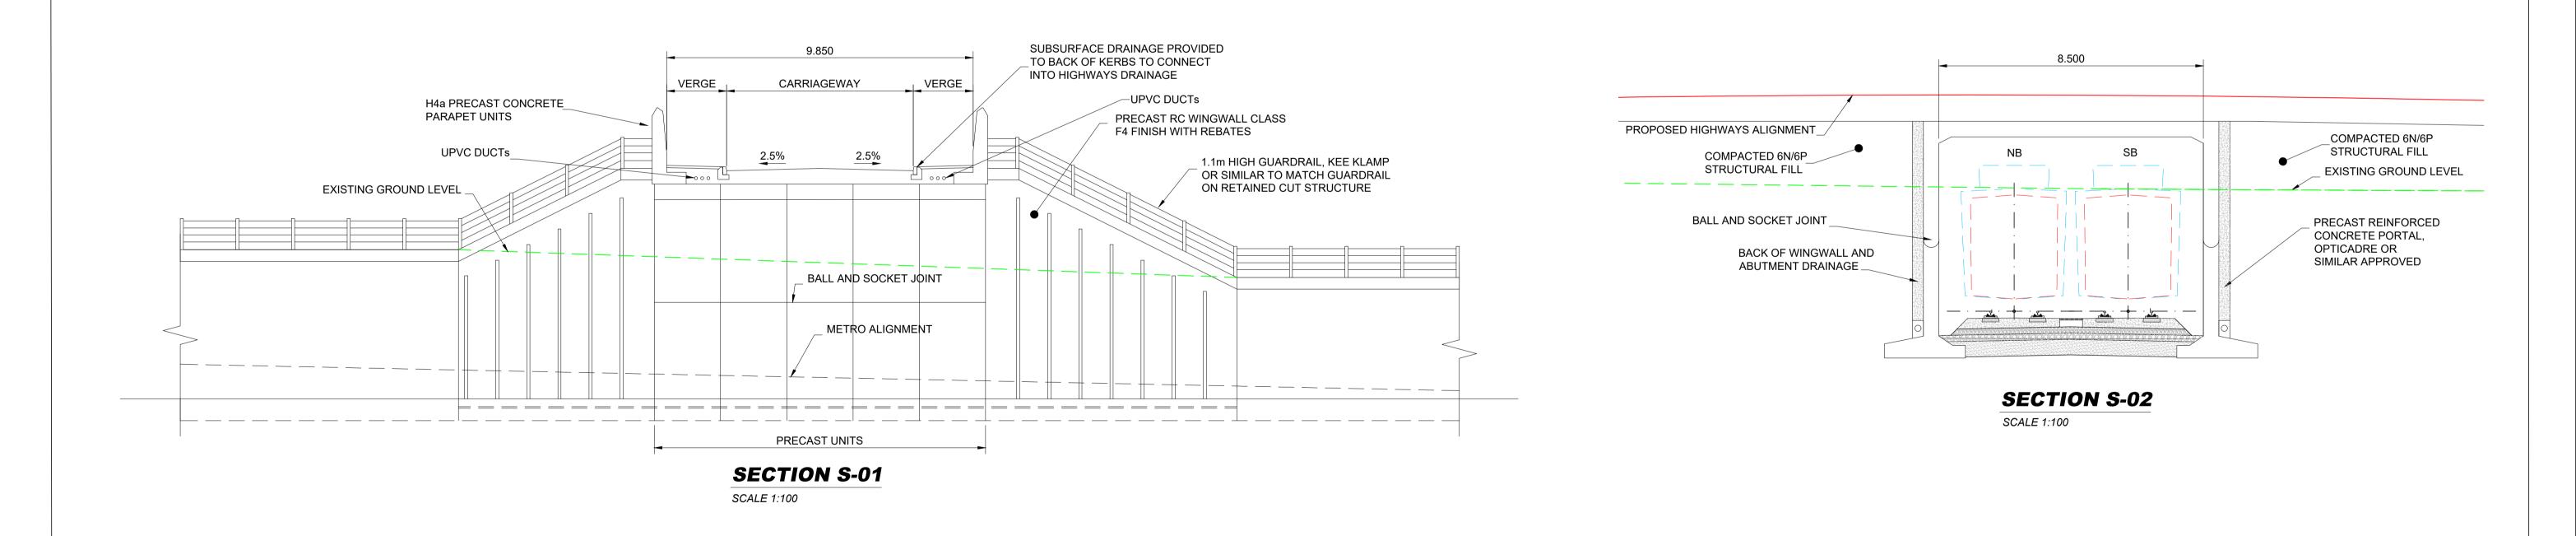


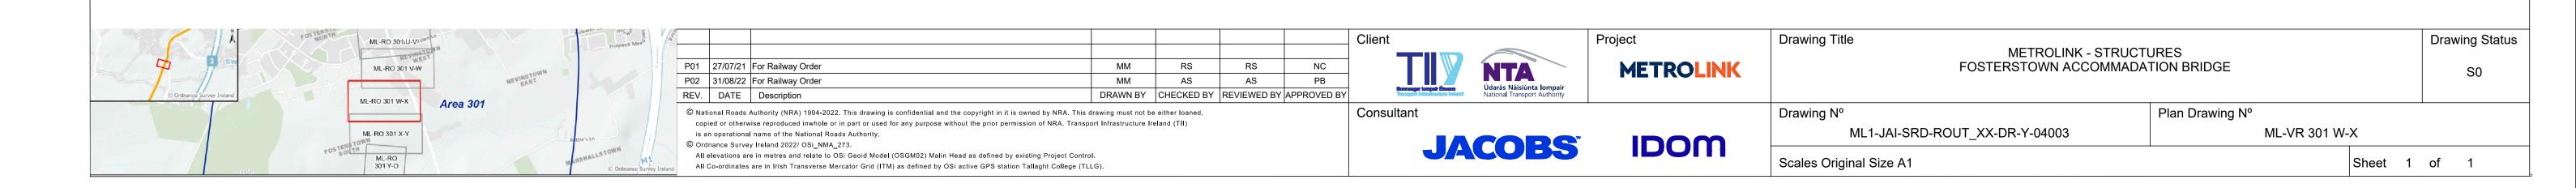

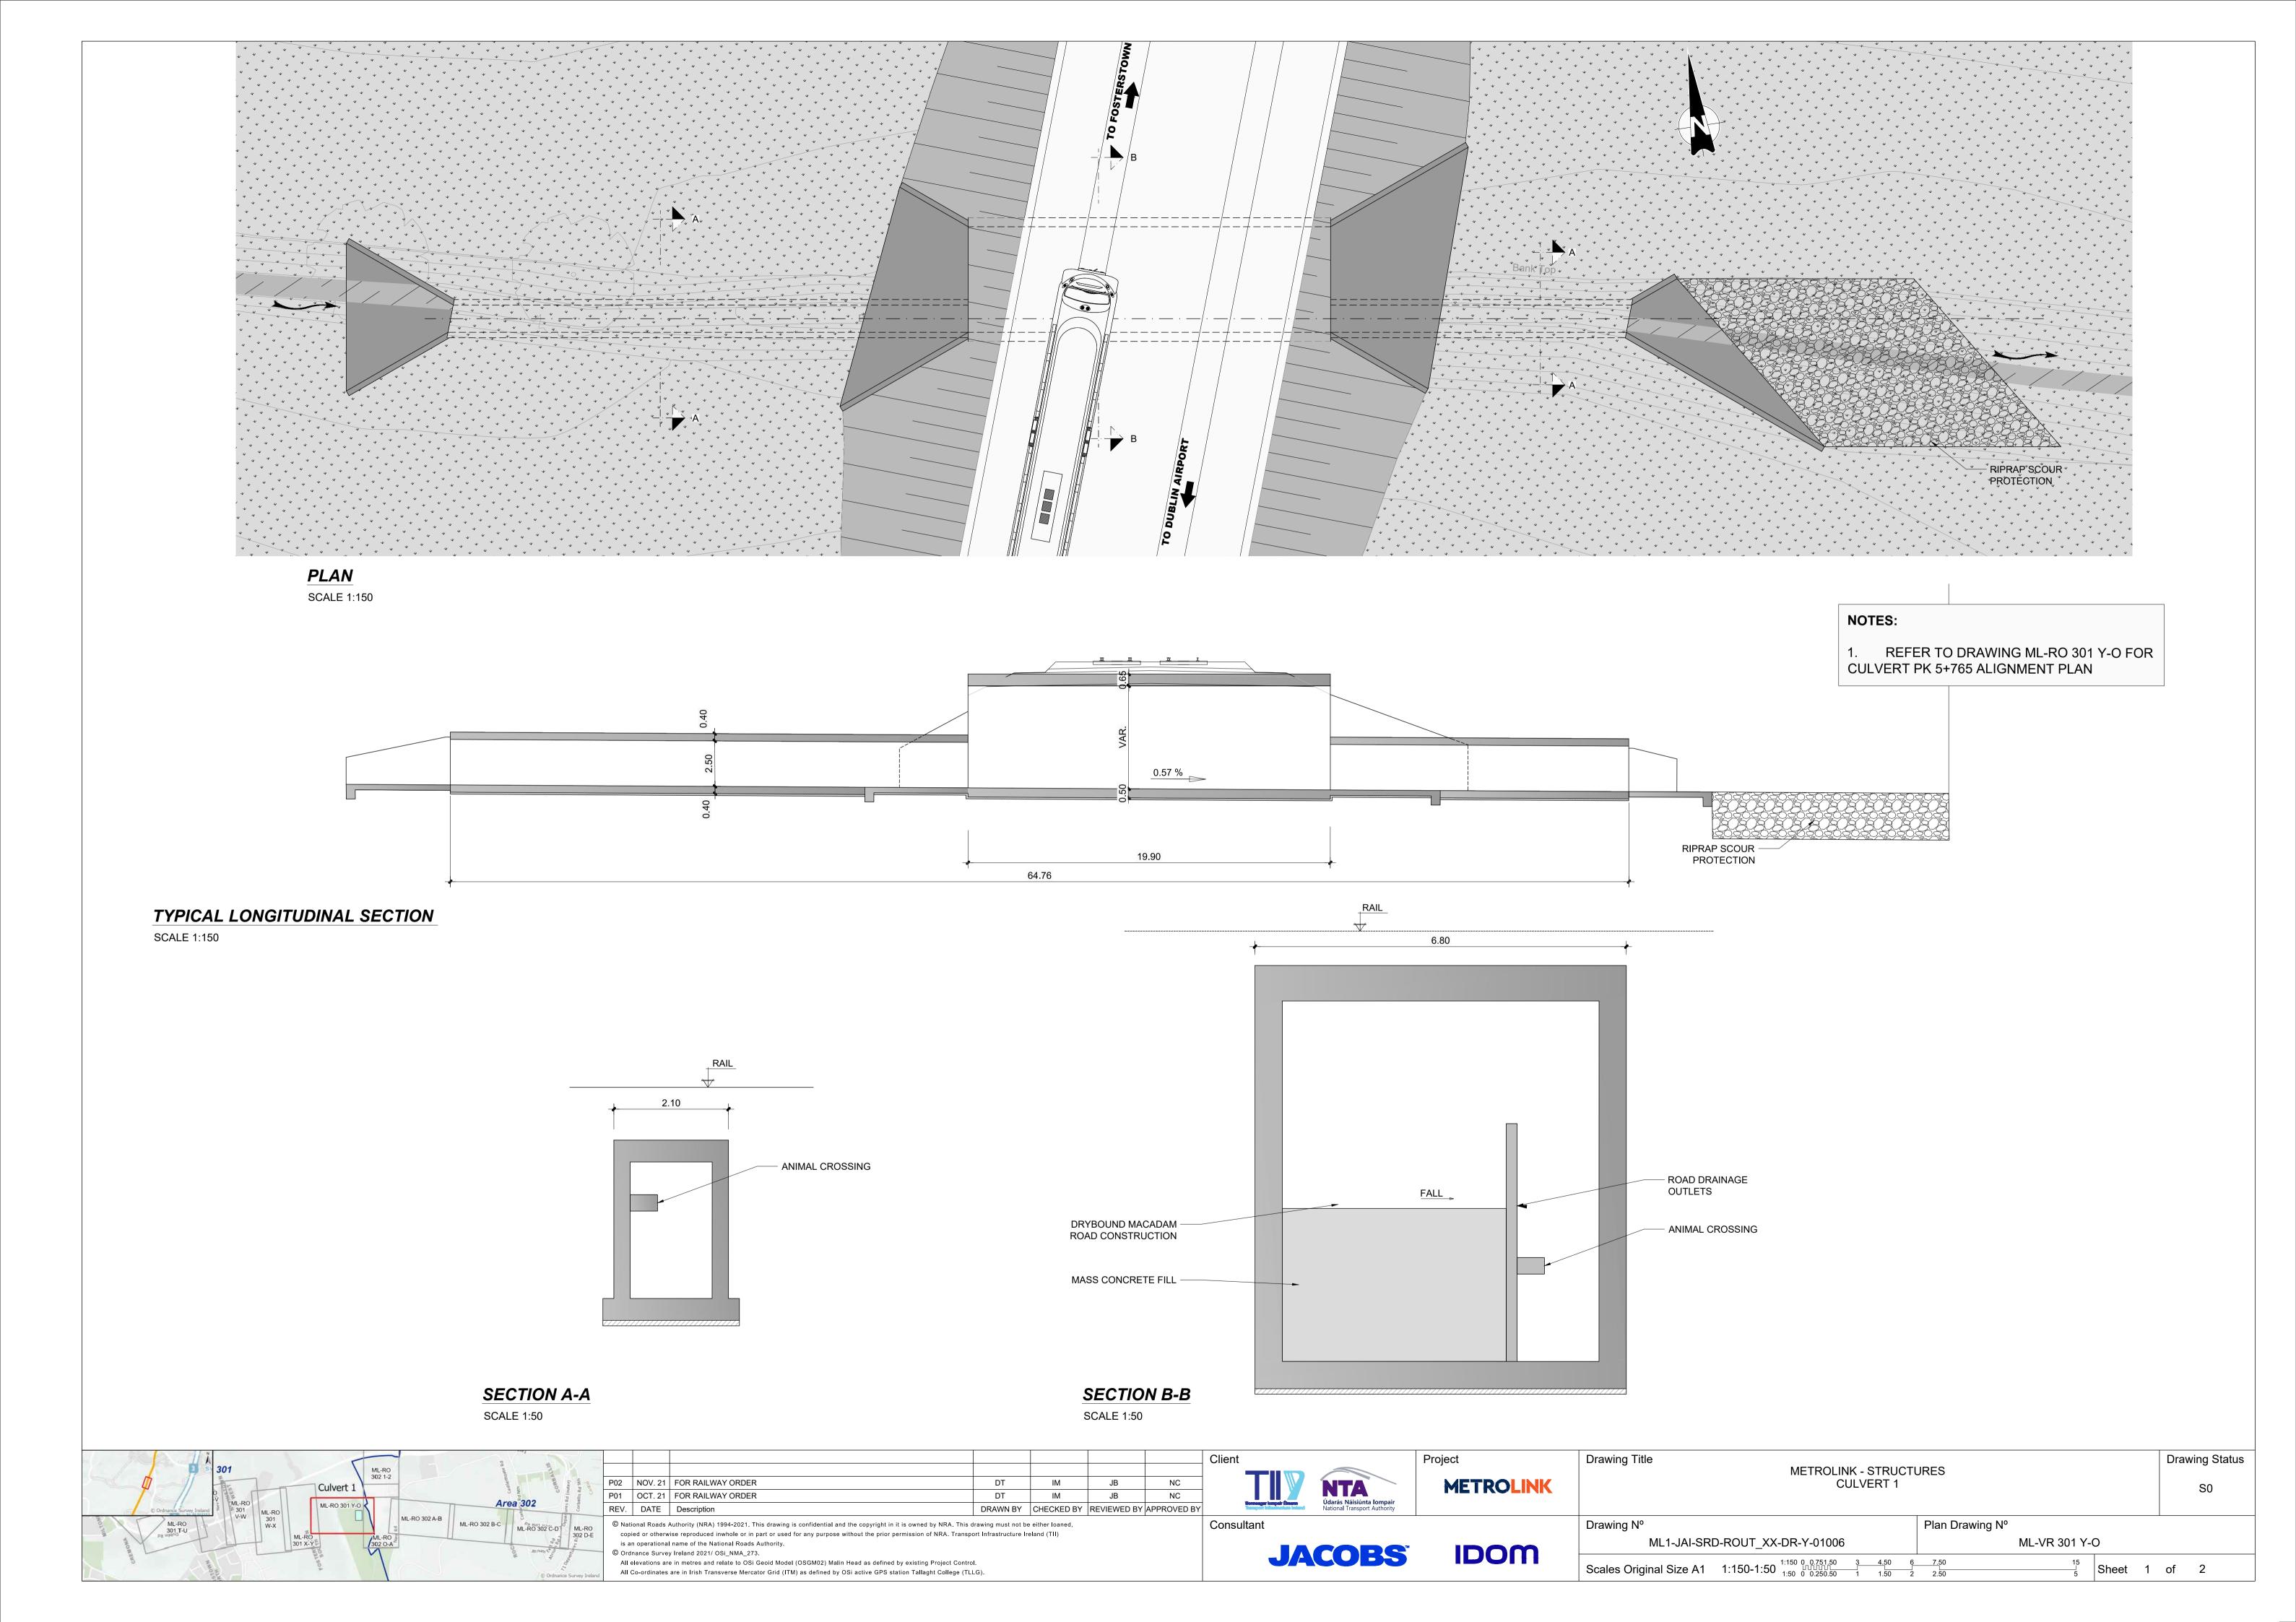

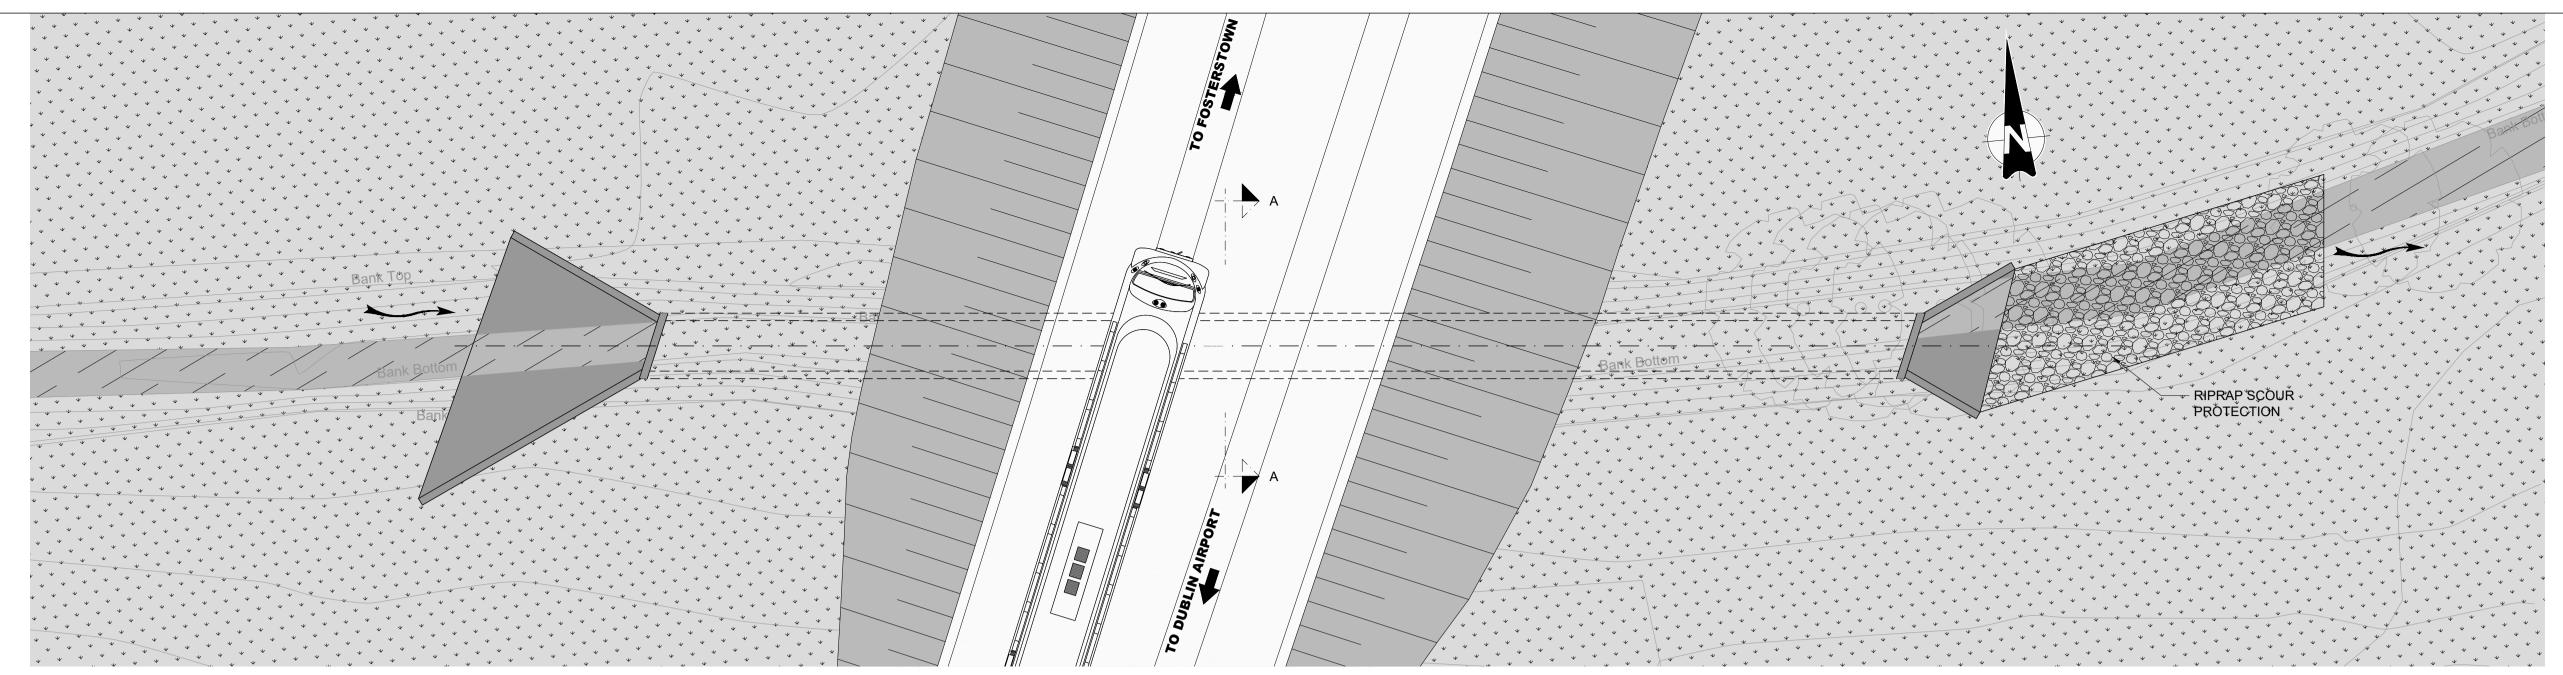

PLAN SCALE 1:150

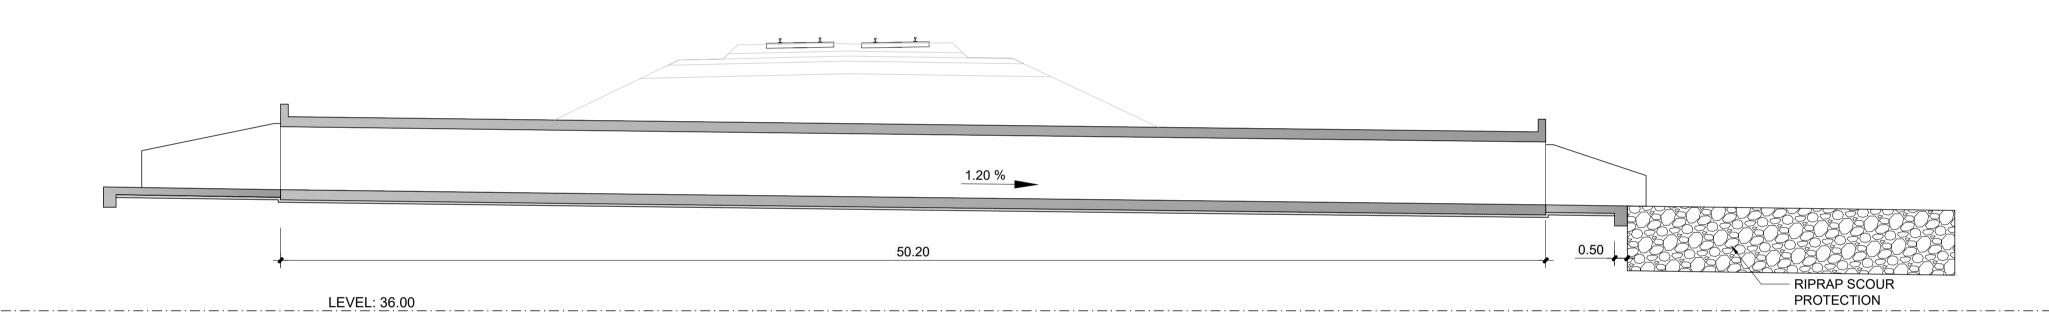


NOTES:

1. REFER TO DRAWING ML-RO 301 Y-O FOR

CULVERT PK 5+963 ALIGNMENT PLAN

TYPICAL LONGITUDINAL SECTION


SCALE 1:150

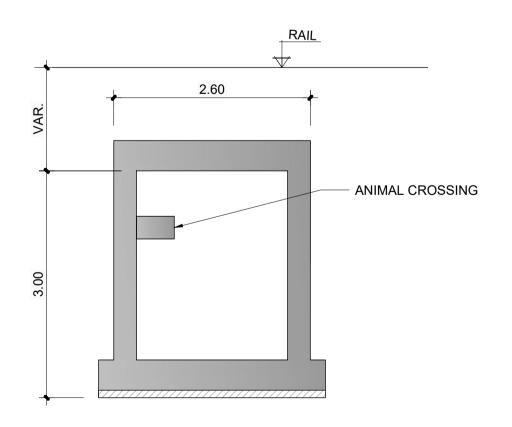



SECTION A-A

SCALE 1:50

Drawing Status Drawing Title METROLINK - STRUCTURES CULVERT 2 Údarás Náisiúnta lompair National Transport Authority **METROLINK** P02 NOV. 21 FOR RAILWAY ORDER NC P01 OCT. 21 FOR RAILWAY ORDER DT IM REV. DATE Description DRAWN BY CHECKED BY REVIEWED BY APPROVED BY ML-RO 302 A-B Drawing Nº Plan Drawing Nº ML-RO 302 B-C © National Roads Authority (NRA) 1994-2021. This drawing is confidential and the copyright in it is owned by NRA. This drawing must not be either loaned, ML-RO 302 C-D ML-RO copied or otherwise reproduced inwhole or in part or used for any purpose without the prior permission of NRA. Transport Infrastructure Ireland (TII) ML1-JAI-SRD-ROUT_XX-DR-Y-01006 ML-VR 301 Y-O is an operational name of the National Roads Authority. **JACOBS** IDOM © Ordnance Survey Ireland 2021/ OSi_NMA_273. Scales Original Size A1 1:150-1:50 1:150 0 0.751.50 3 4.50 6 7.50 1:50 0 0.250.50 1 1.50 2 2.50 All elevations are in metres and relate to OSi Geoid Model (OSGM02) Malin Head as defined by existing Project Control. Sheet 2 of 2 All Co-ordinates are in Irish Transverse Mercator Grid (ITM) as defined by OSi active GPS station Tallaght College (TLLG).

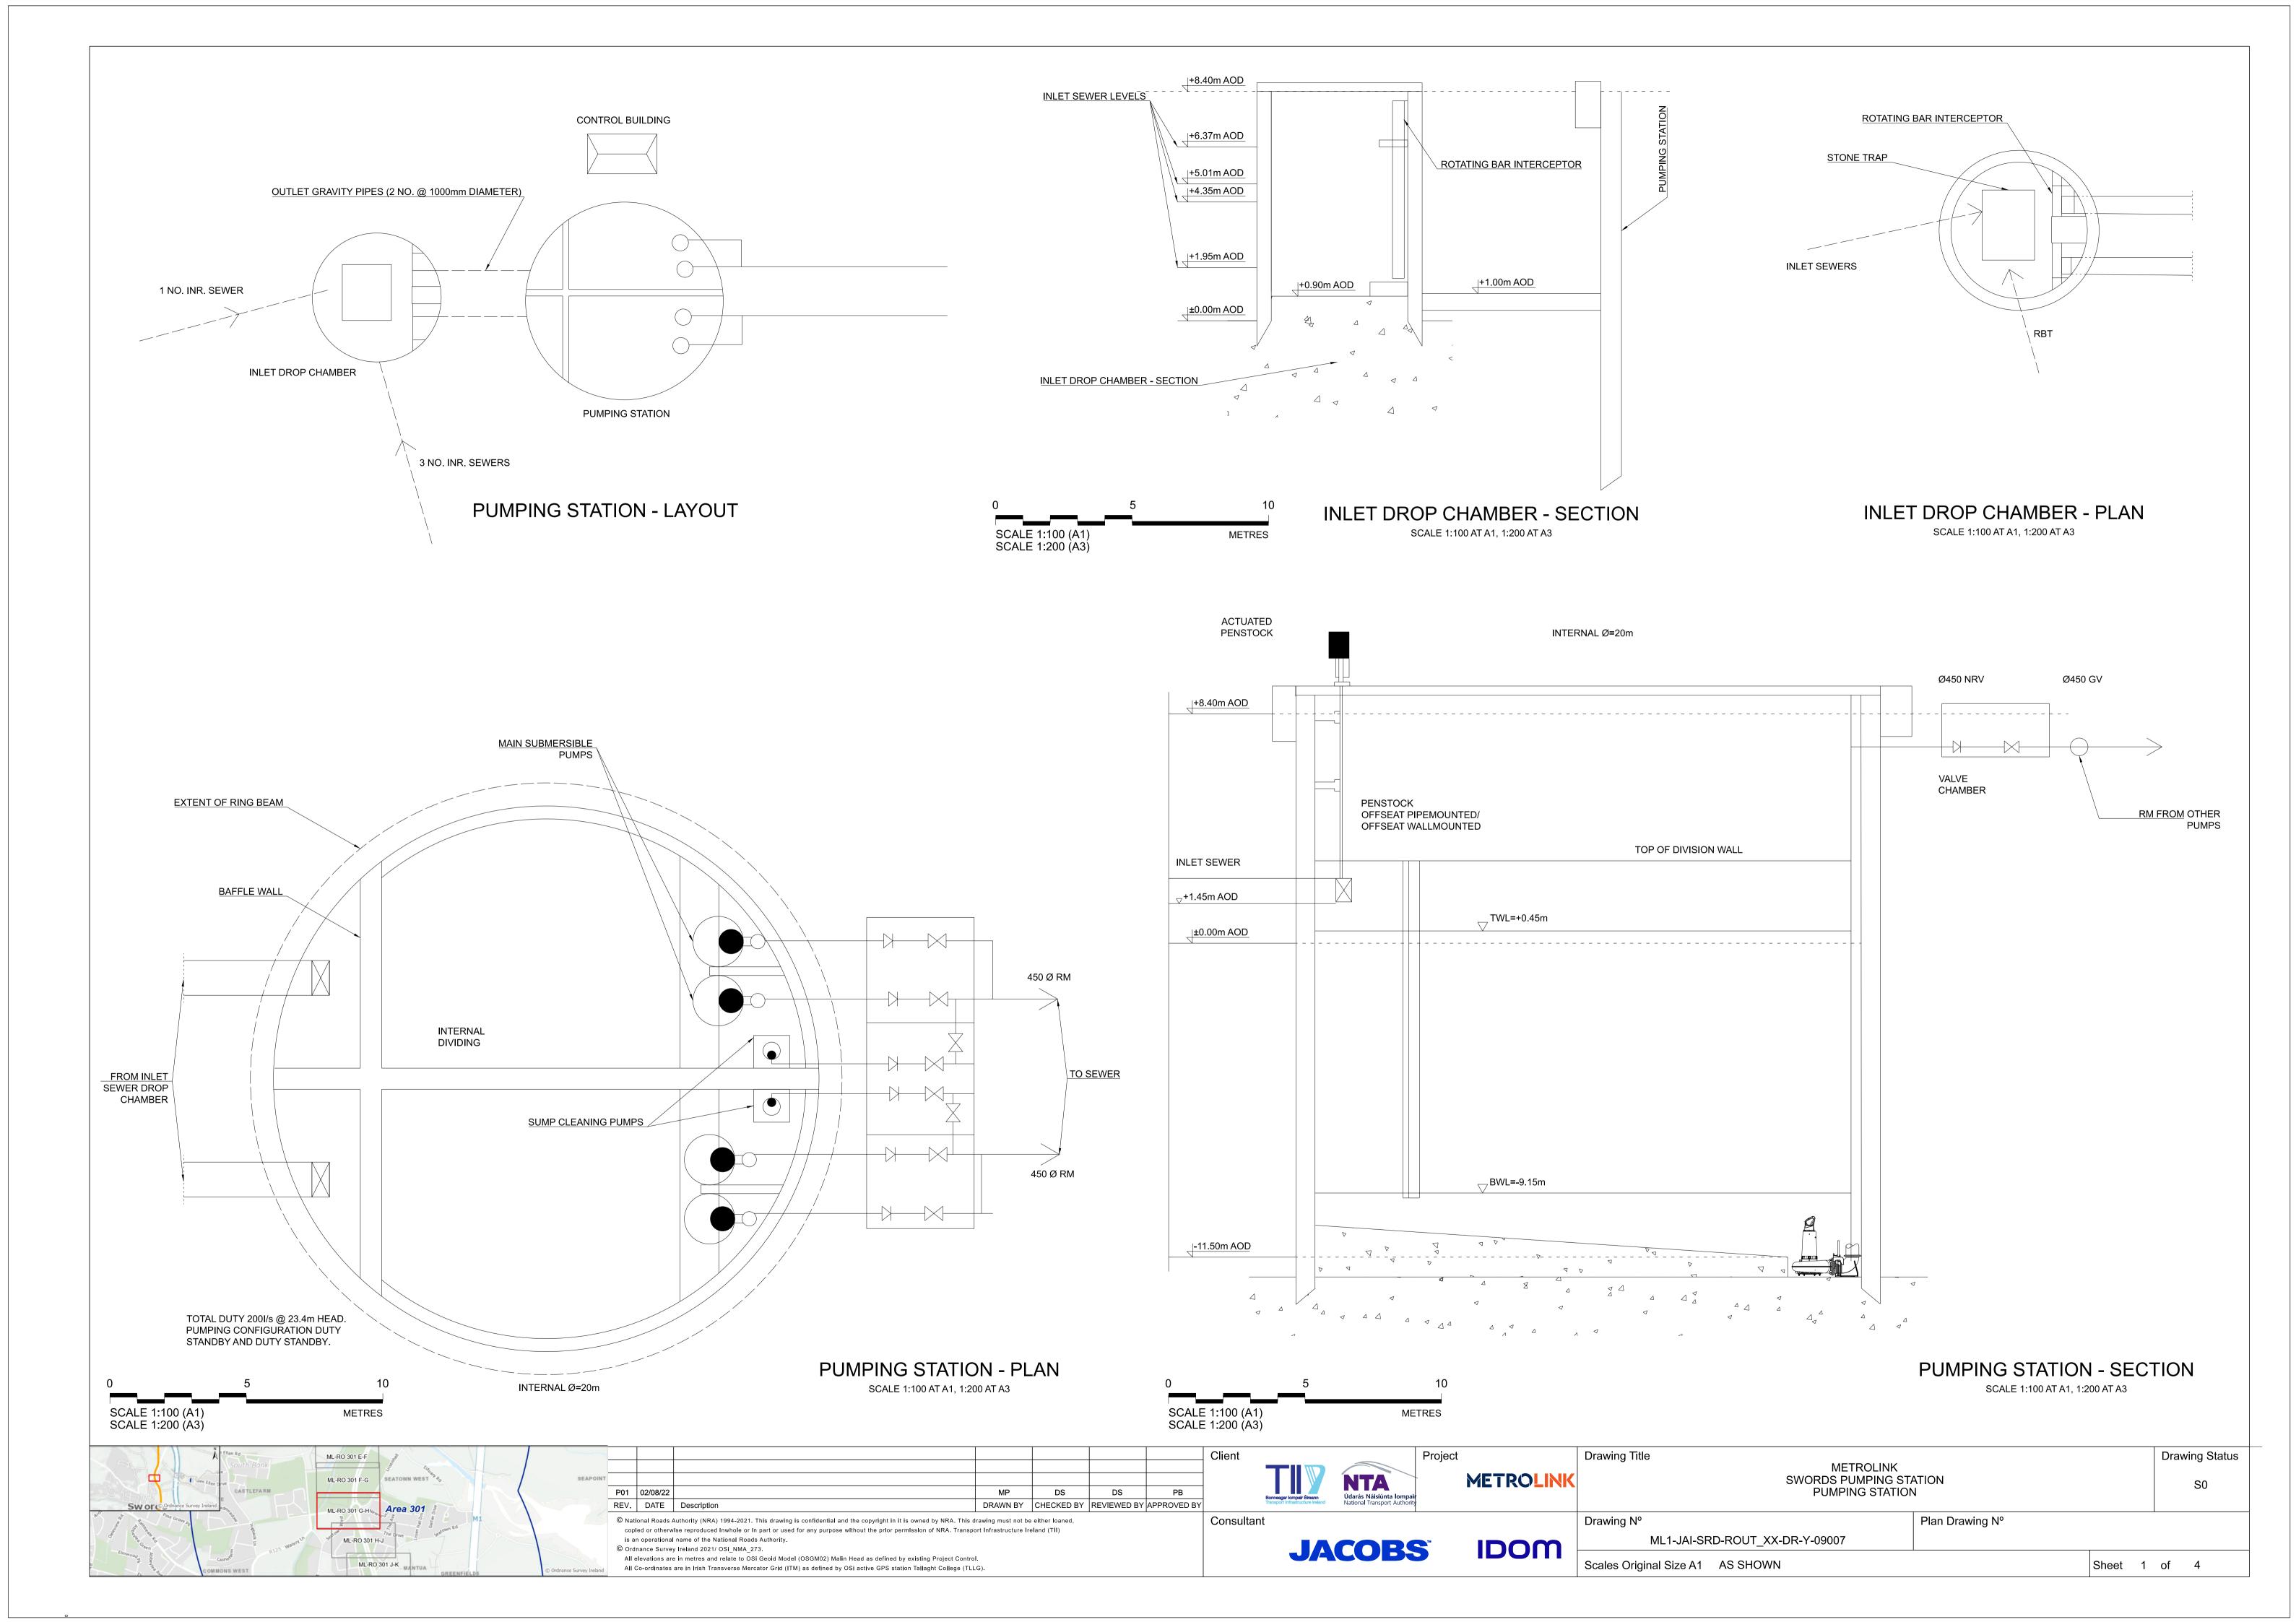


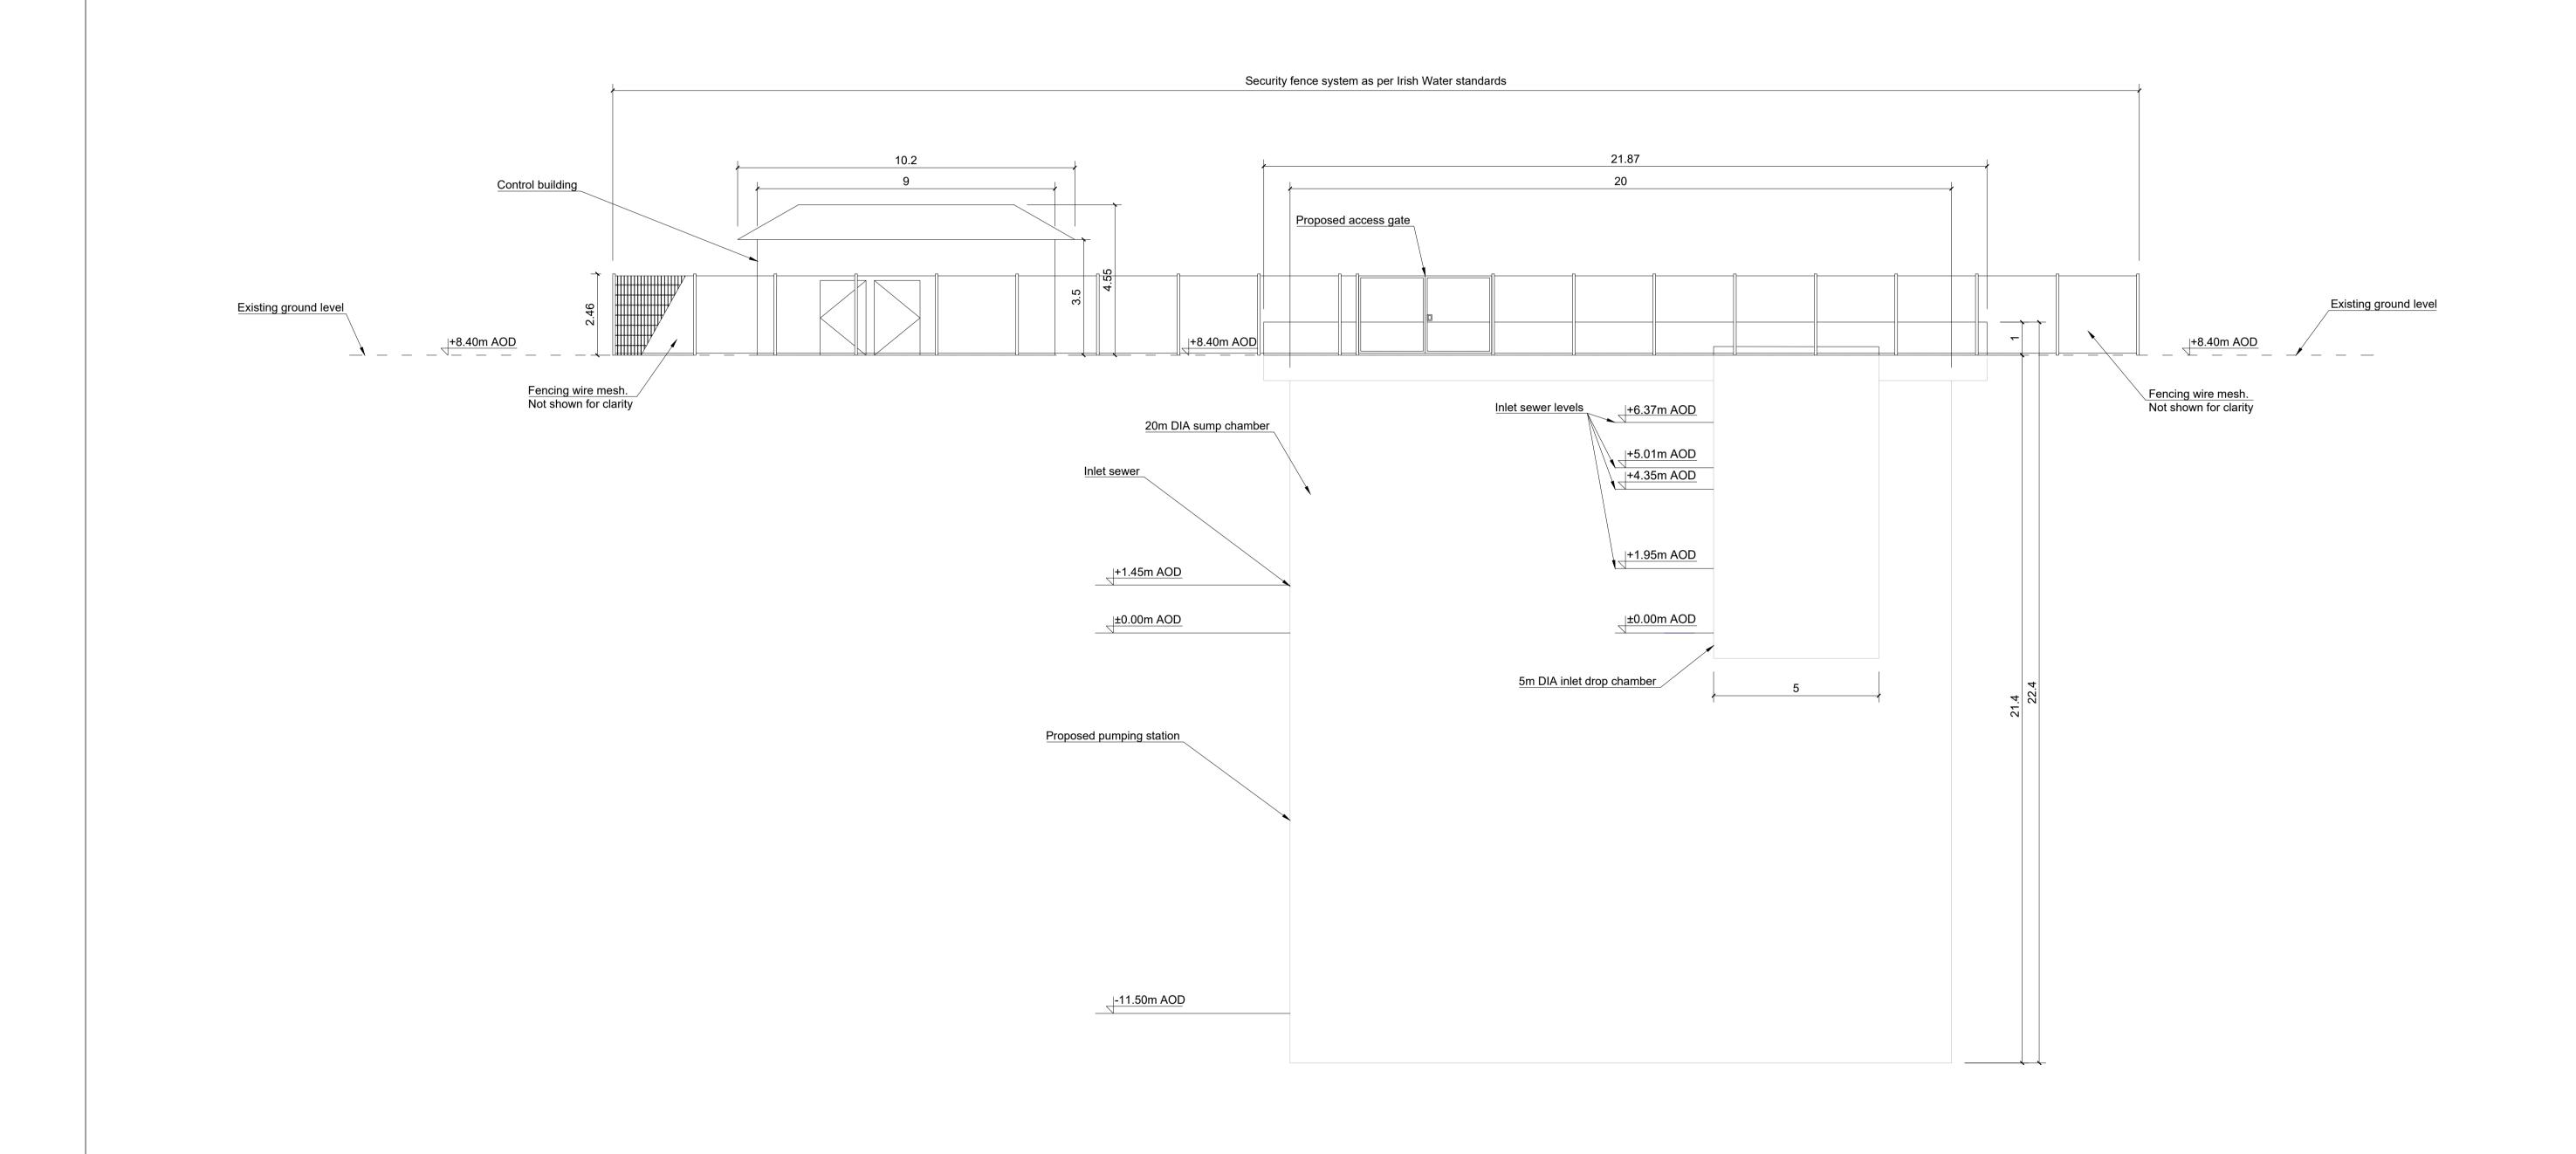

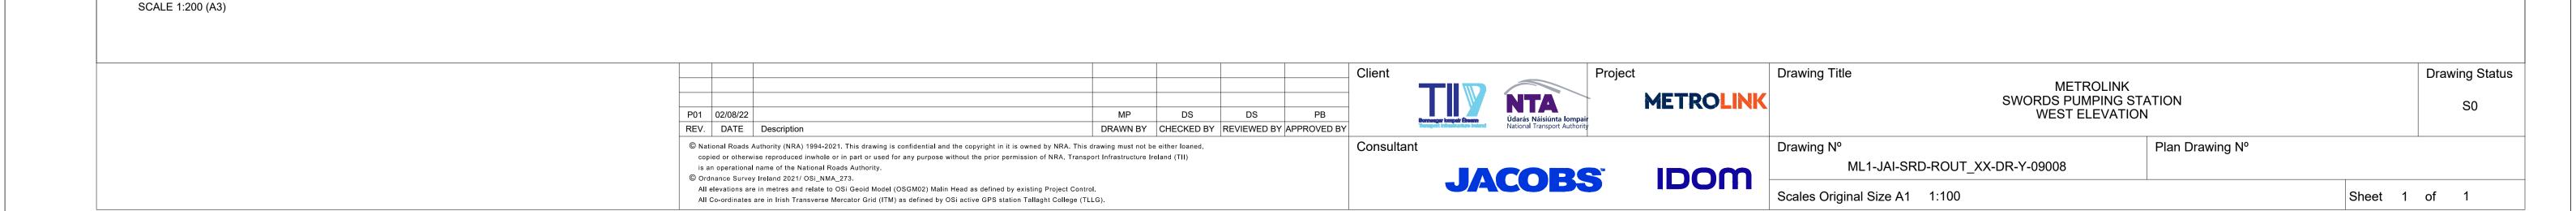



METRES


SCALE 1:100 (A1)

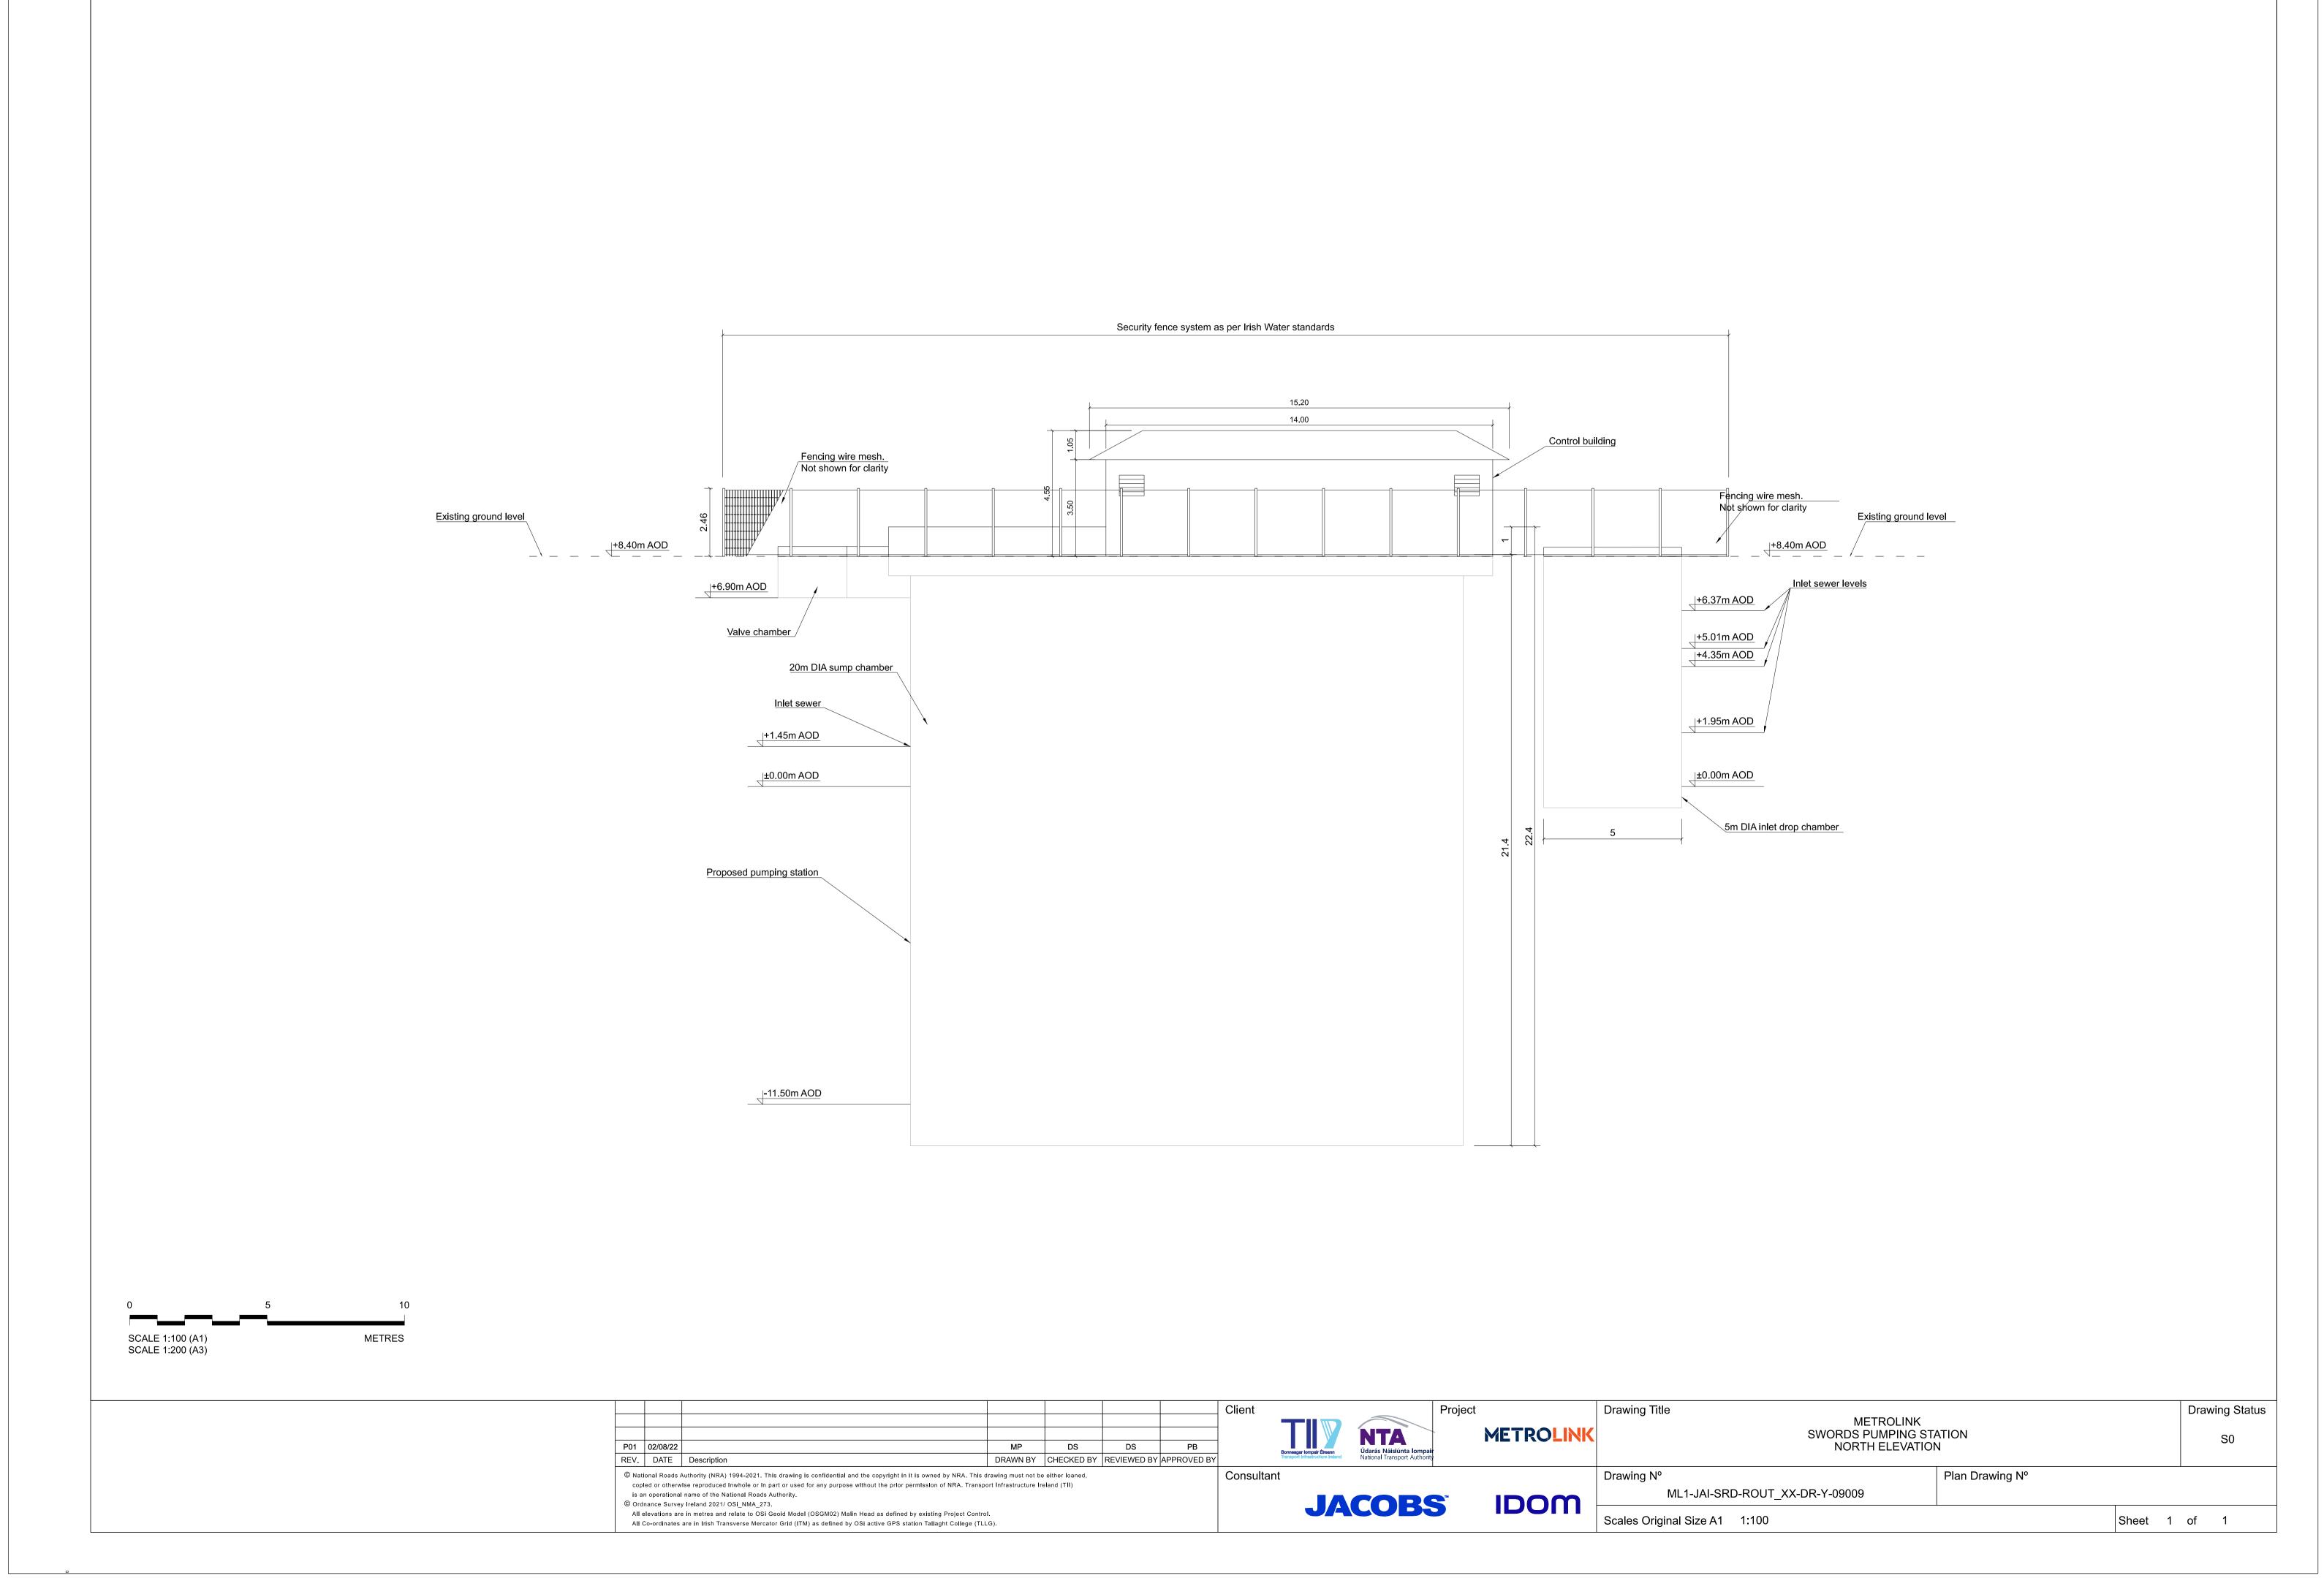



PUMPING STATION CONTROL BUILDING - ELEVATIONS SCALE 1:50 AT A1, 1:100 AT A3

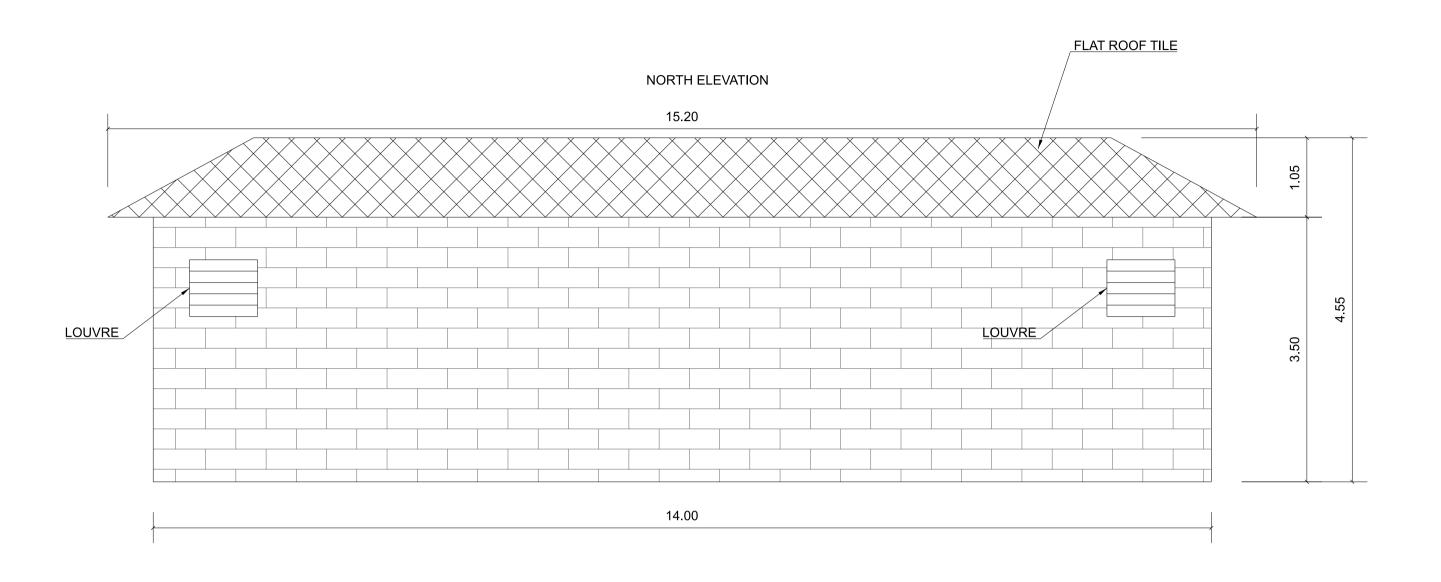

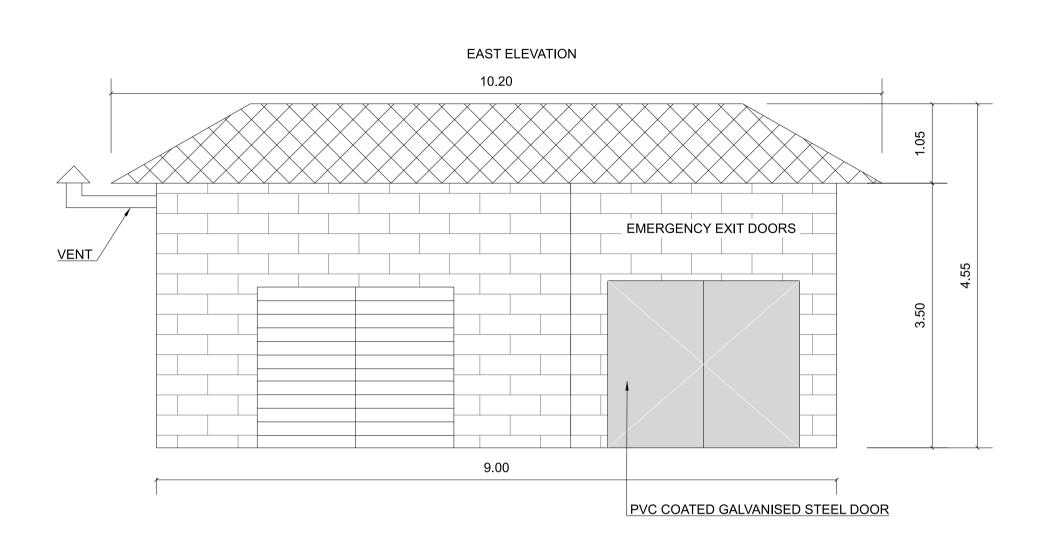

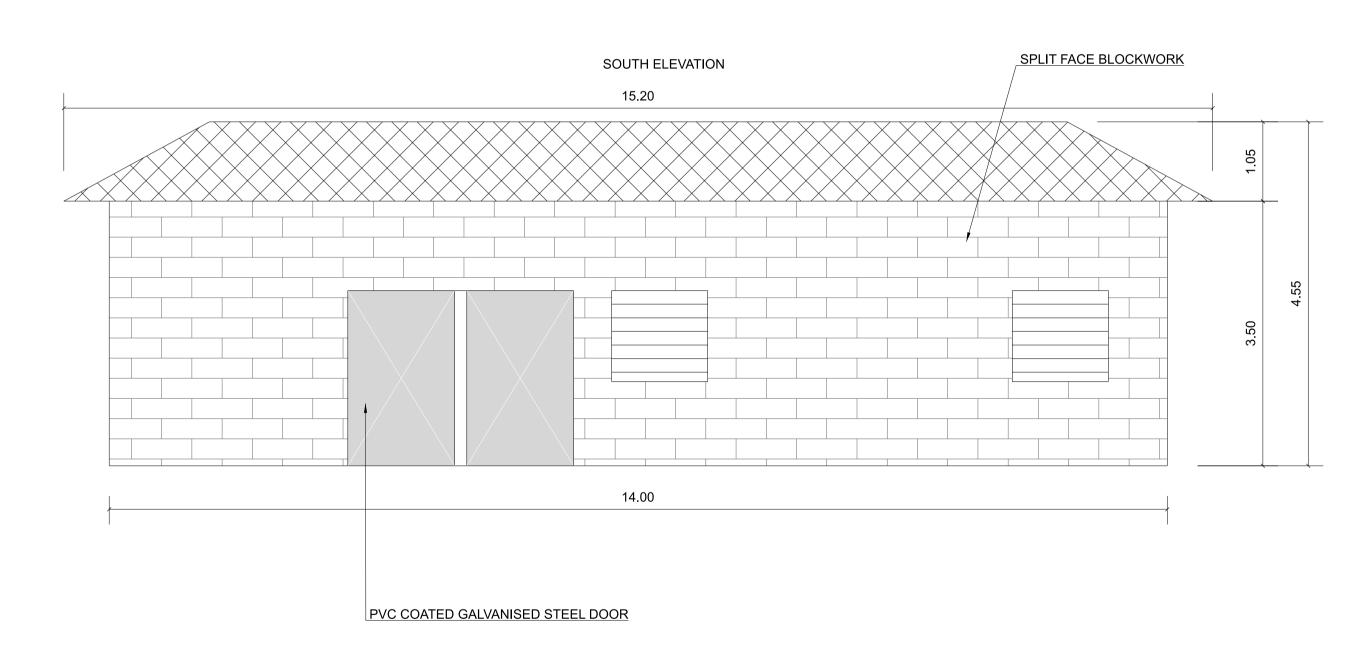

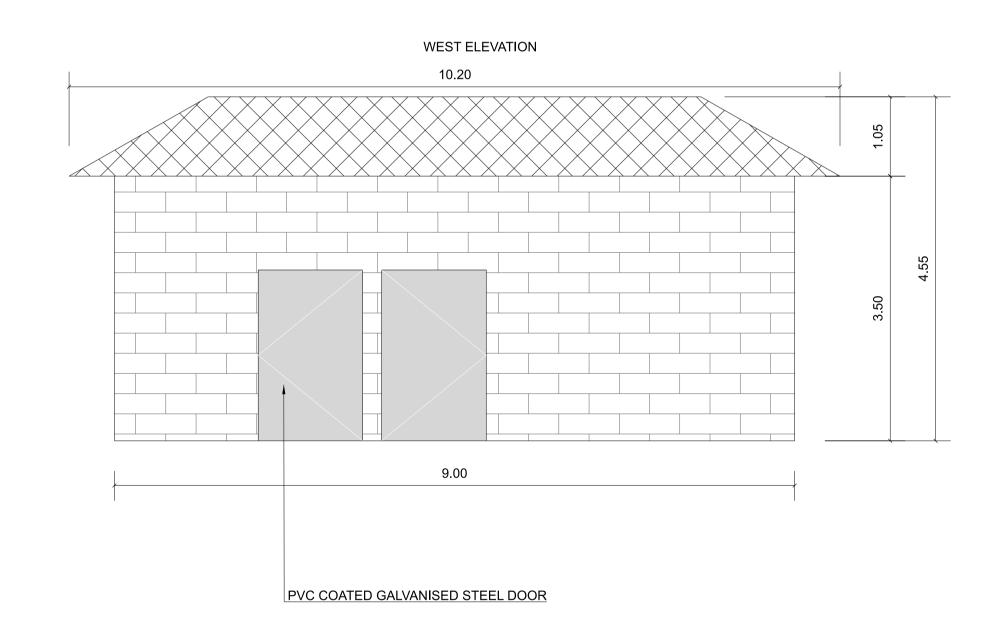

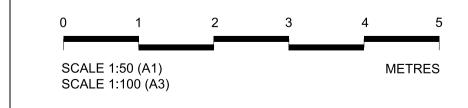



							C	
							ı	
P01	02/08/22		MP	DS	DS	PB	ı	
REV.	DATE	Description	DRAWN BY	CHECKED BY	REVIEWED BY	APPROVED BY		
© Nati	© National Roads Authority (NRA) 1994-2021. This drawing is confidential and the copyright in it is owned by NRA. This drawing must not be either loaned,							

copled or otherwise reproduced inwhole or in part or used for any purpose without the prior permission of NRA. Transport infrastructure Ireland (TII) is an operational name of the National Roads Authority.

All elevations are in metres and relate to OSi Geoid Model (OSGM02) Malin Head as defined by existing Project Control.

All Co-ordinates are in Irish Transverse Mercator Grid (ITM) as defined by OSi active GPS station Tallaght College (TLLG).

METROLINK

Drawing Title METROLINK SWORDS PUMPING STATION CONTROL BUILDING ELEVATIONS Drawing Status

Consultant

JACOBS


IDOM


Drawing Nº Plan Drawing Nº ML1-JAI-SRD-ROUT_XX-DR-Y-09010


Scales Original Size A1 1:50 Sheet 2 of 4

PUMPING STATION CONTROL BUILDING - PLAN SCALE 1:50 AT A1, 1:100 AT A3

NORTH

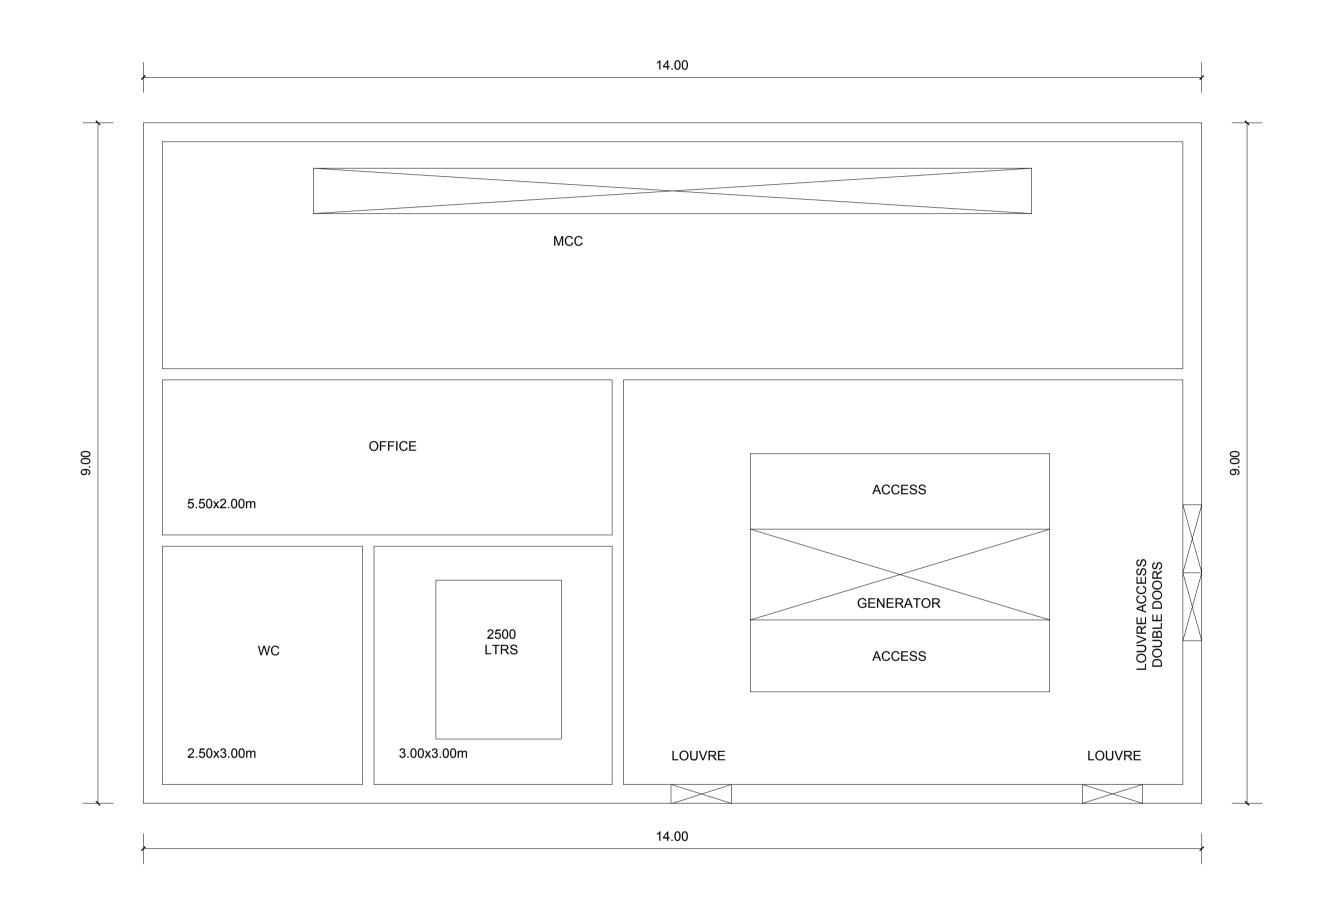

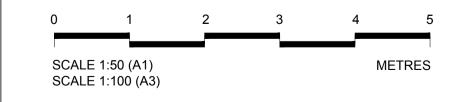

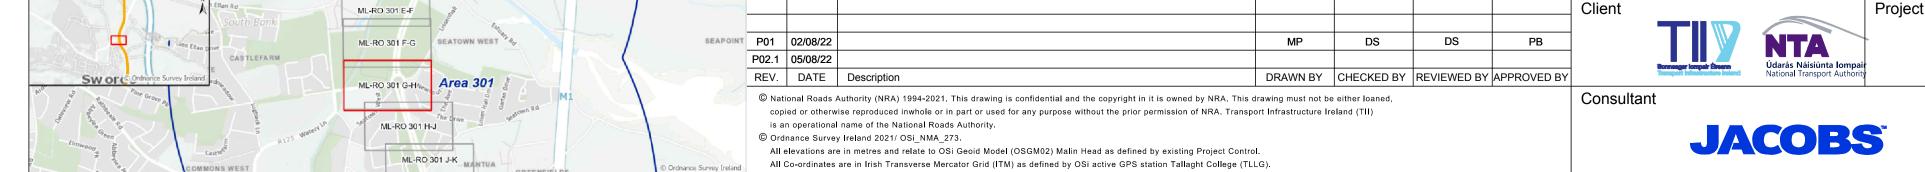

All Co-ordinates are in Irish Transverse Mercator Grid (ITM) as defined by OSi active GPS station Tallaght College (TLLG).

WEST





Drawing Title METROLINK SWORDS PUMPING STATION CONTROL BUILDING PLAN

Drawing Status

IDOM


Drawing N° Plan Drawing Nº ML1-JAI-SRD-ROUT_XX-DR-Y-09011

Sheet 3 of 4


Scales Original Size A1 1:50


SUMP ACCESS COVER LAYOUT


SCALE 1:100 AT A1, 1:200 AT A3

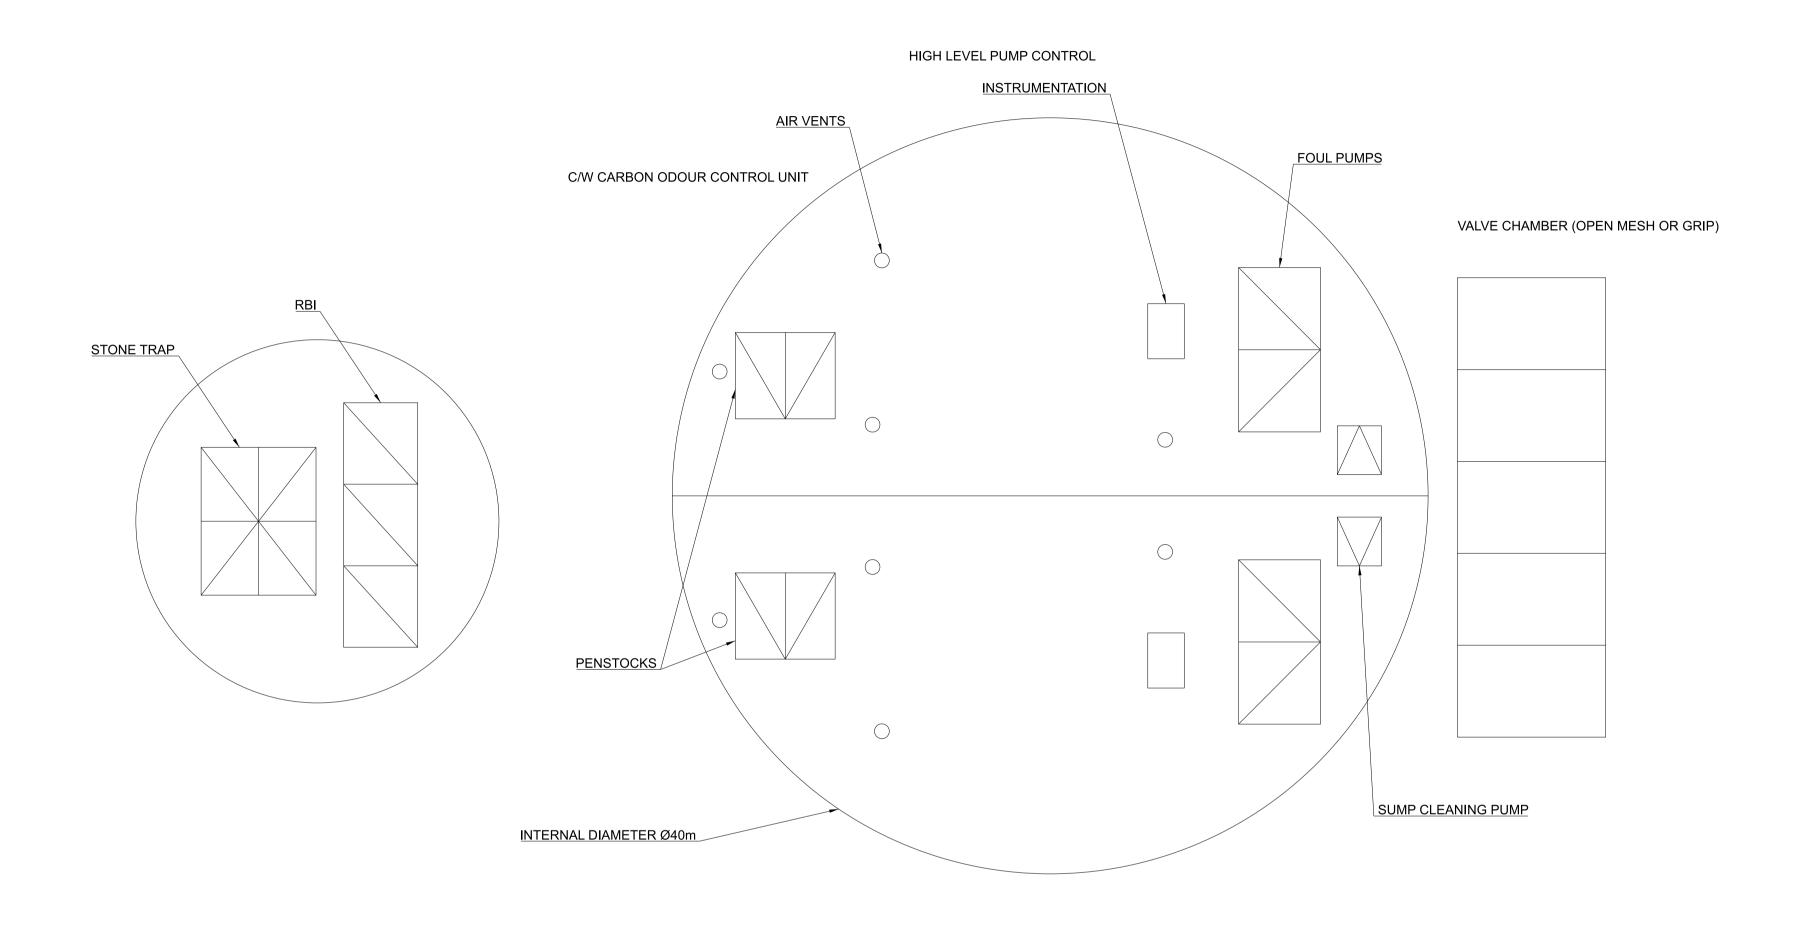


1. COVER SIZES TO BE DETERMINED AS PART OF DETAILED DESIGN. 2. LOW LEVEL STOP PROBES FOR ALL PUMPS REQUIRED. SUITABLE LOCATION T.B.C.

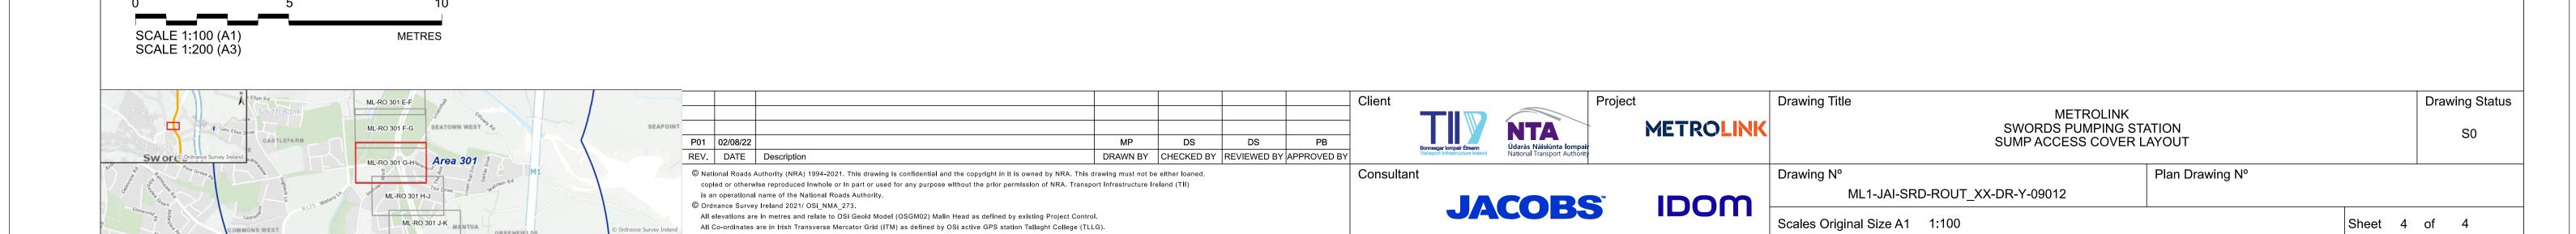


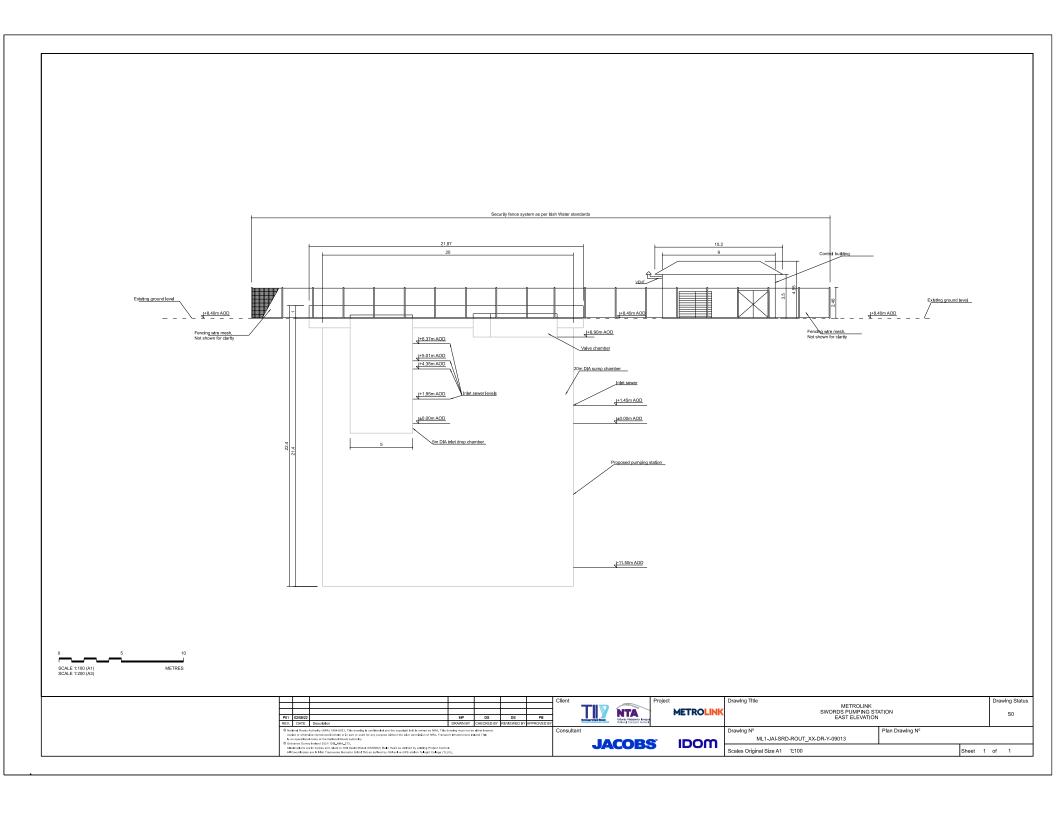


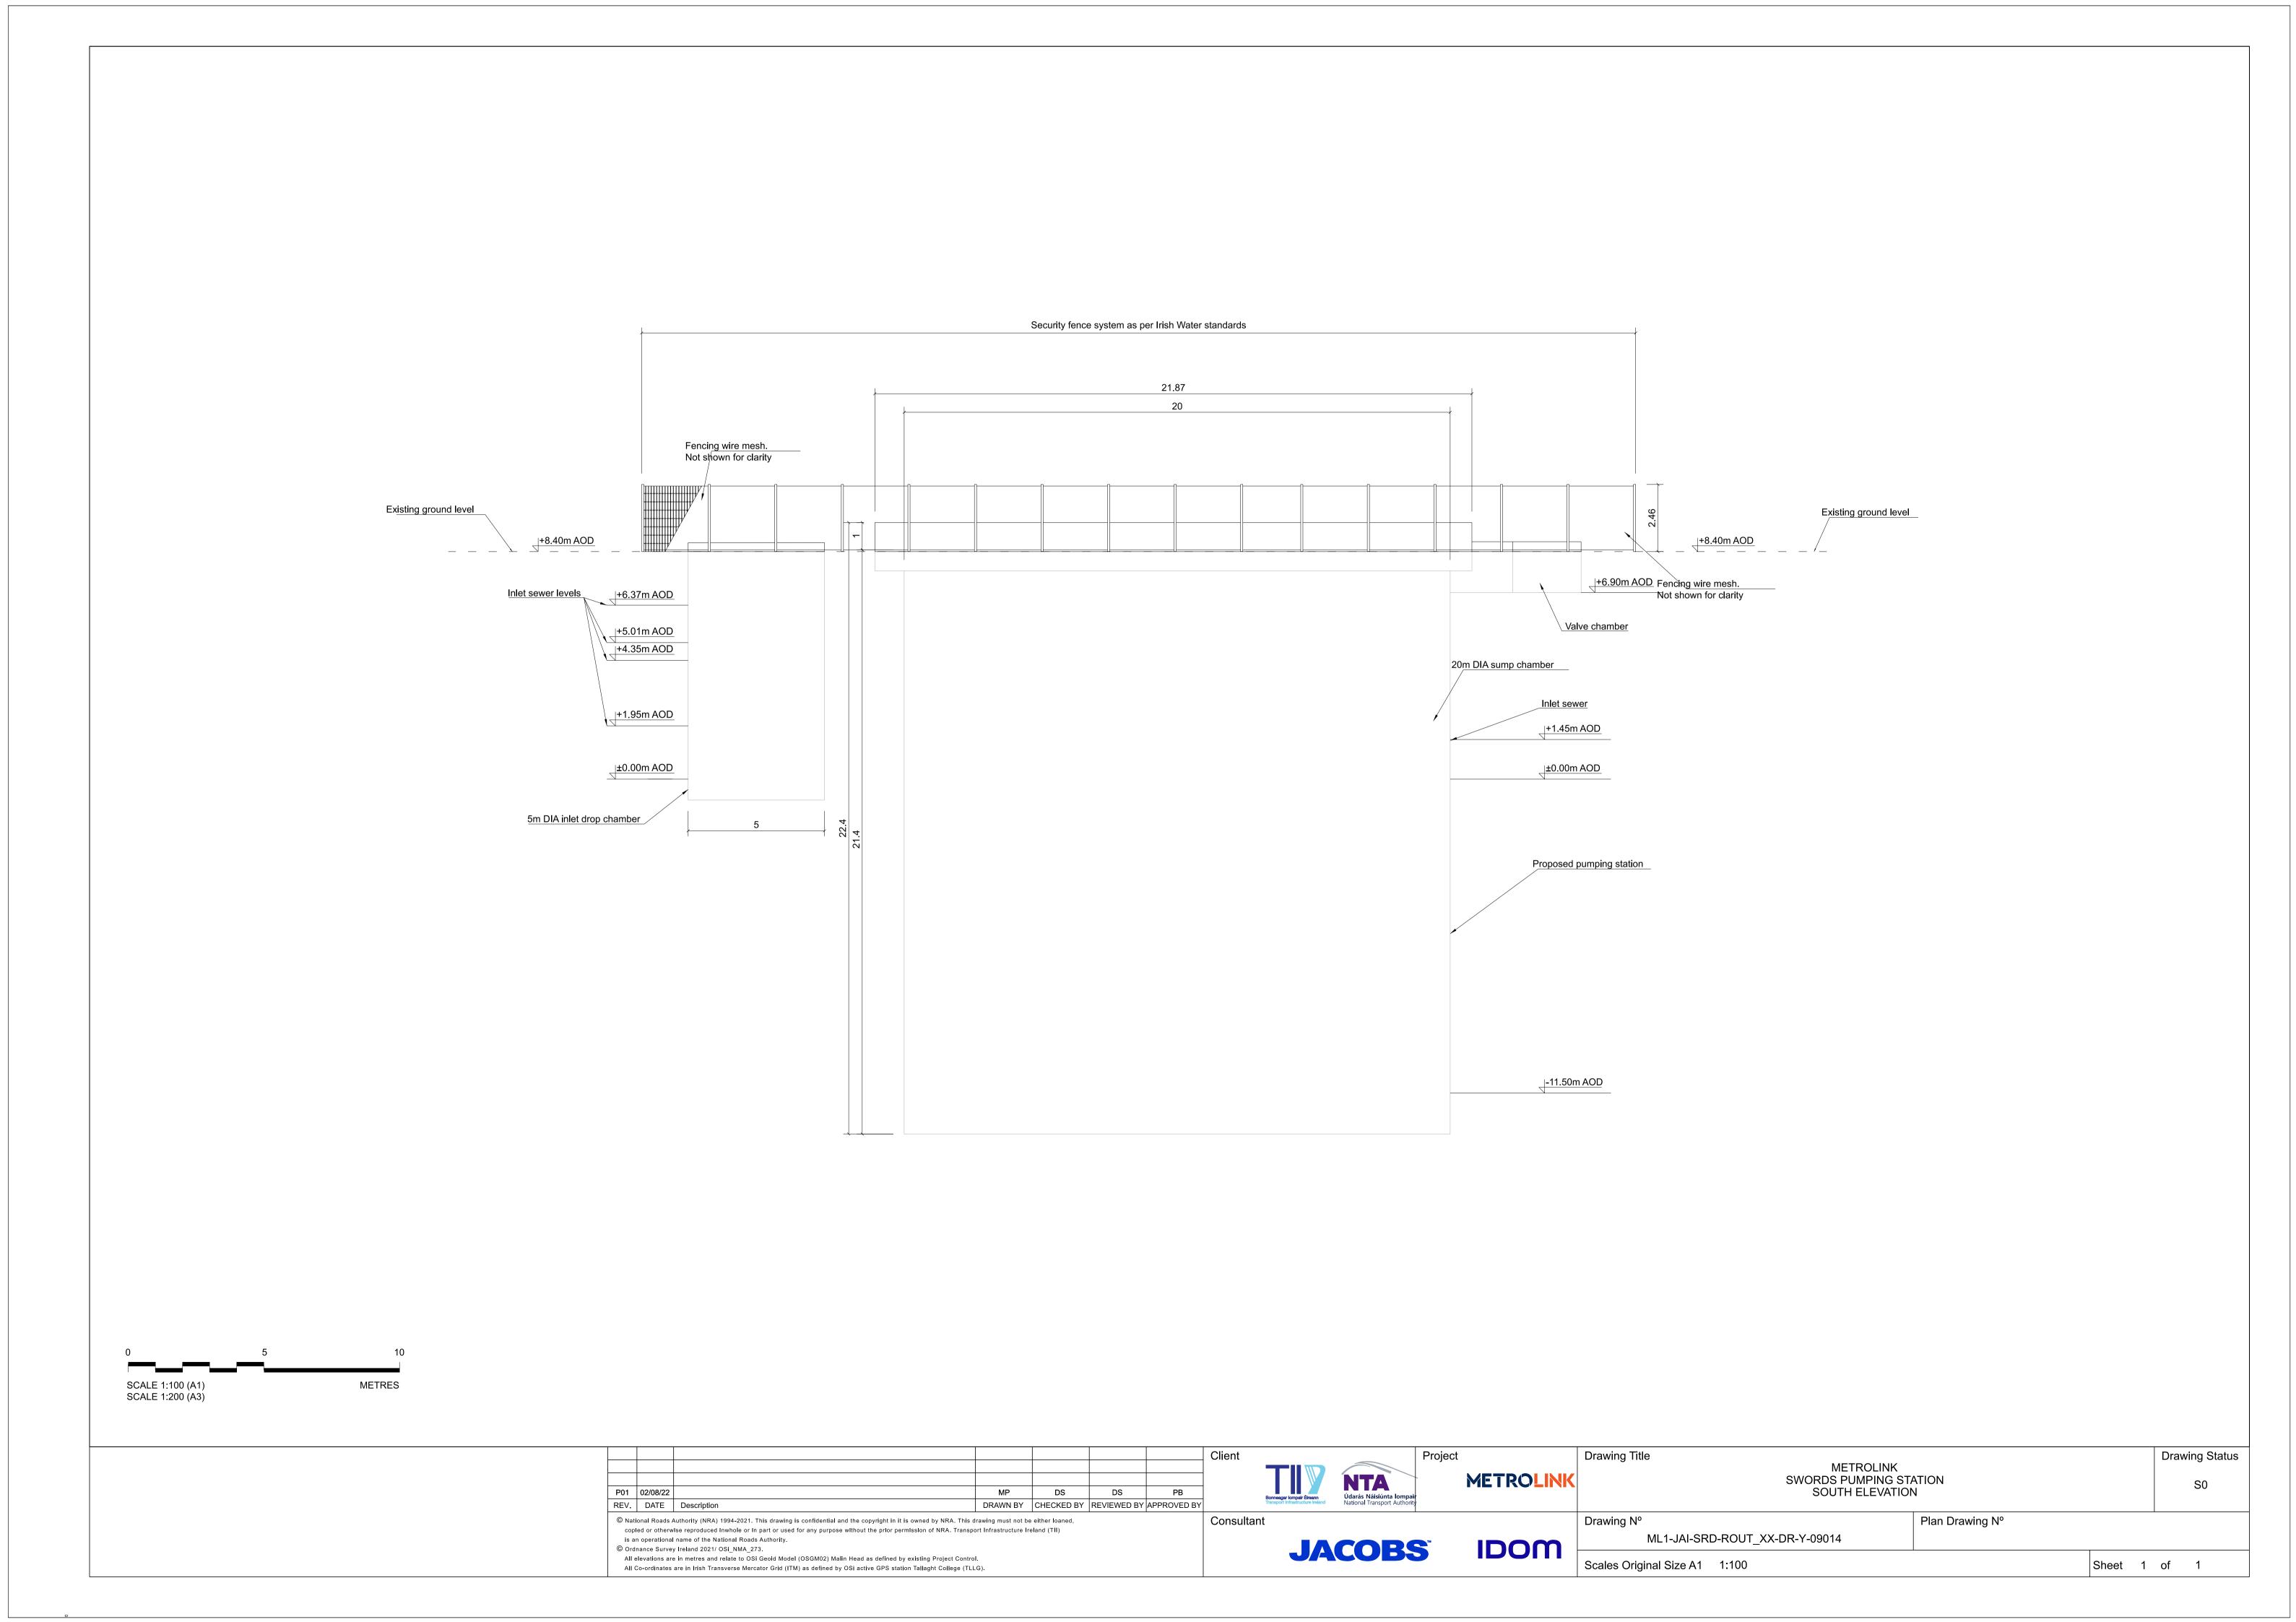


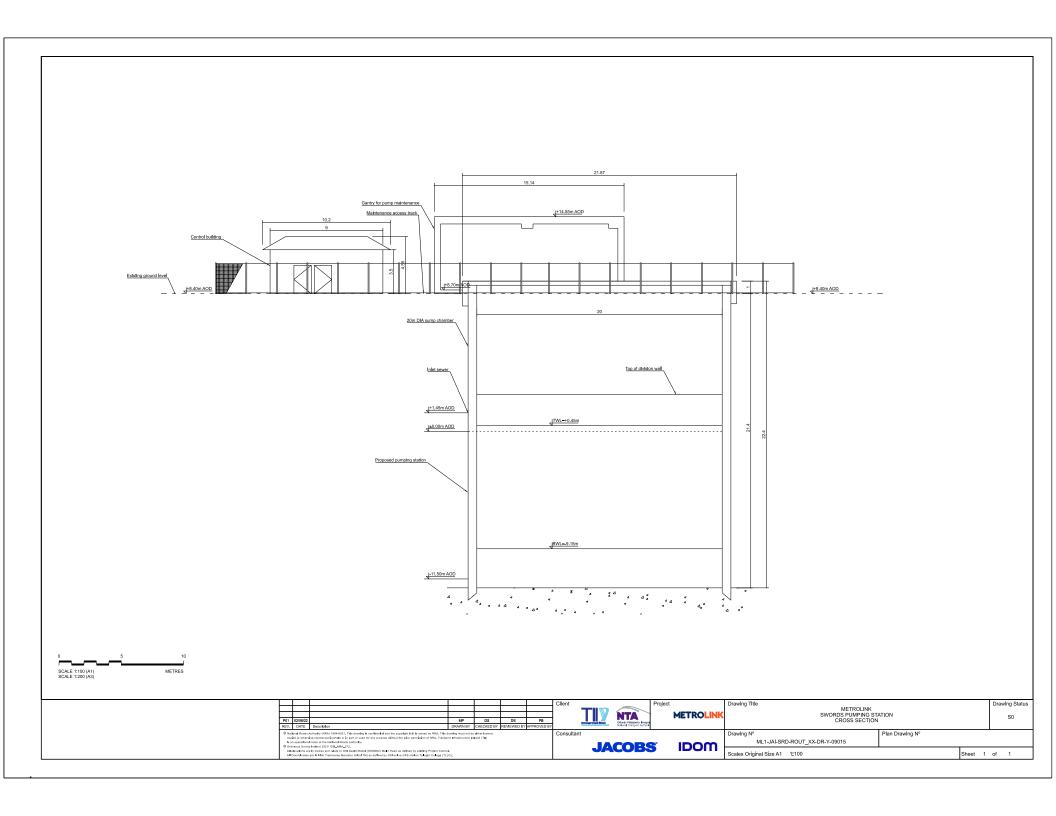





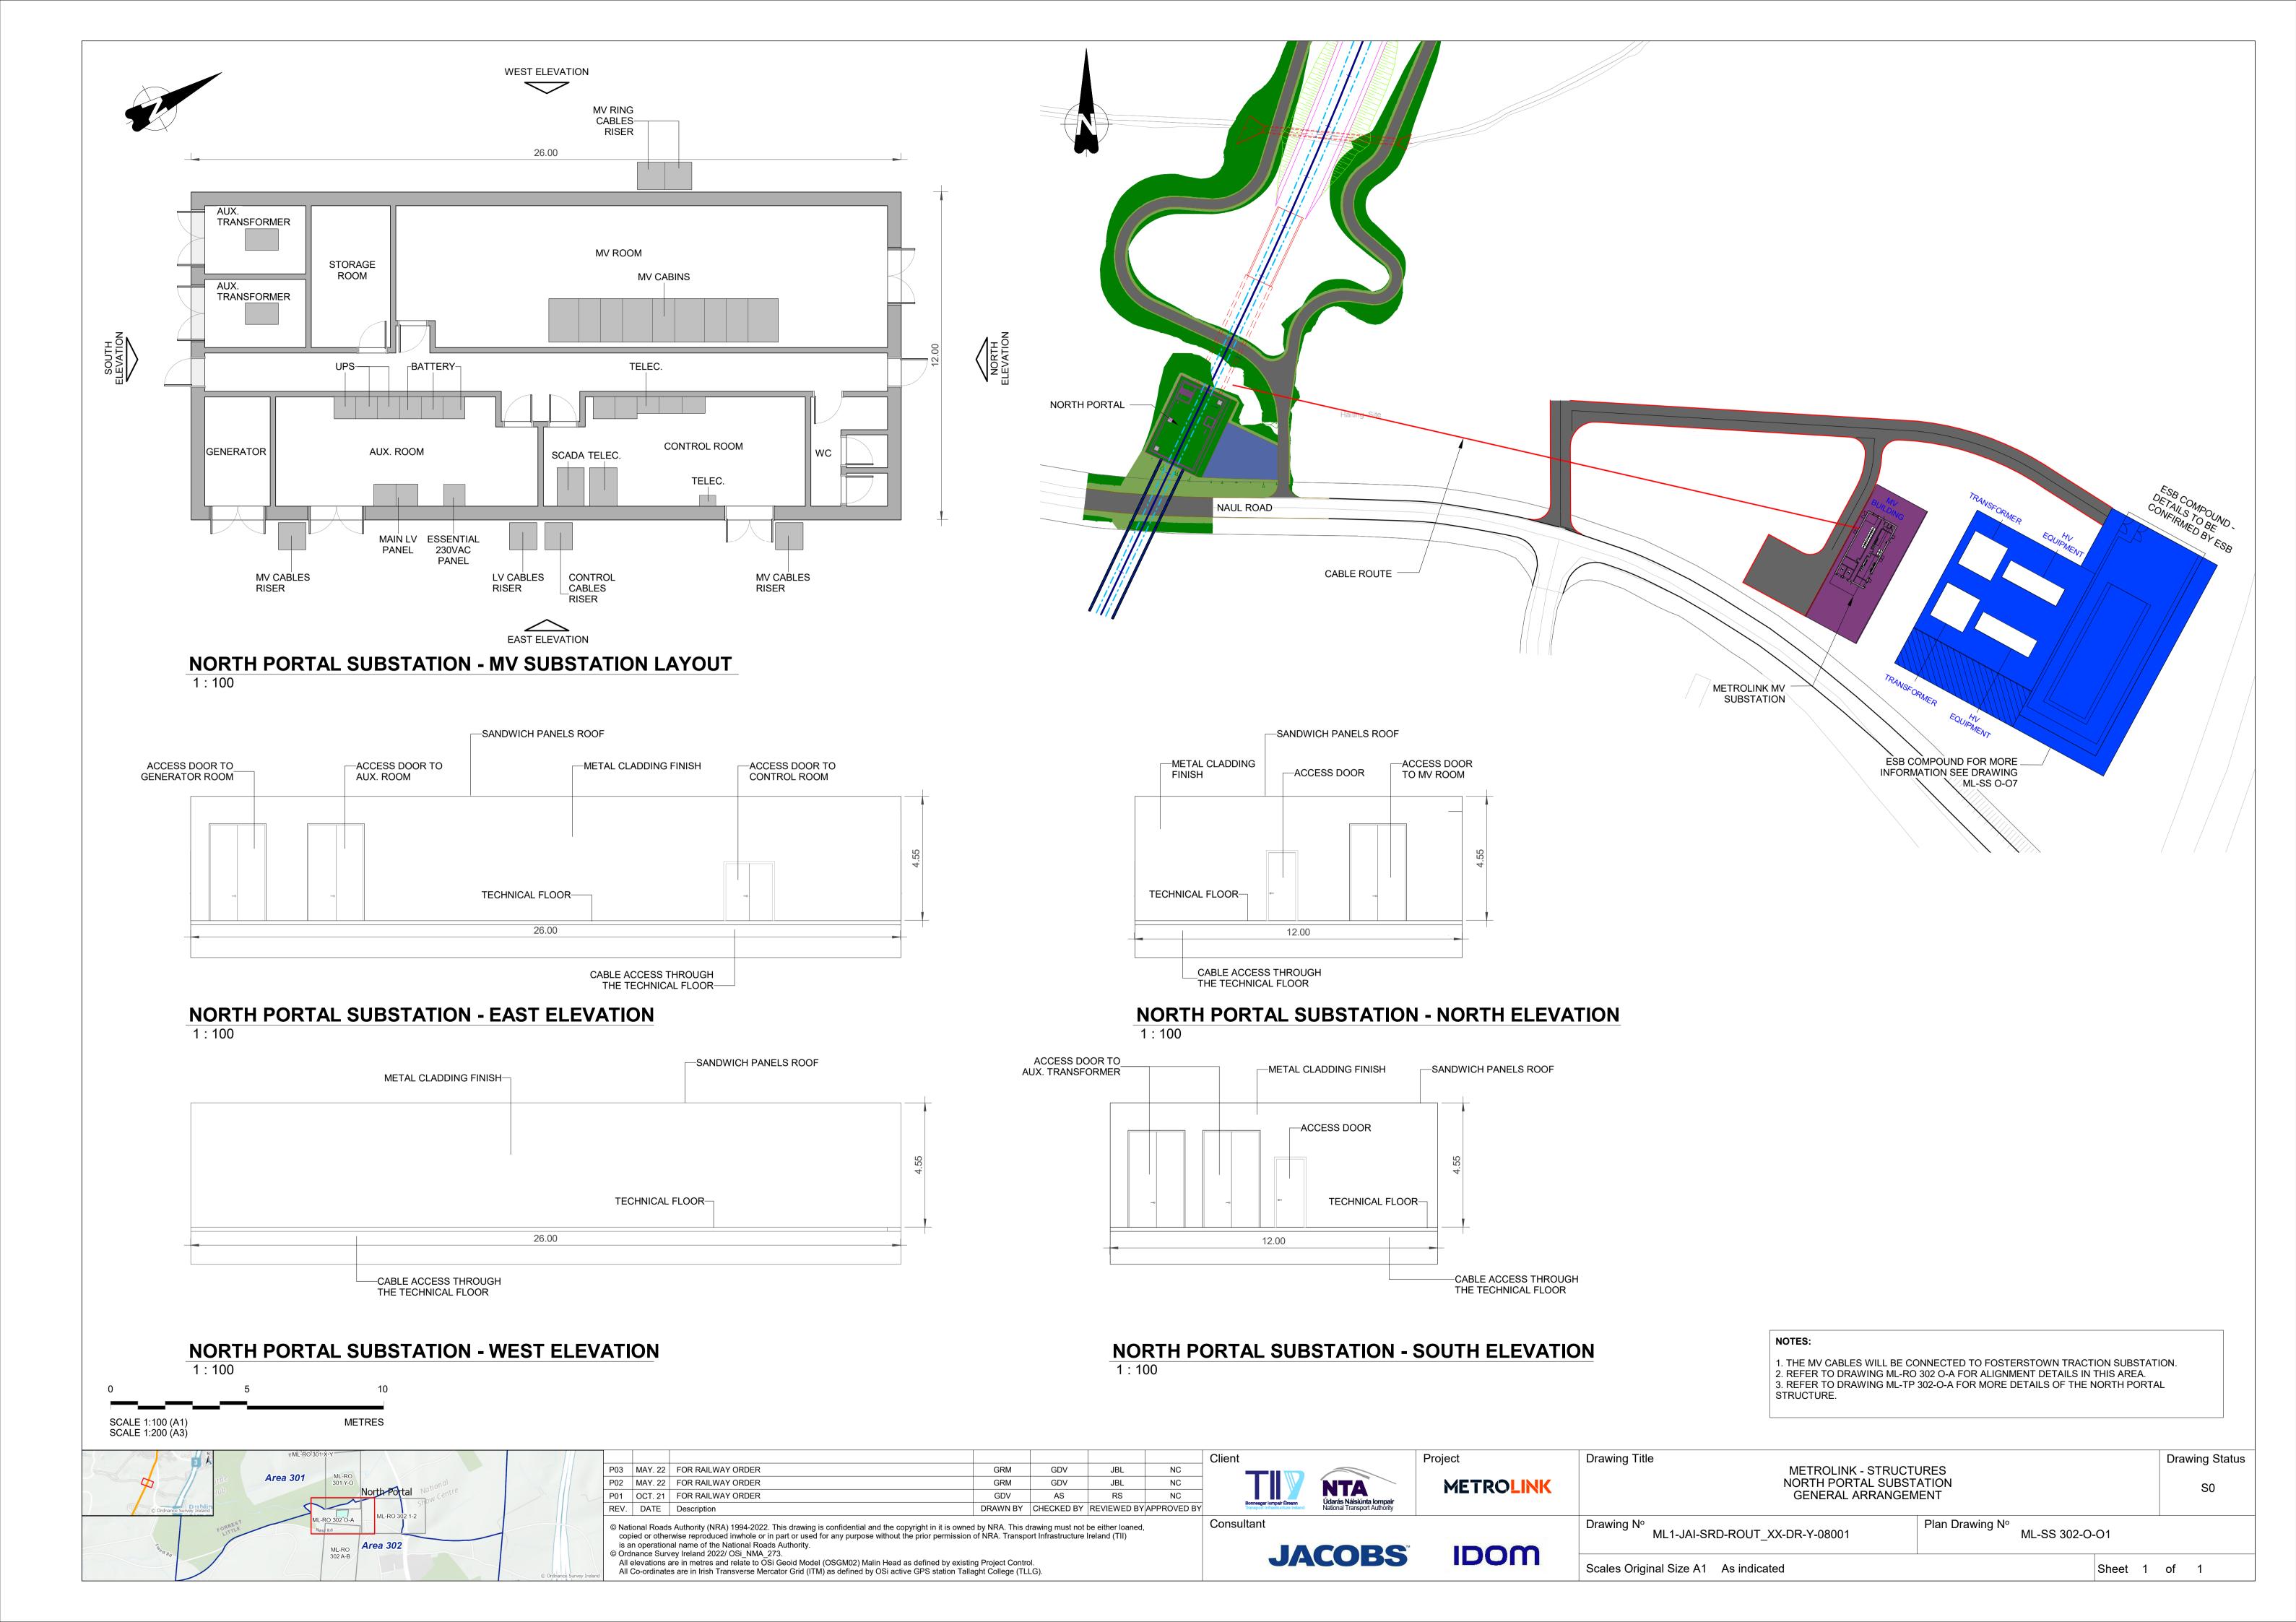

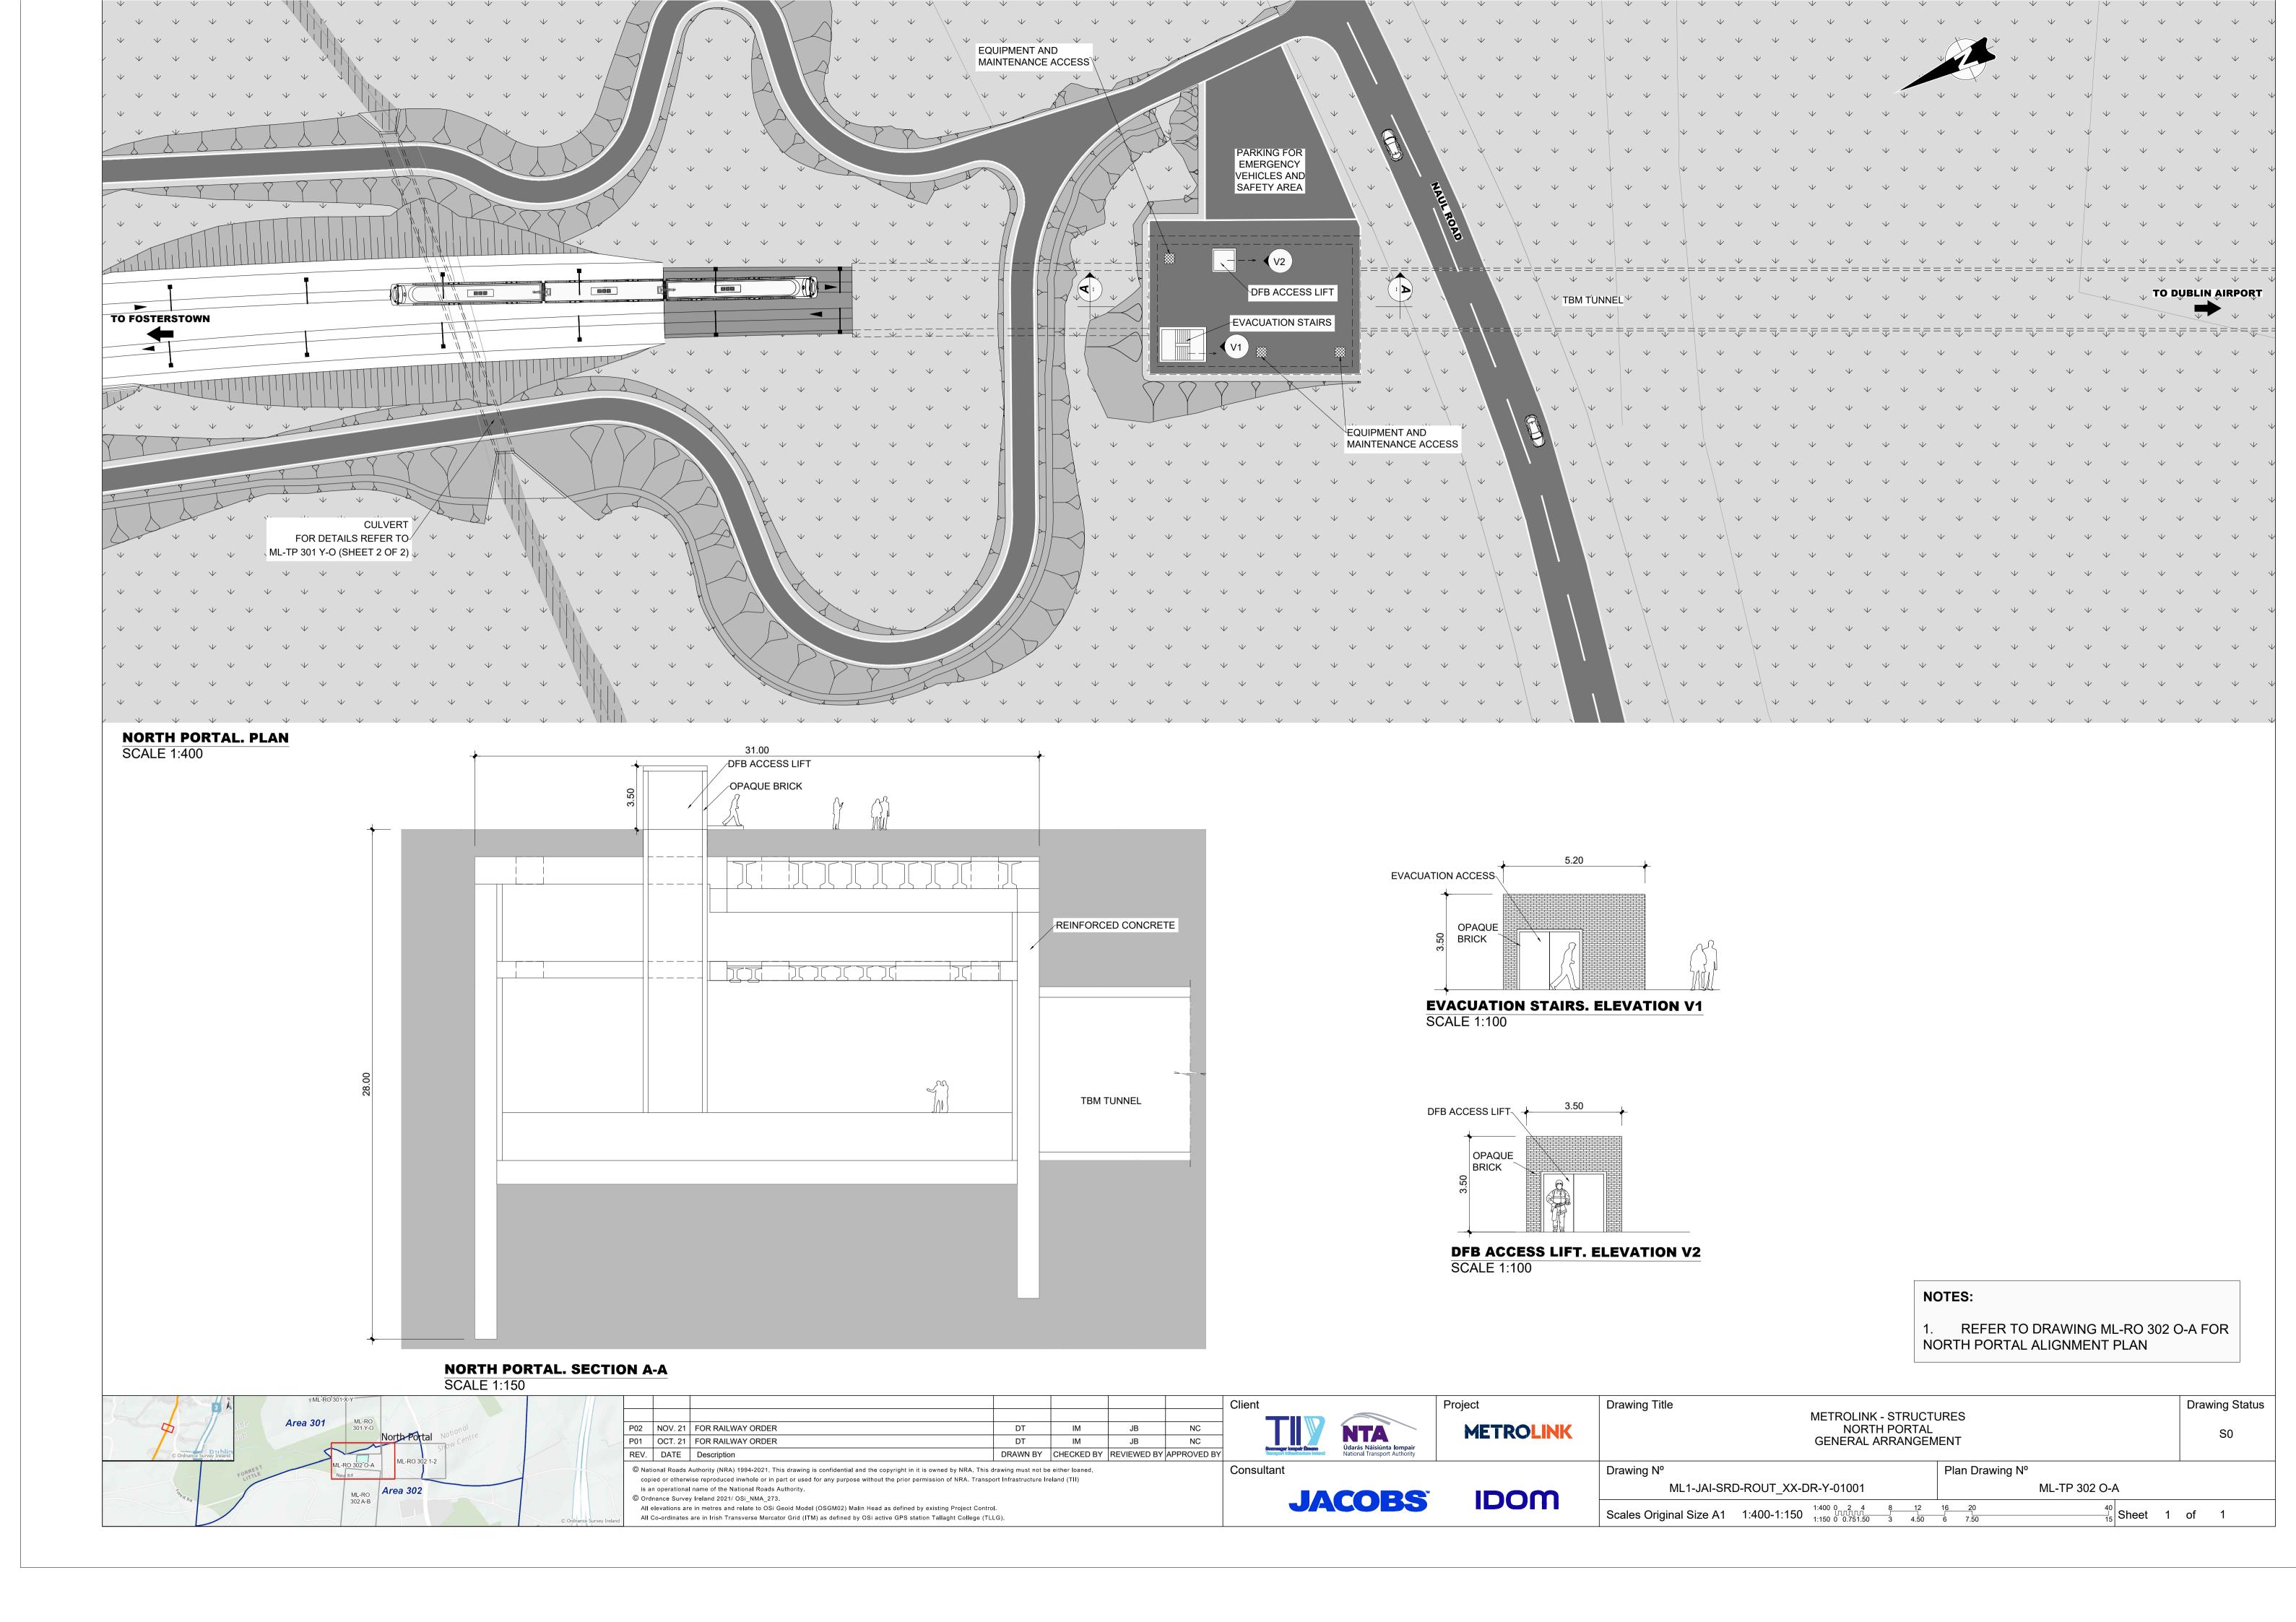

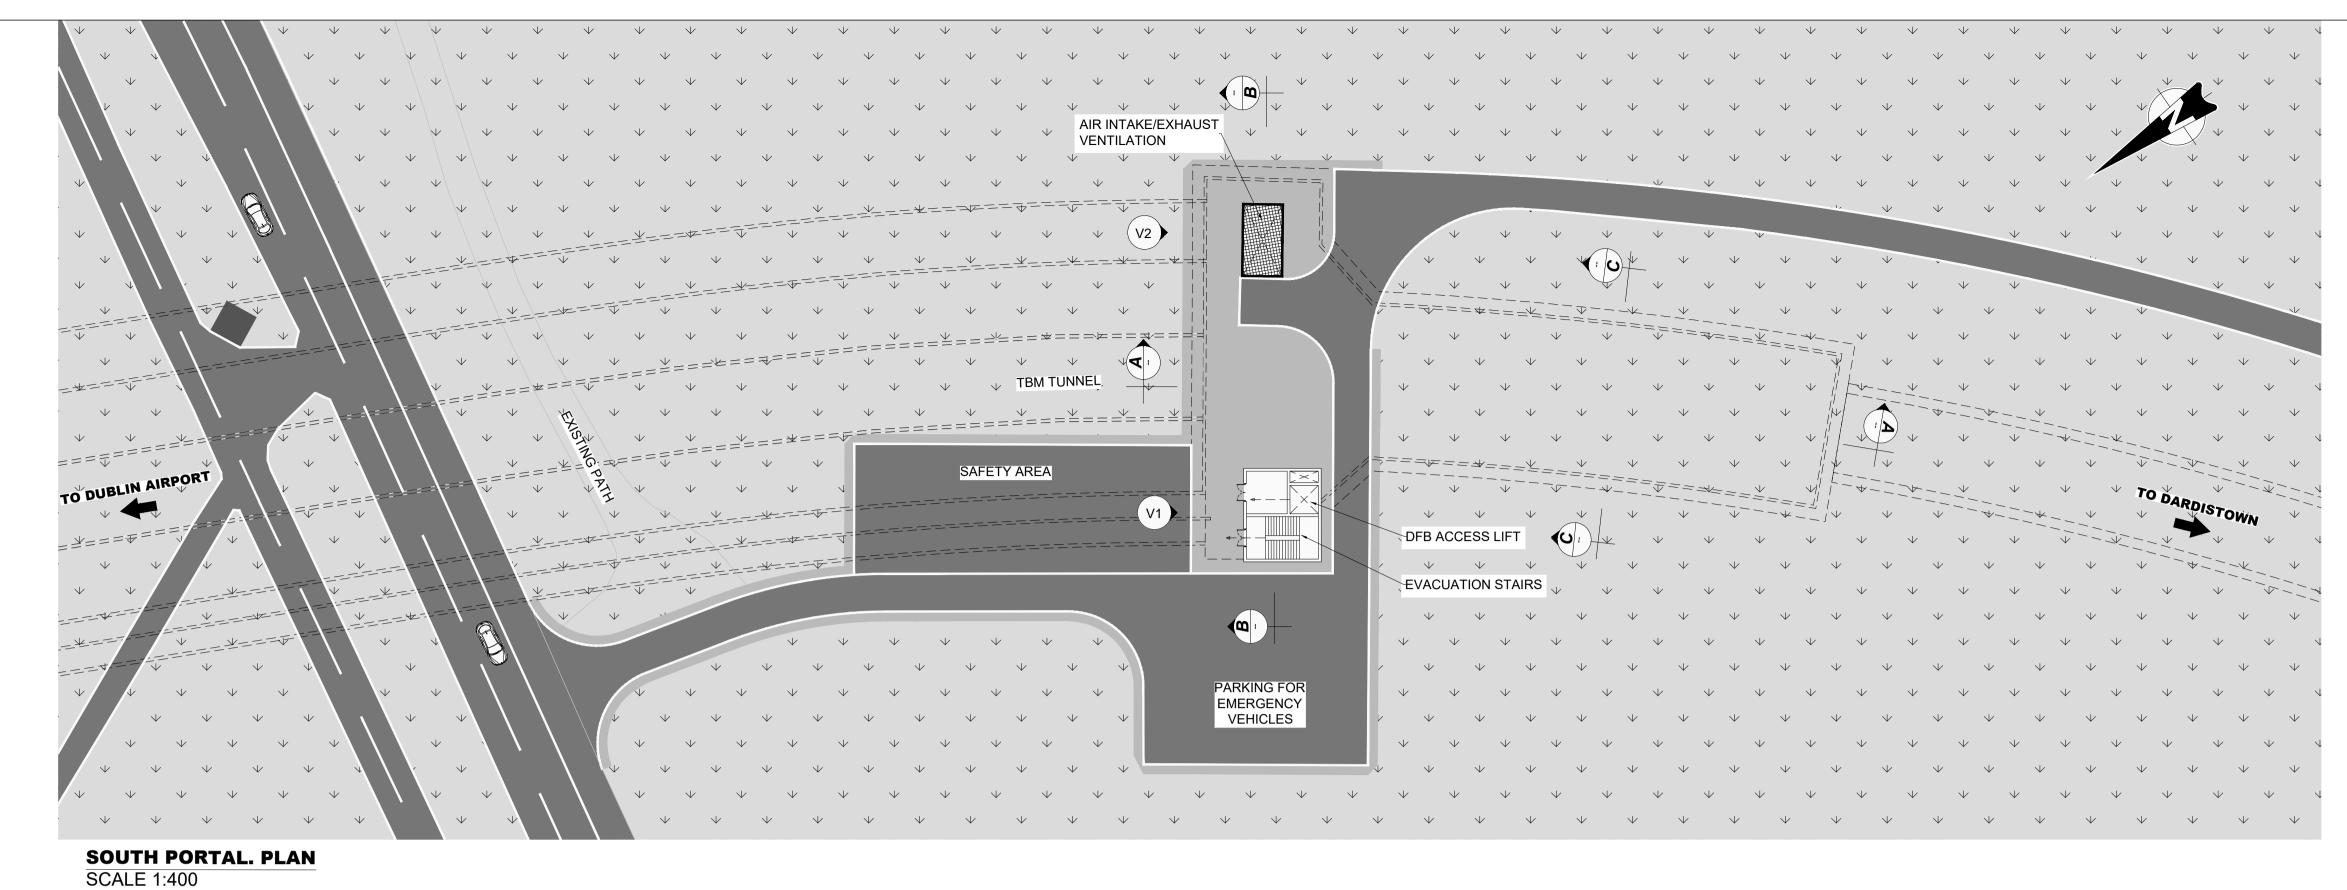

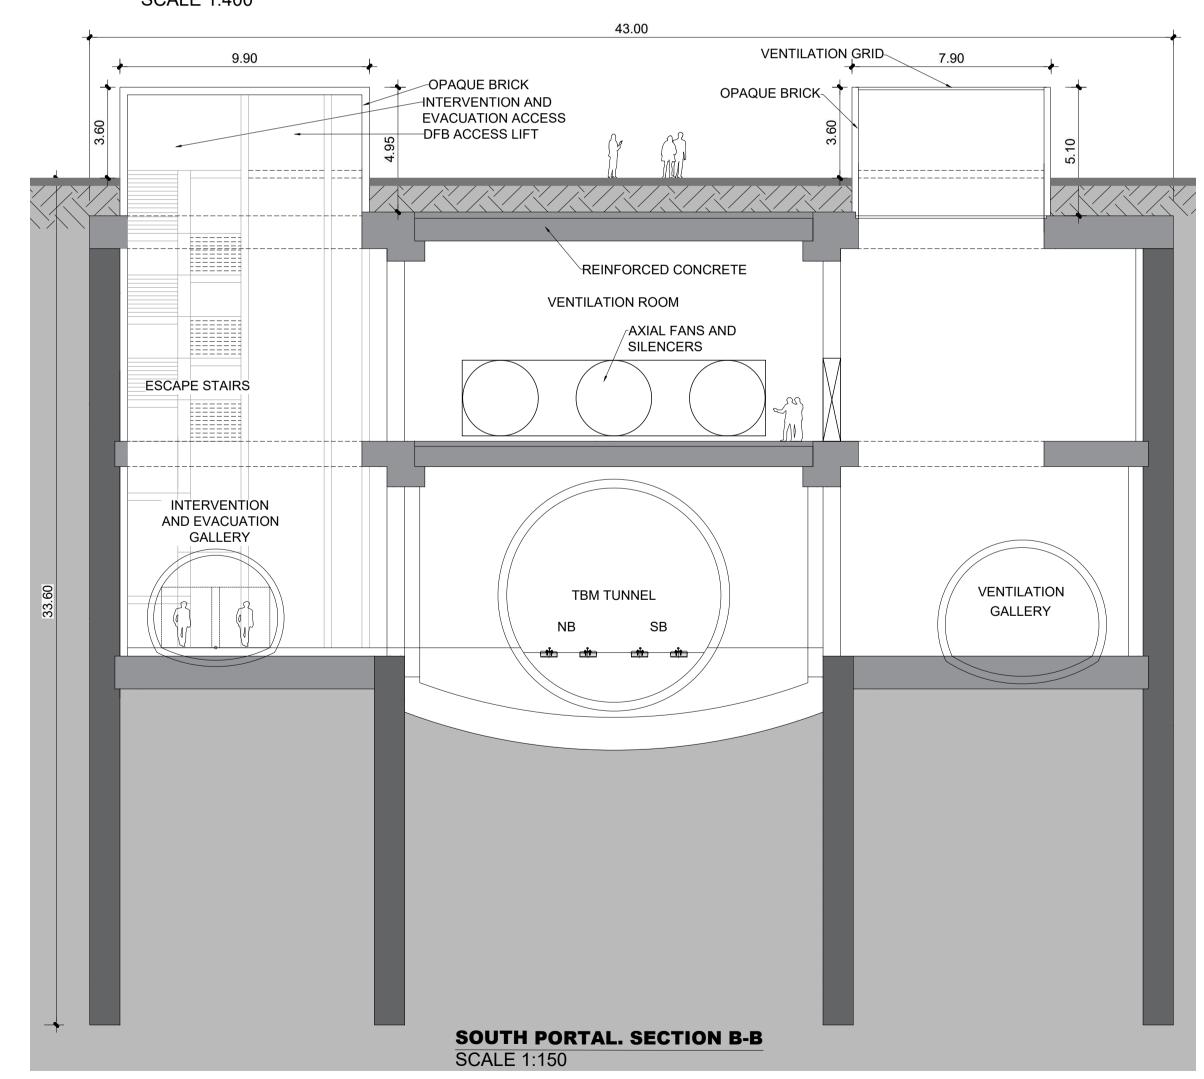

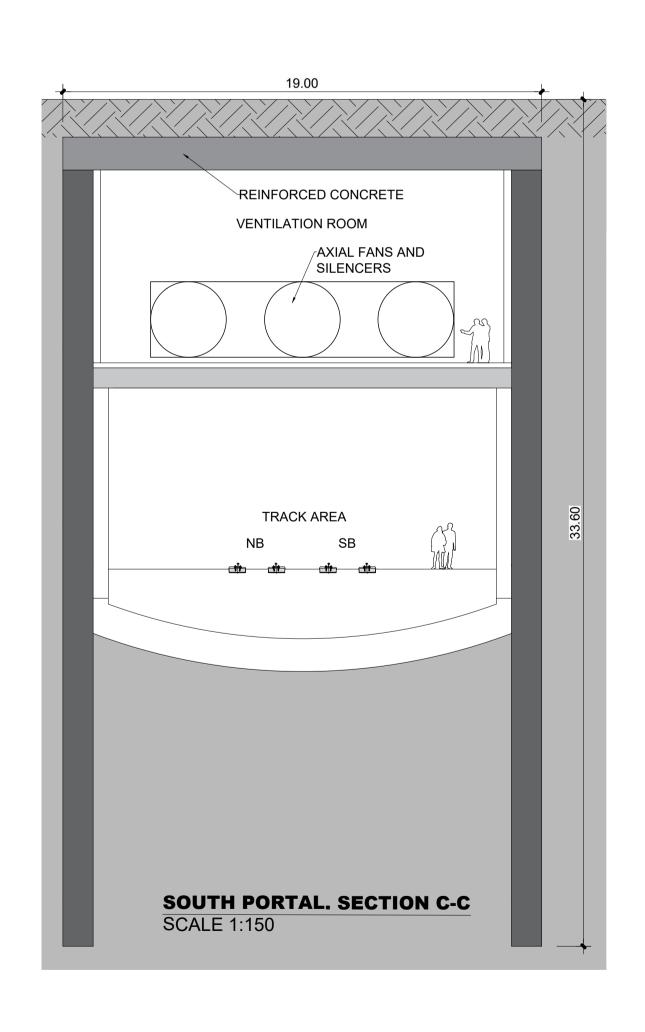

Drawing Title

NOTES:

Plan Drawing N⁰

METROLINK - STRUCTURES

1. REFER TO DRAWING ML-RO 302 E-F FOR SOUTH PORTAL ALIGNMENT PLAN

ML-TP 302 E-F

South Portal ML-RO 303 1-2
P02 NOV. 21 FOR RAILWAY ORDER
P01 OCT. 21 FOR RAILWAY ORDER
DT IM JB NC
P01 OCT. 21 FOR RAILWAY ORDER
DT IM JB NC
REV. DATE Description
REV. DATE Description

© National Roads Authority (NRA) 1994-2021. This drawing is confidential and the copyright in it is owned by NRA. This drawing must not be either loaned,

© National Roads Authority (NRA) 1994-2021. This drawing is confidential and the copyright in it is owned by NRA. This drawing must not be either loaned, copied or otherwise reproduced inwhole or in part or used for any purpose without the prior permission of NRA. Transport Infrastructure Ireland (TII) is an operational name of the National Roads Authority.
© Ordnance Survey Ireland 2021/ OSi_NMA_273.

All elevations are in metres and relate to OSi Geoid Model (OSGM02) Malin Head as defined by existing Project Control.

All Co-ordinates are in Irish Transverse Mercator Grid (ITM) as defined by OSi active GPS station Tallaght College (TLLG).

Client

NTA

Údarás Náisiúnta lompair
National Transport Authority

JACOBS

Project

METROLINK

IDOM

SOUTH PORTAL
GENERAL ARRANGEMENT


Drawing N° Plan
ML1-JAI-SRD-ROUT_XX-DR-Y-01002


Scales Original Size A1 1:400-1:150 1:400 0 2 4 8 12 16 20 1:150 0 0.751.50 3 4.50 6 7.50


S0


 $\frac{^{40}}{^{15}}$ Sheet 1 of 2


Drawing Status

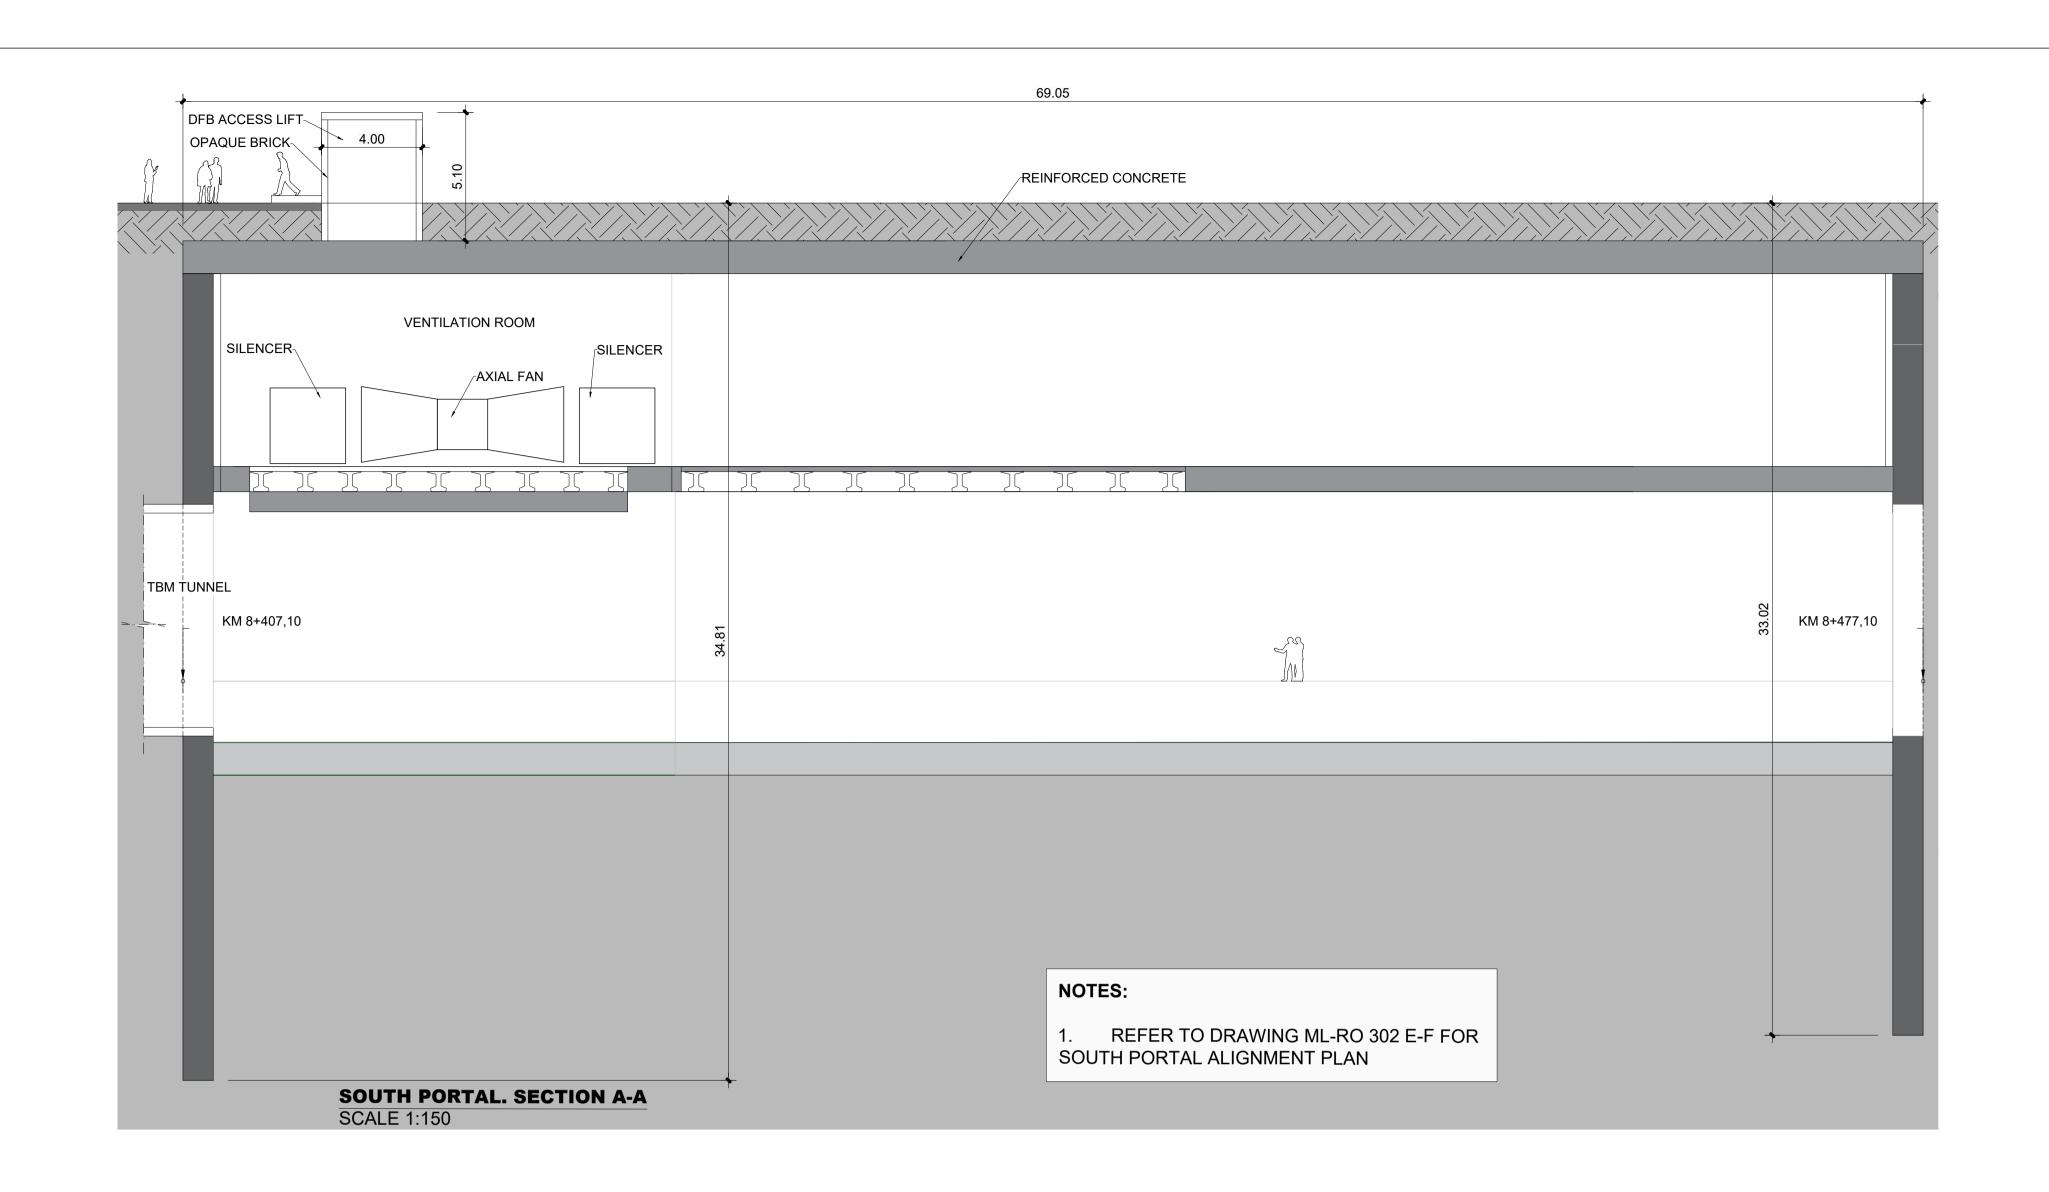

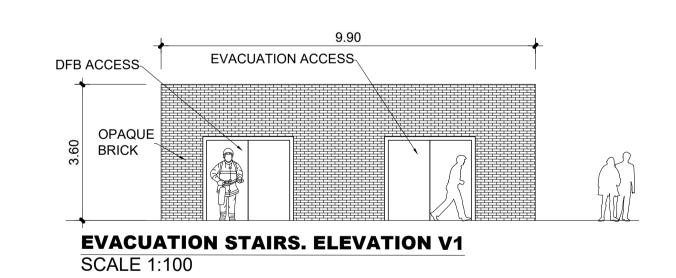

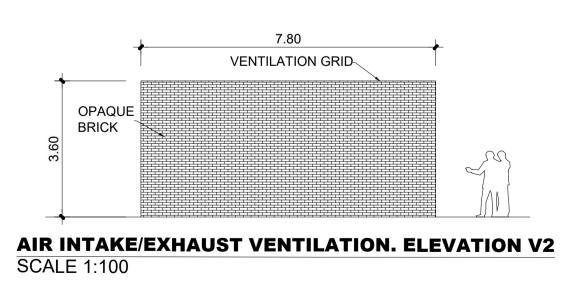


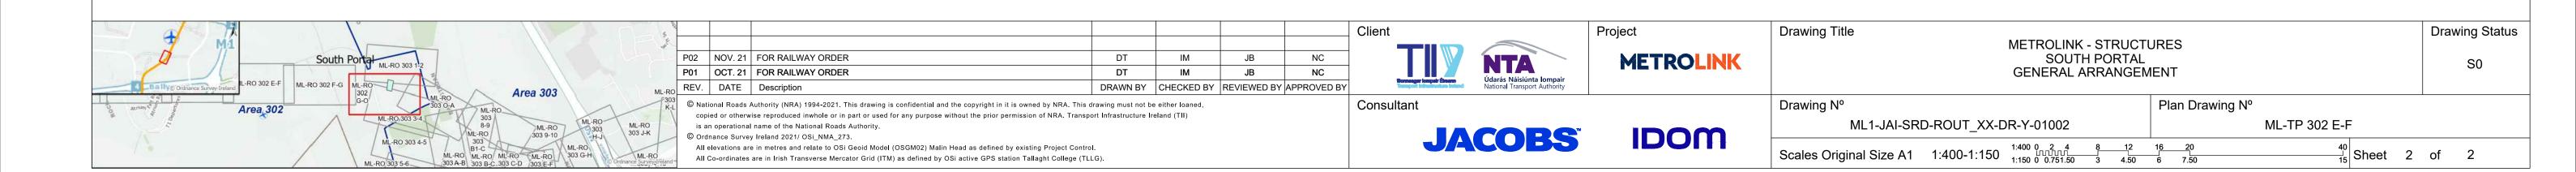


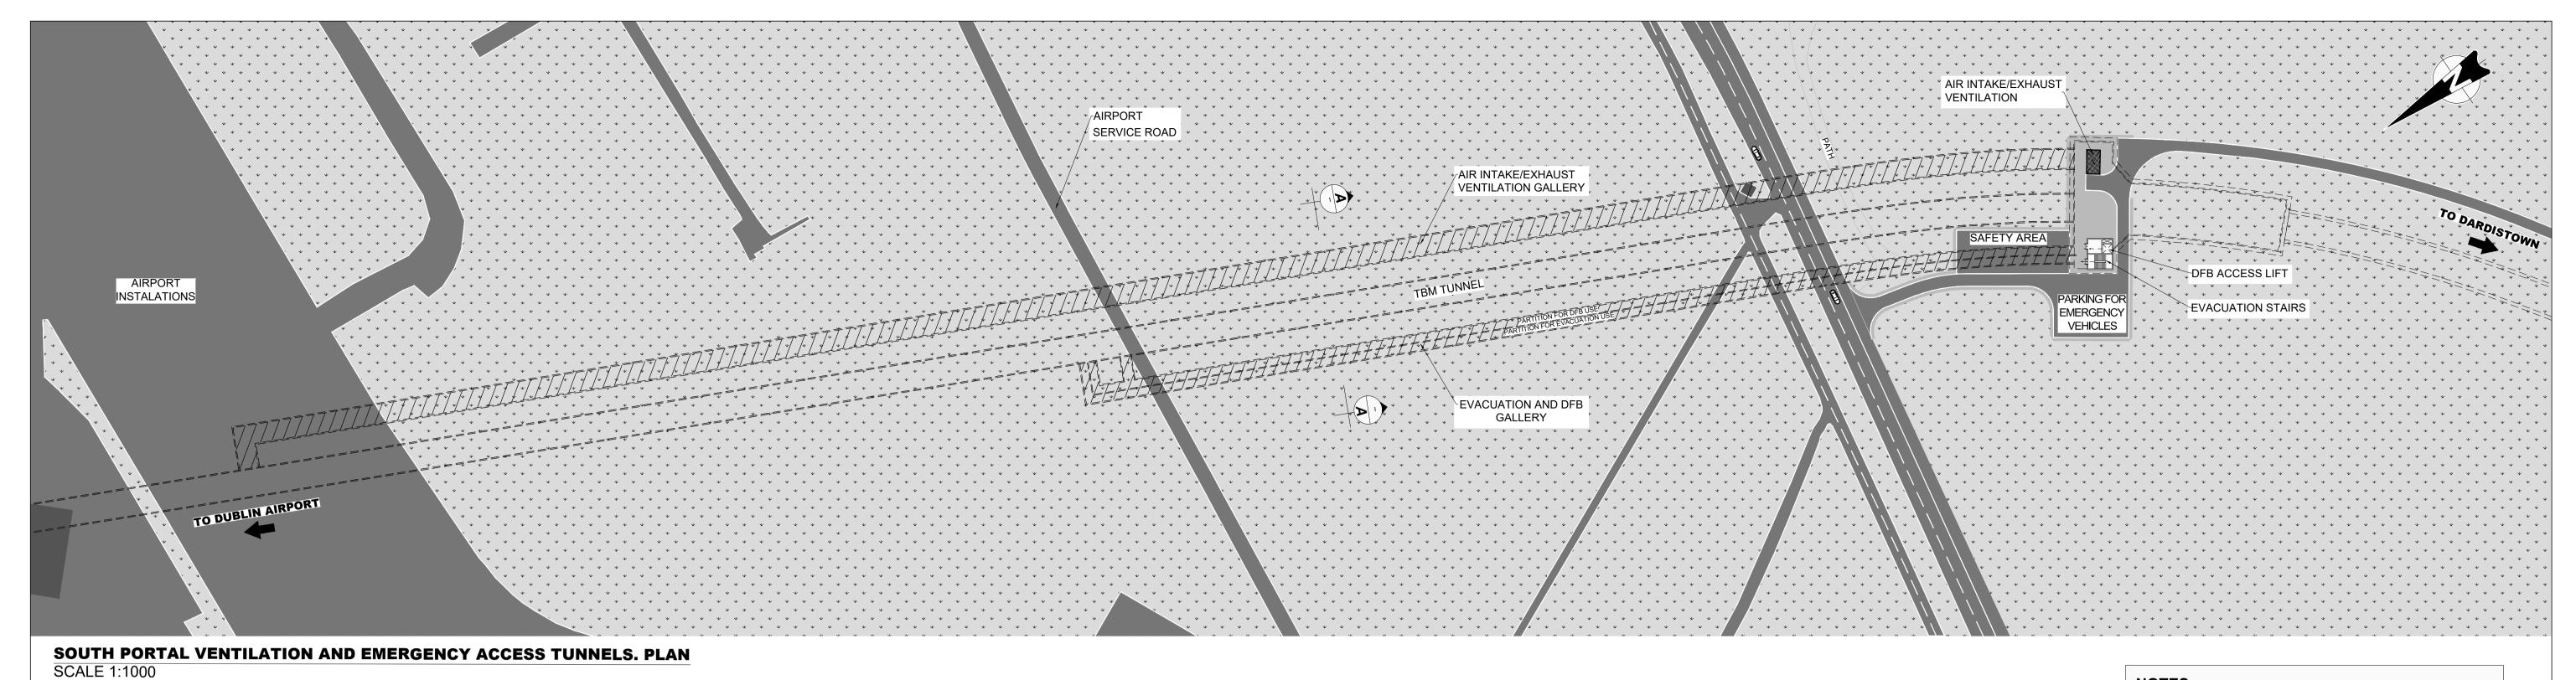



NOTES:

1. REFER TO DRAWING ML-RO 302 E-O FOR SOUTH PORTAL ALIGNMENT PLAN

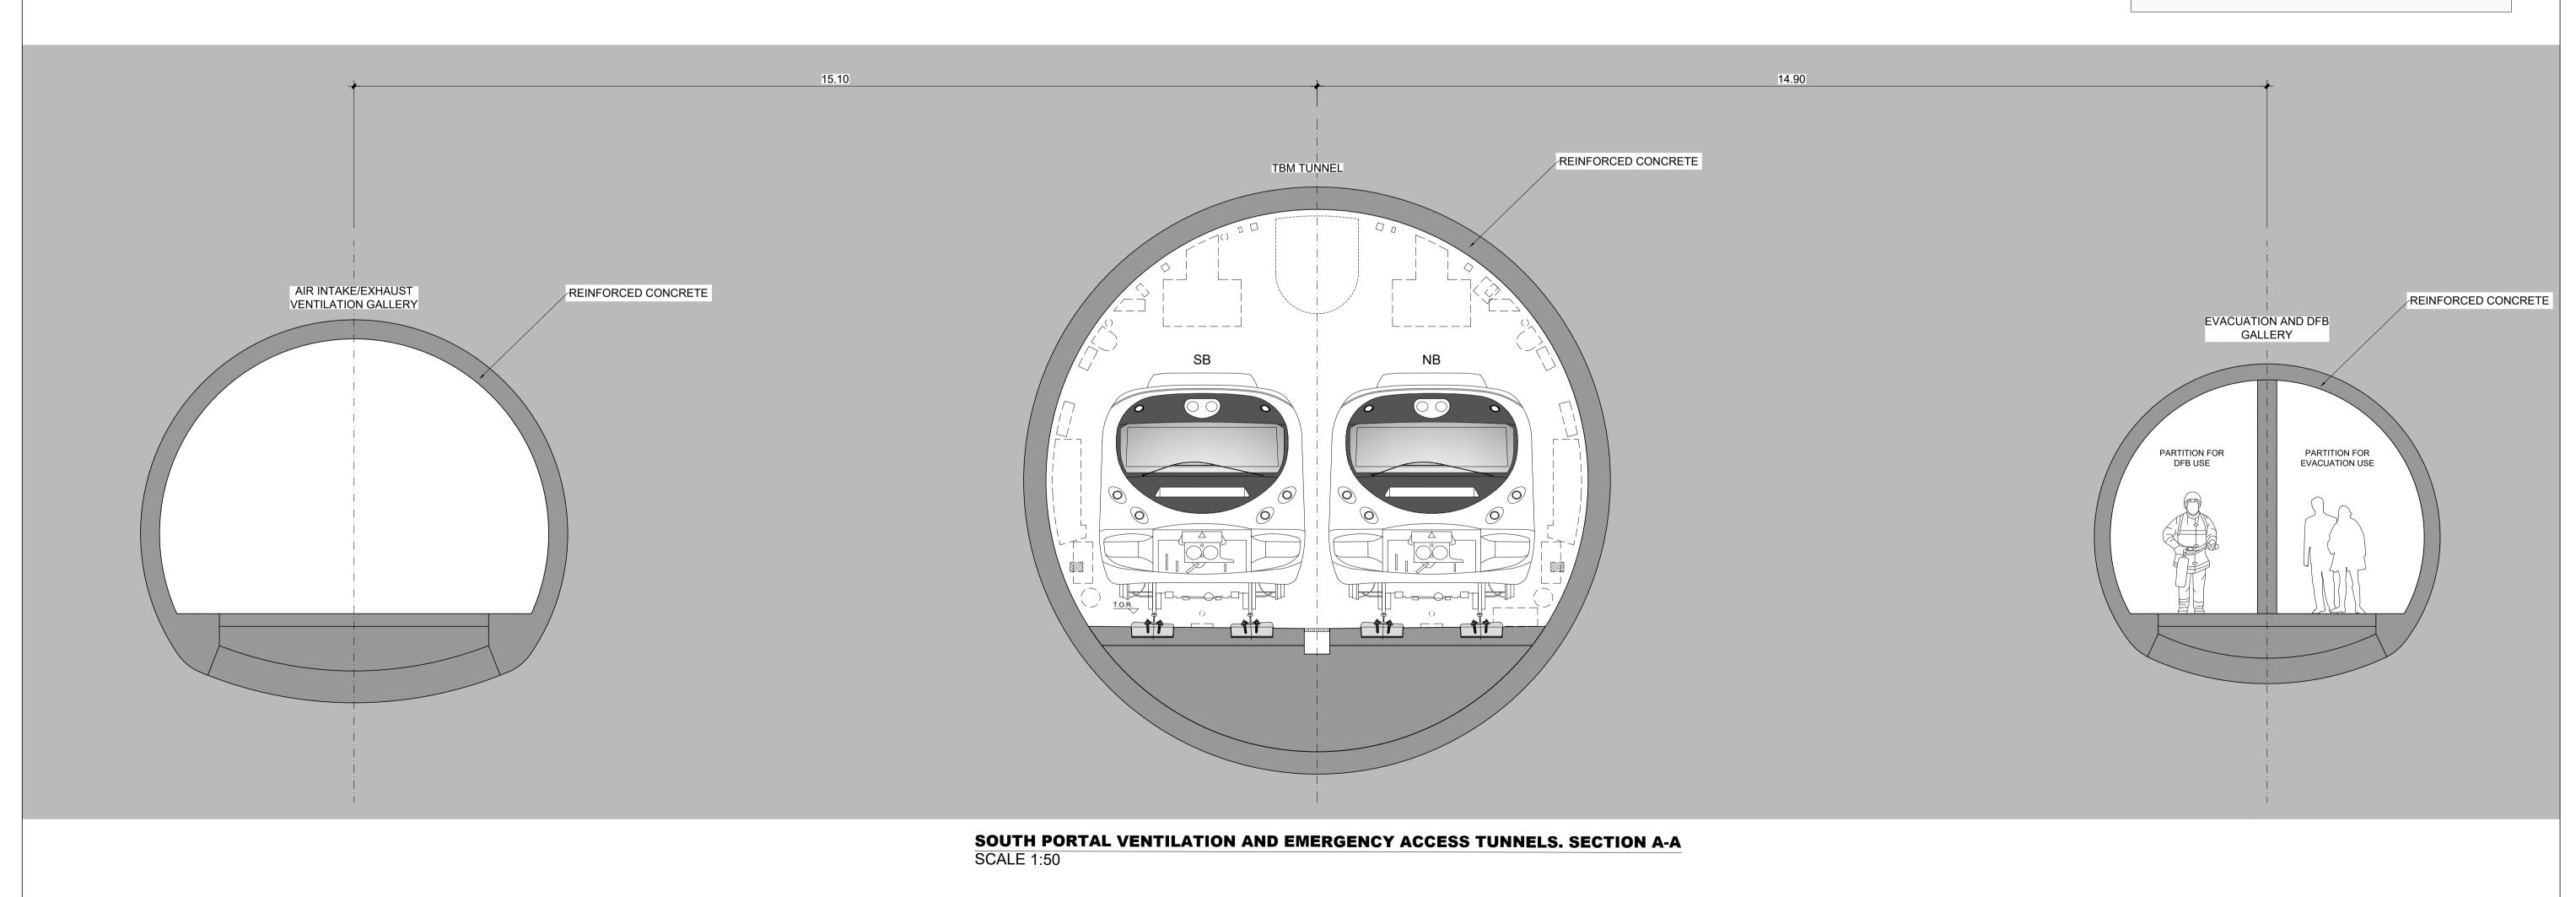


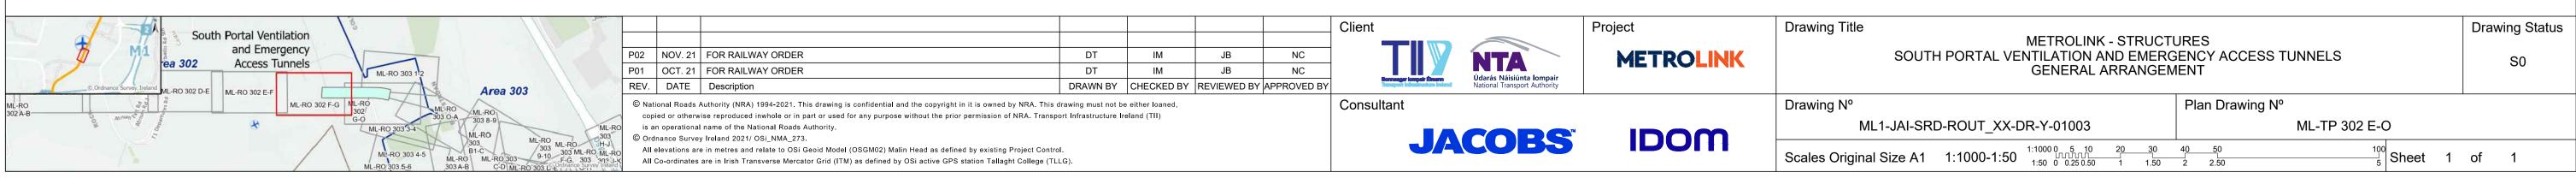


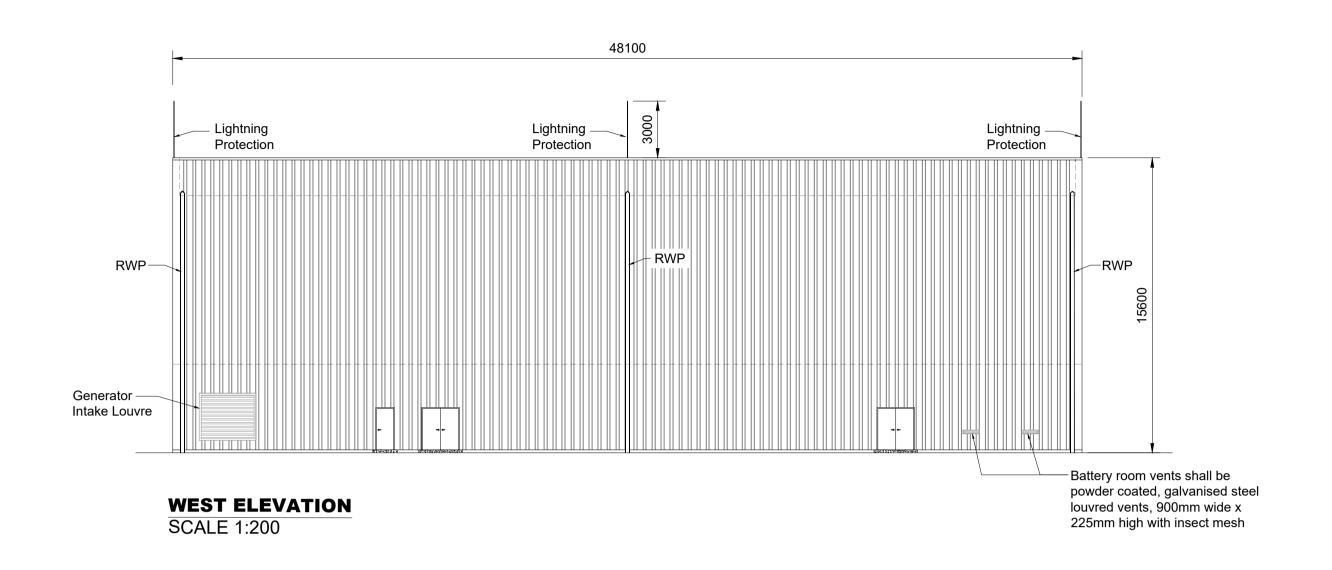

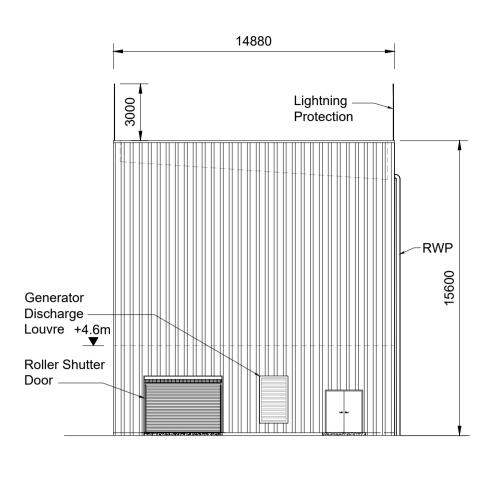


NORTH ELEVATION
SCALE 1:200

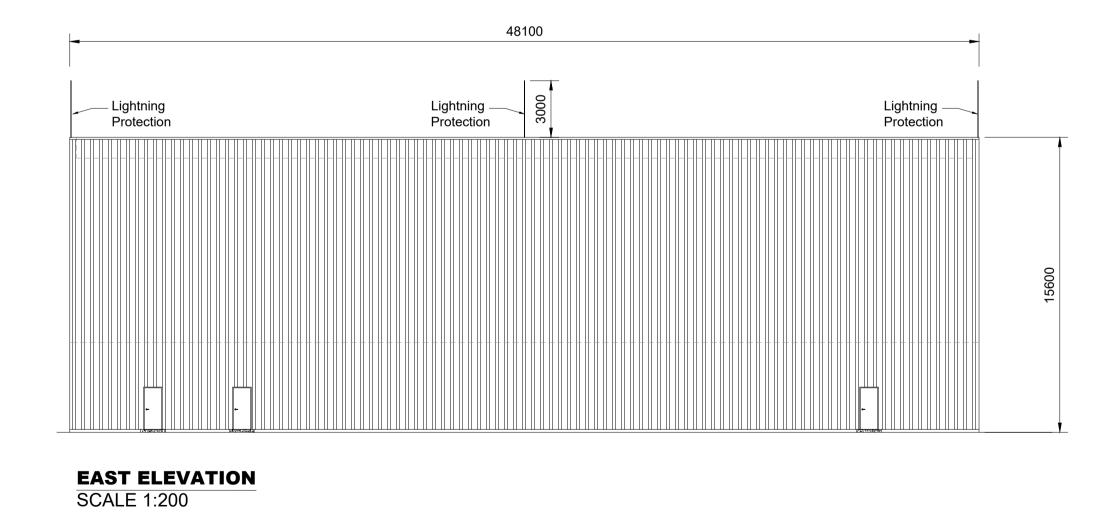

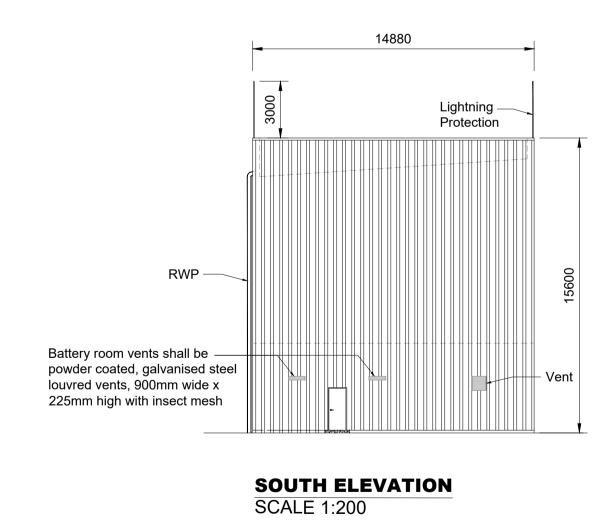

3 N FML-RO 301-X-Y			Client	Project	Drawing Title ESBN	Drawing Status
Area 301 ML-RO 301 Y-O North Portal National Show Centre	P01 MAY. 22 FOR RAILWAY ORDER DT REV DATE Description DRAWN BY	MC JB NC CHECKED BY REVIEWED BY APPROVED B	V Someon longal favors Vidarás Náisiúnta lompair National Transport Authority	METROLINK	HV SURFACE SUBSTATION -	NORTH PORTAL S0
ML-RO 302 0-A ML-RO 302 1-2 ML-RO 302 1-2 ML-RO 302 1-2	© National Roads Authority (NRA) 1994-2022. This drawing is confidential and the copyright in it is owned by NRA. This drawing must not be copied or otherwise reproduced inwhole or in part or used for any purpose without the prior permission of NRA. Transport Infrastructure is an operational name of the National Roads Authority. © Ordnance Survey Ireland 2021/ OSi NMA 273.	be either loaned,	Consultant	IDOM	Drawing N° ML1-JAI-SRD-ROUT_XX-DR-Y-08009	Plan Drawing N° ML-SS O-O7
© Ordnance Survey Ire	All elevations are in metres and relate to OSi Geoid Model (OSGM02) Malin Head as defined by existing Project Control. All Co-ordinates are in Irish Transverse Mercator Grid (ITM) as defined by OSi active GPS station Tallaght College (TLLG).		JACOB5	IDOM	Scales Original Size A1 1:200	§ 10 Sheet 1 of 1

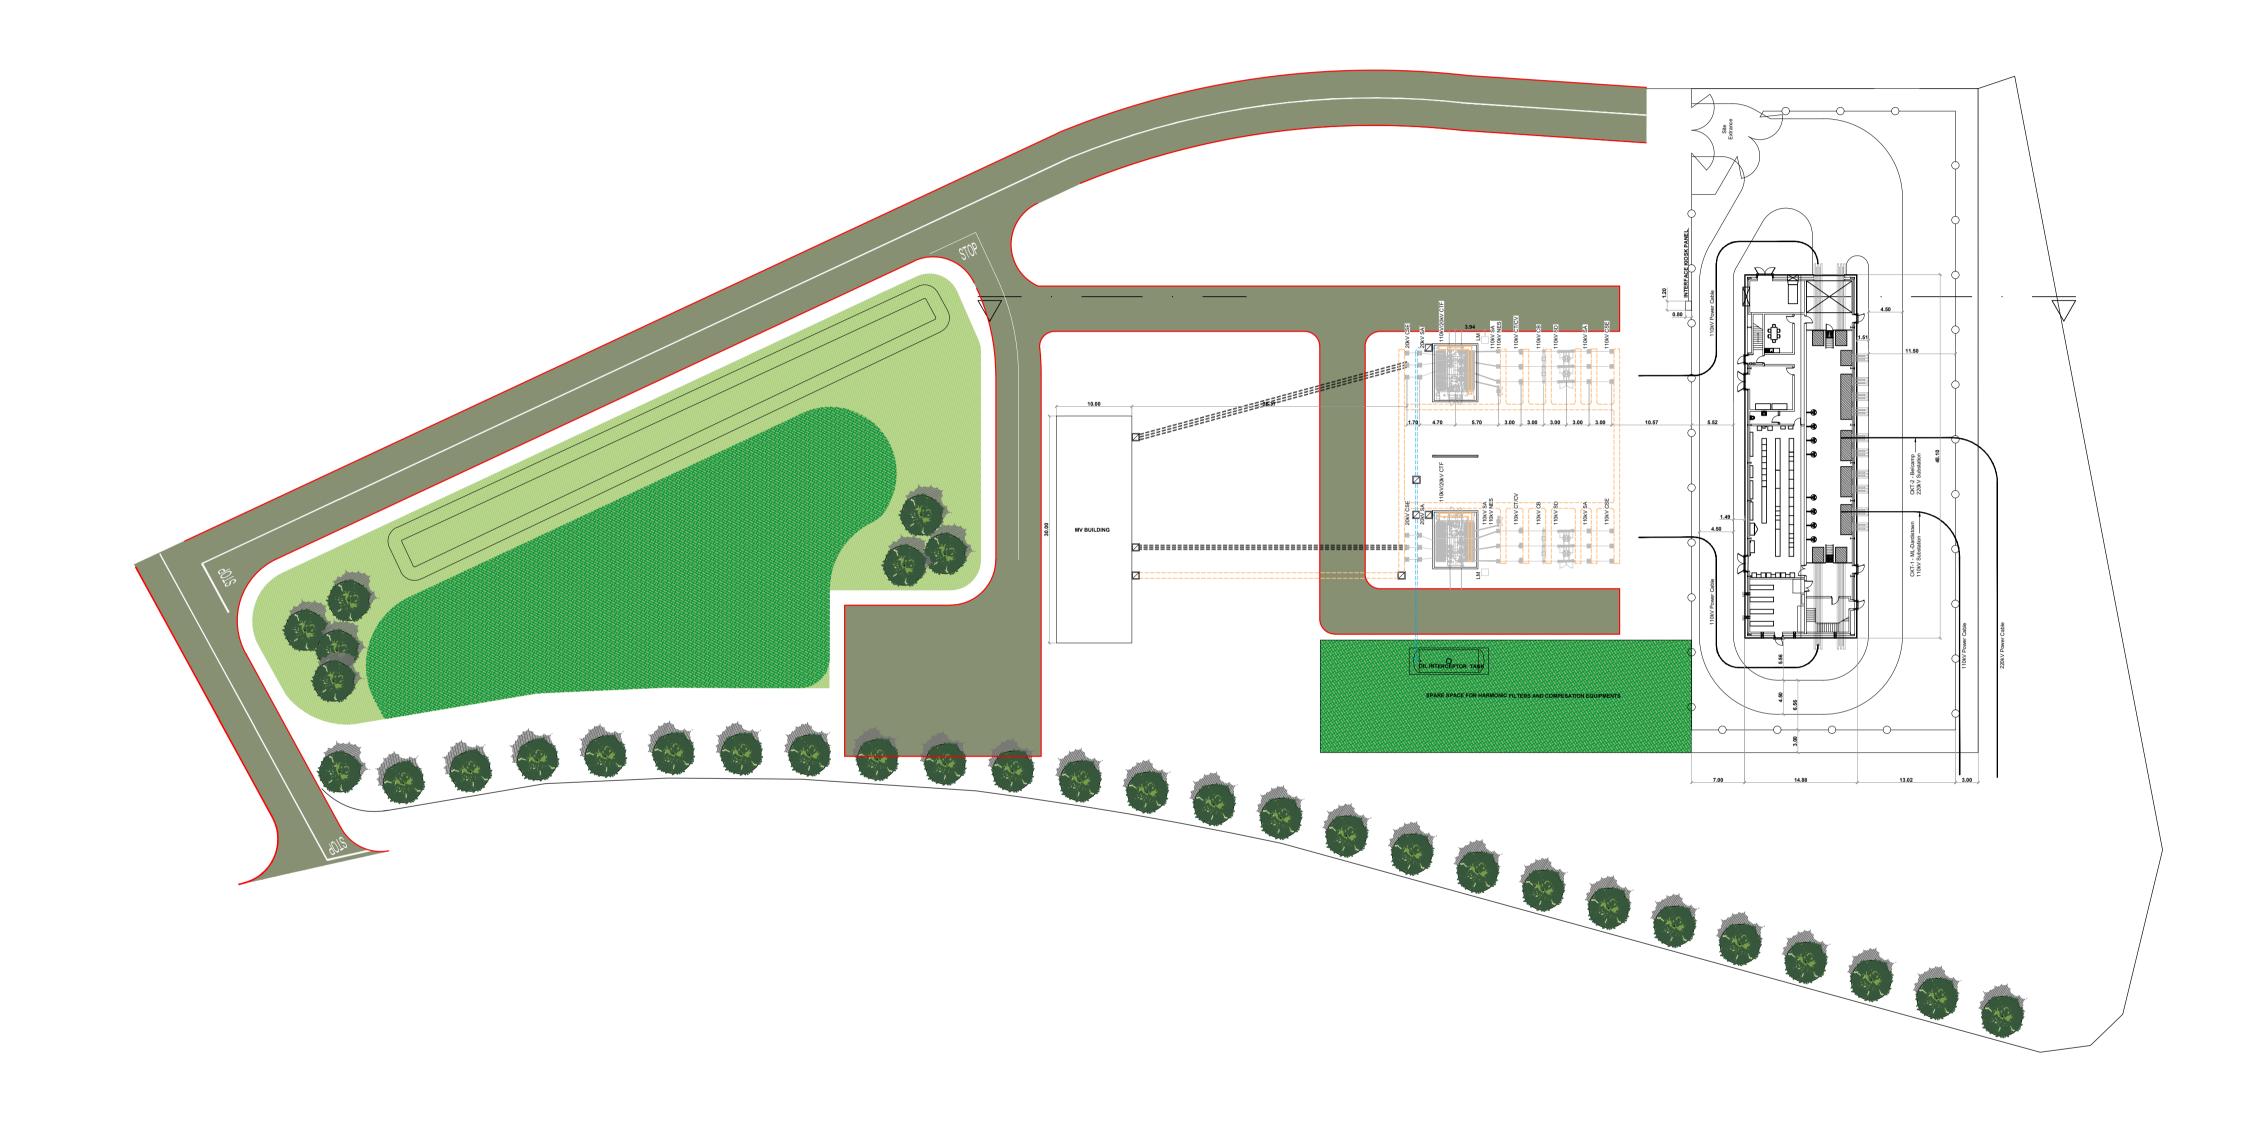

NOTES

NOTE 1: THIS DRAWING IS A CONCEPTUAL DESIGN. ALL DIMENSIONS, REFERENCES (EG. LIGHTNING MAST LOCATIONS ETC.) GIVEN ARE INDICATIVE ONLY AND SHOULD NOT BE USED AS PART OF A DETAILED DESIGN. ESBN BUILDING DIMENSIONS TO BE CONFIRMED WITH ESBN.

NOTE 2: HV AND LV CABLE ROUTES ARE SHOWN BUT SHOULD BE DEVELOPED AS

PART OF THE SUBSTATION DETAIL DESIGN.

NOTE 3: HV COMPOUND SHALL MATCH THE APPROPRIATE SINGLE LINE DIAGRAM. NOTE 4: MV COMPOUNDS ARE NOT IDENTIFIED IN THIS DRAWING. NOTE 5: CLEARANCE REQUIREMENTS TO BE CONSIDERED IN DETAILED DESIGN AS

PER ESBN FUNCTIONAL SPECIFICATIONS. NOTE 6: ACCESS ROAD MATERIAL MAKEUP AND LAYOUT TO BE CONFIRMED AT THE DETAIL DESIGN.

NOTE 7: INTERFACE KIOSK LOCATION IS INDICATIVE. IT SHALL BE CONFIRMED AT THE DETAIL DESIGN.

NOTE 8: DRAINAGE DESIGN MAY BE SUBJECT TO CHANGE AT DETAILED DESIGN. NOTE 9: PROPOSED FENCING MAY BE AMENDED TO MEET STAKEHOLDER

LEGEND

CSE: CABLE SEALING ENDS SA: SURGE ARRESTORS SD: SWITCH DISCONNECTS CB: CIRCUIT BREAKERS CT/CV: COMBINED CT/CV NES: NEUTRAL EARTHING SWITCH LM: LIGHTNING MONOPOLES CTF: CUSTOMER TRANSFORMER

REQUIREMENTS AT DETAILED DES	
Area 301	ML-RO 301 Y-O National National
	-RO 302 O-A ML-RO 302 1-2
FORREST Nat	ML-RO 302 A-B

P01	12/08/22	FOR RAILWAY ORDER	MM	AS	AS	РВ
REV.	DATE	Description	DRAWN BY	CHECKED BY	REVIEWED BY	APPROVED BY

© National Roads Authority (NRA) 1994-2022. This drawing is confidential and the copyright in it is owned by NRA. This drawing must not be either loaned, copied or otherwise reproduced inwhole or in part or used for any purpose without the prior permission of NRA. Transport Infrastructure Ireland (TII)

is an operational name of the National Roads Authority. © Ordnance Survey Ireland 2022/ OSi_NMA_273. All elevations are in metres and relate to OSi Geoid Model (OSGM02) Malin Head as defined by existing Project Control. All Co-ordinates are in Irish Transverse Mercator Grid (ITM) as defined by OSi active GPS station Tallaght College (TLLG).





JACOBS







IDOM

Scales Original Size A1 1:500


Drawing Title	ESBN & MetroLink 110kV Substation Compound Plan View - North Portal	Drawing Status S0
Drawing N⁰	ML1-JAI-SRD-ROUT_XX-DR-Y-08014	


Sheet 1 of 1

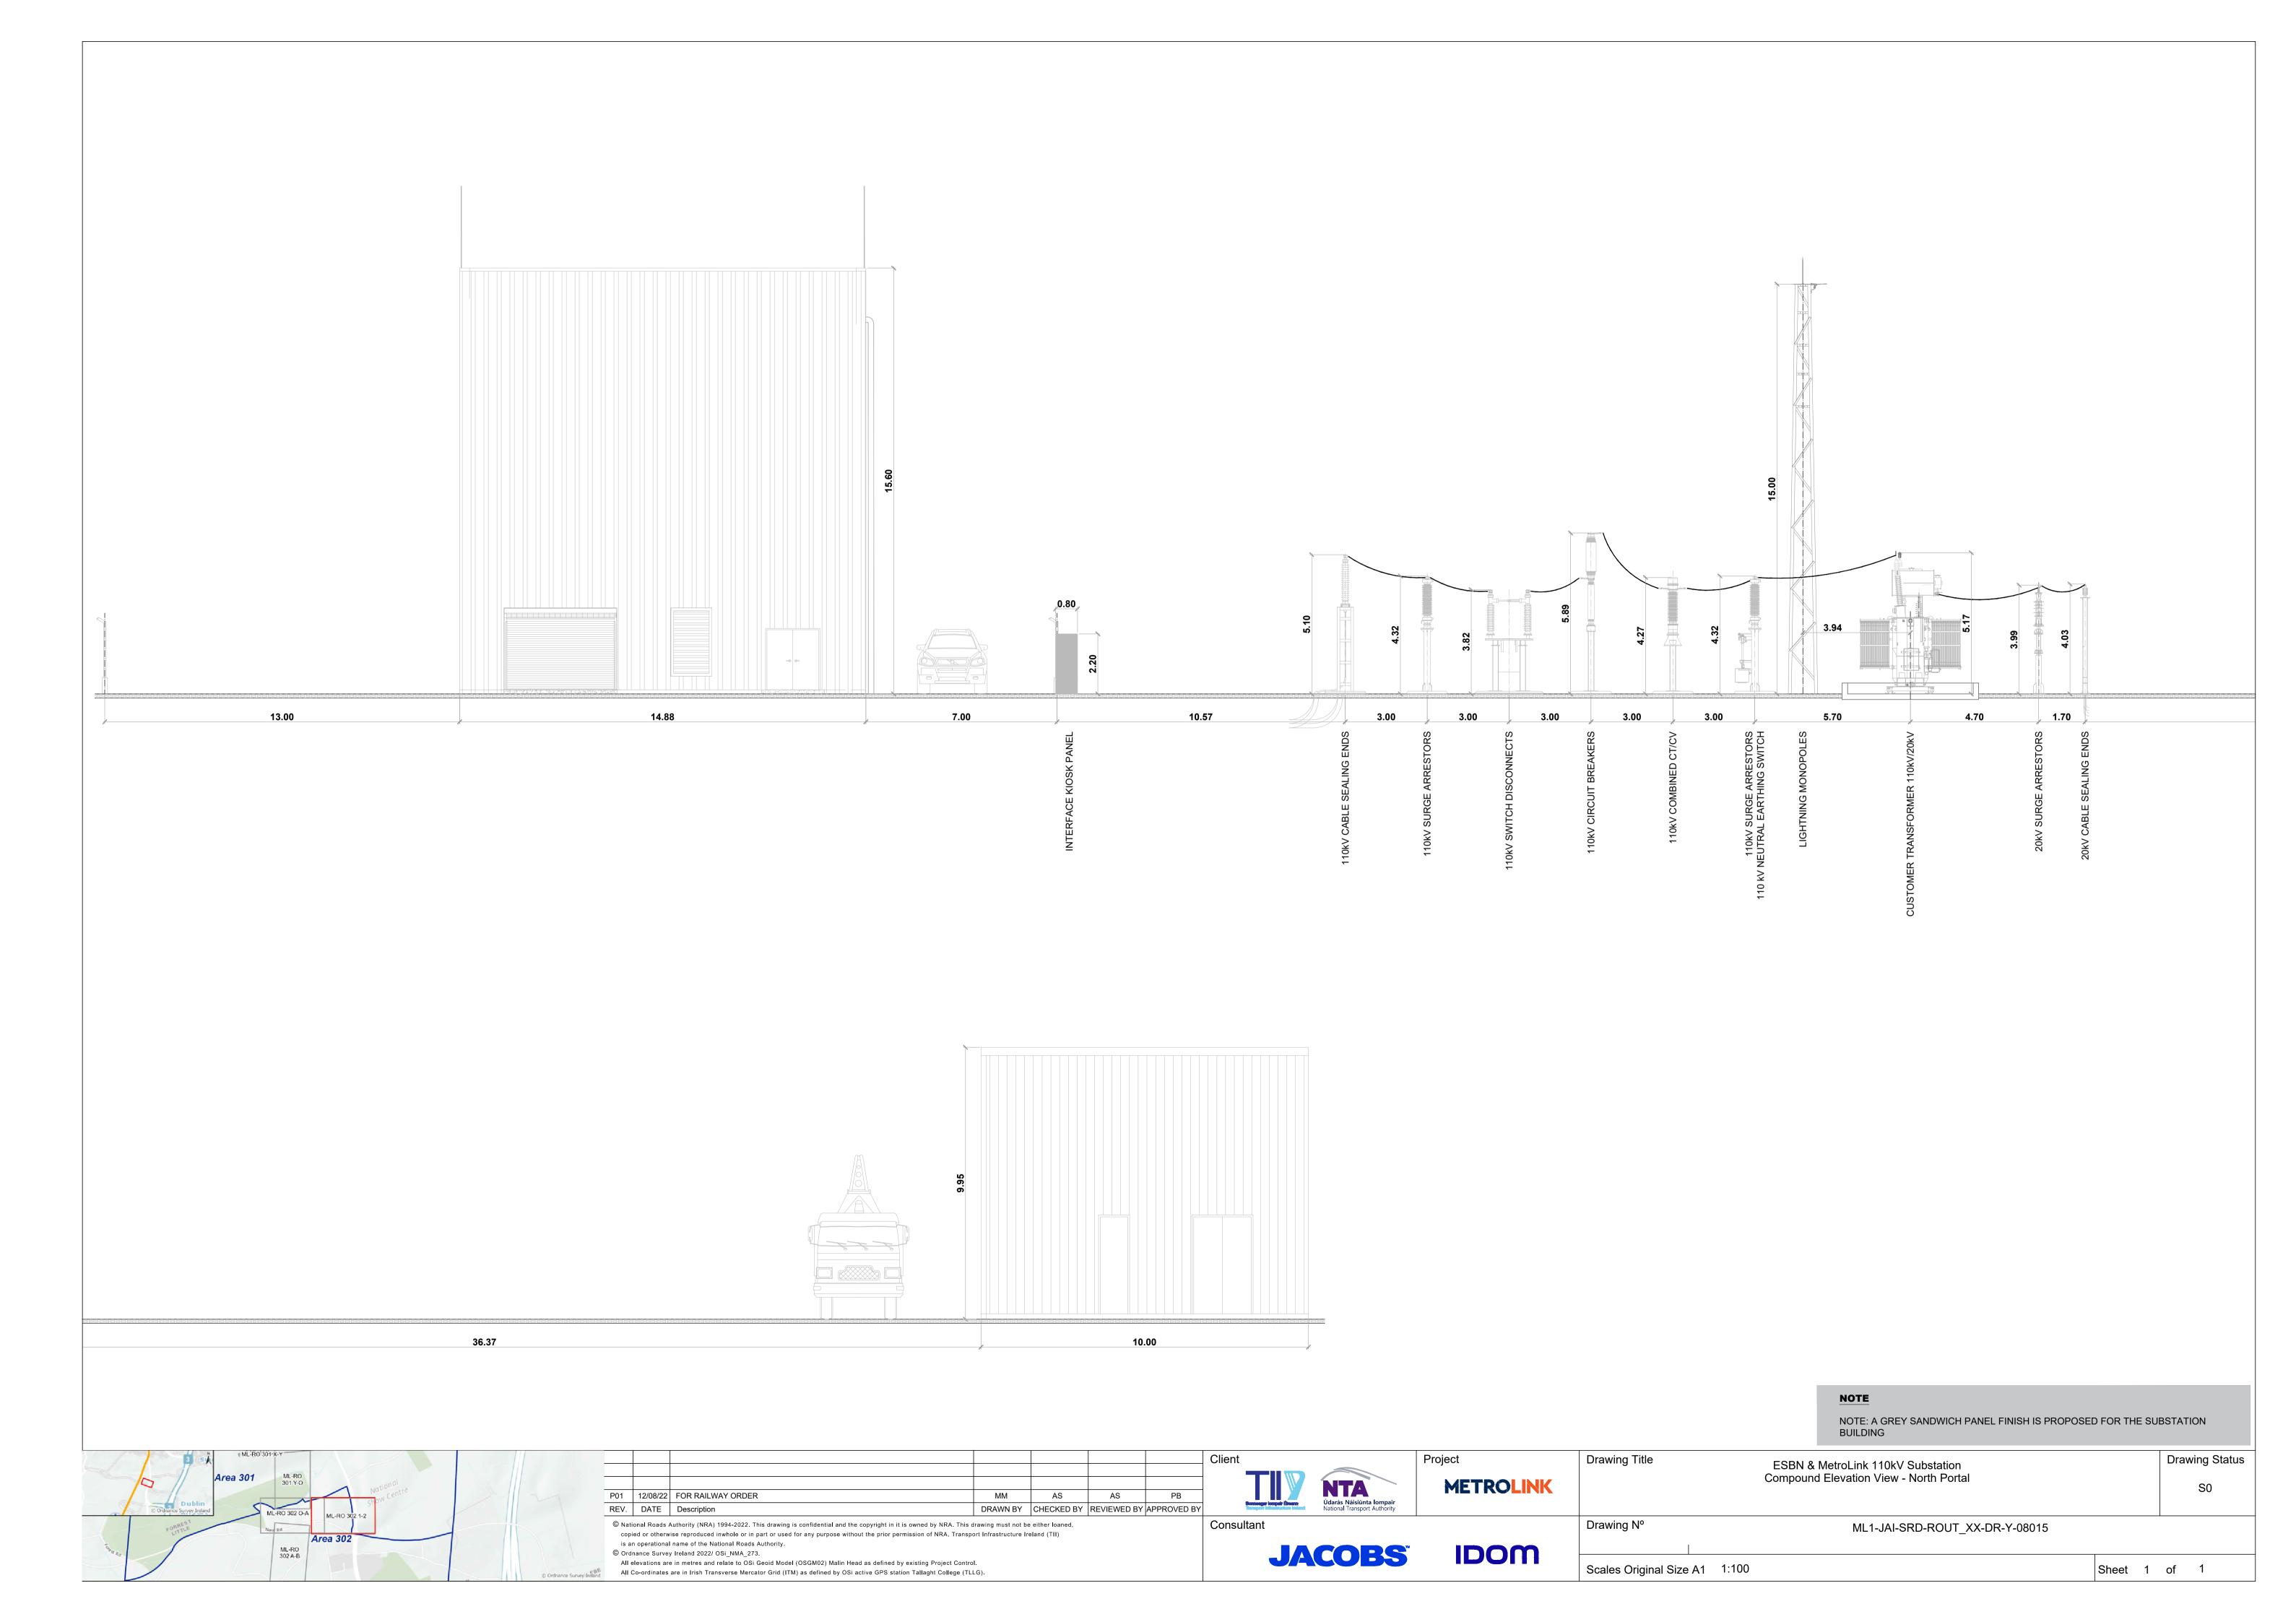

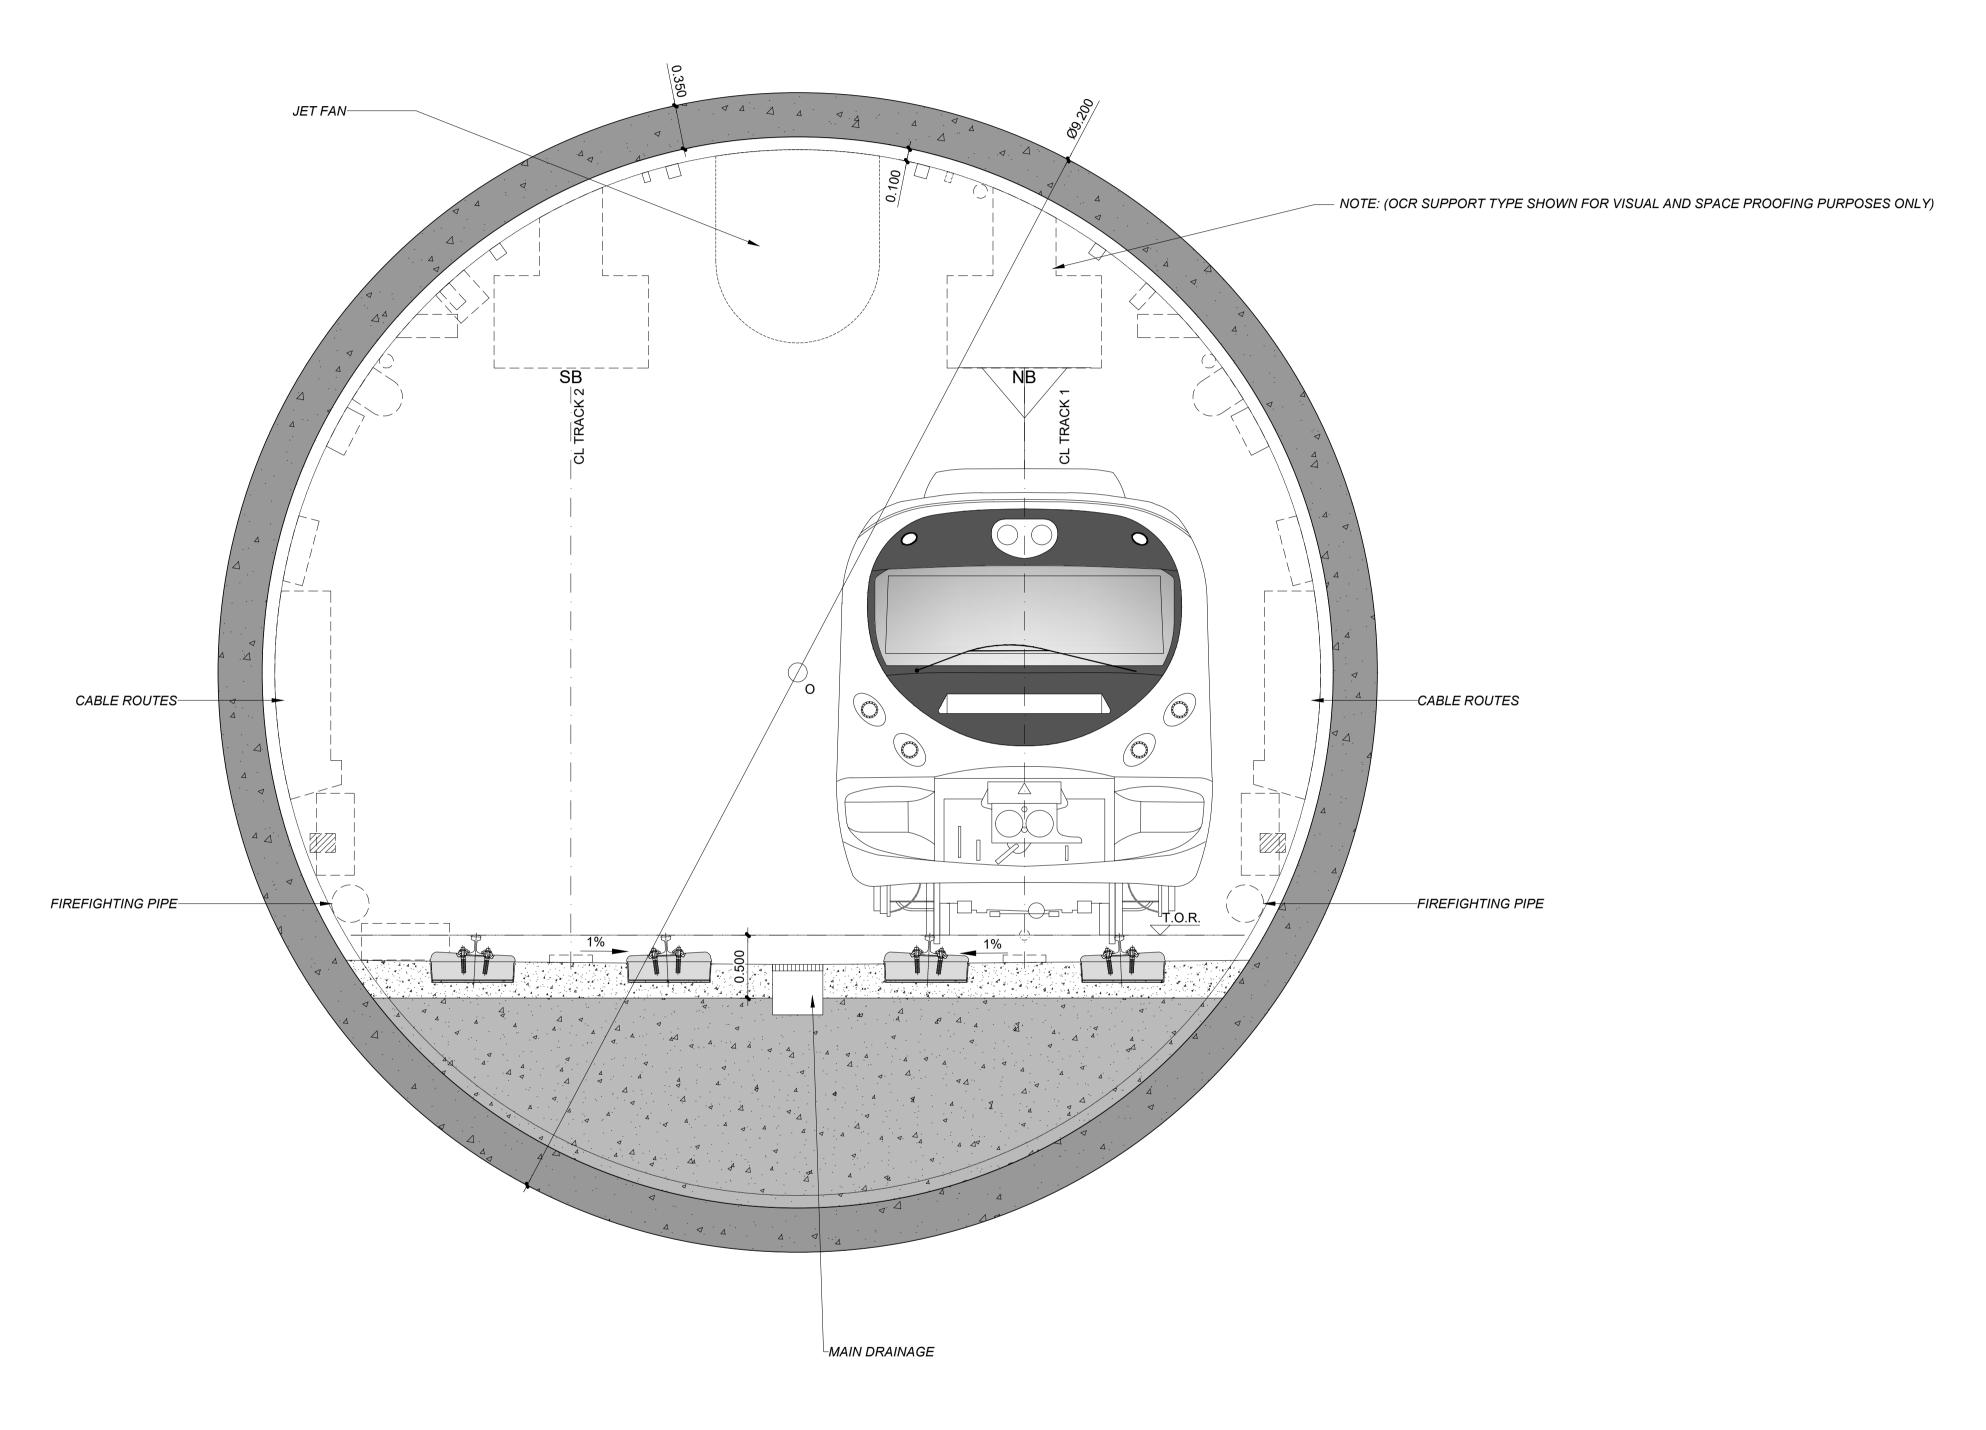



TYPICAL TUNNEL CROSS SECTIONS (TRACK AXIS DISTANCE=3600mm; CANT=0mm) SCALE 1:30

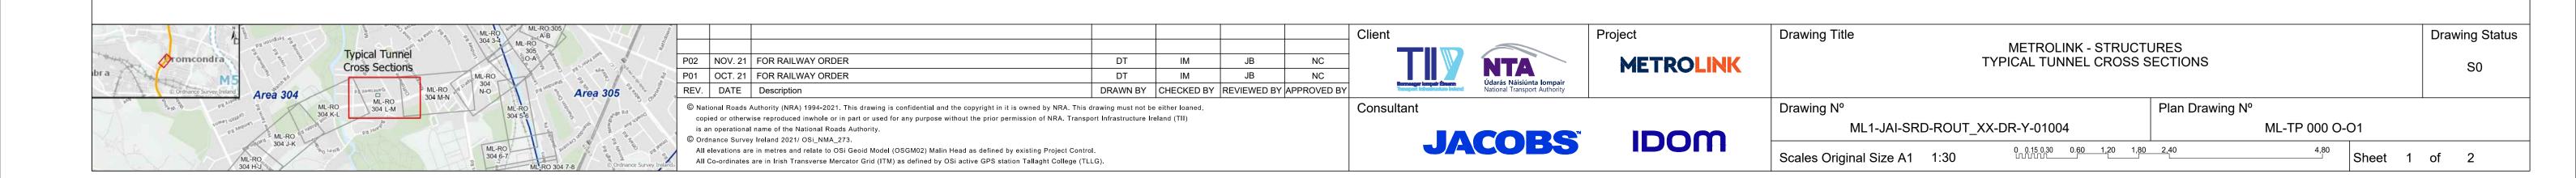


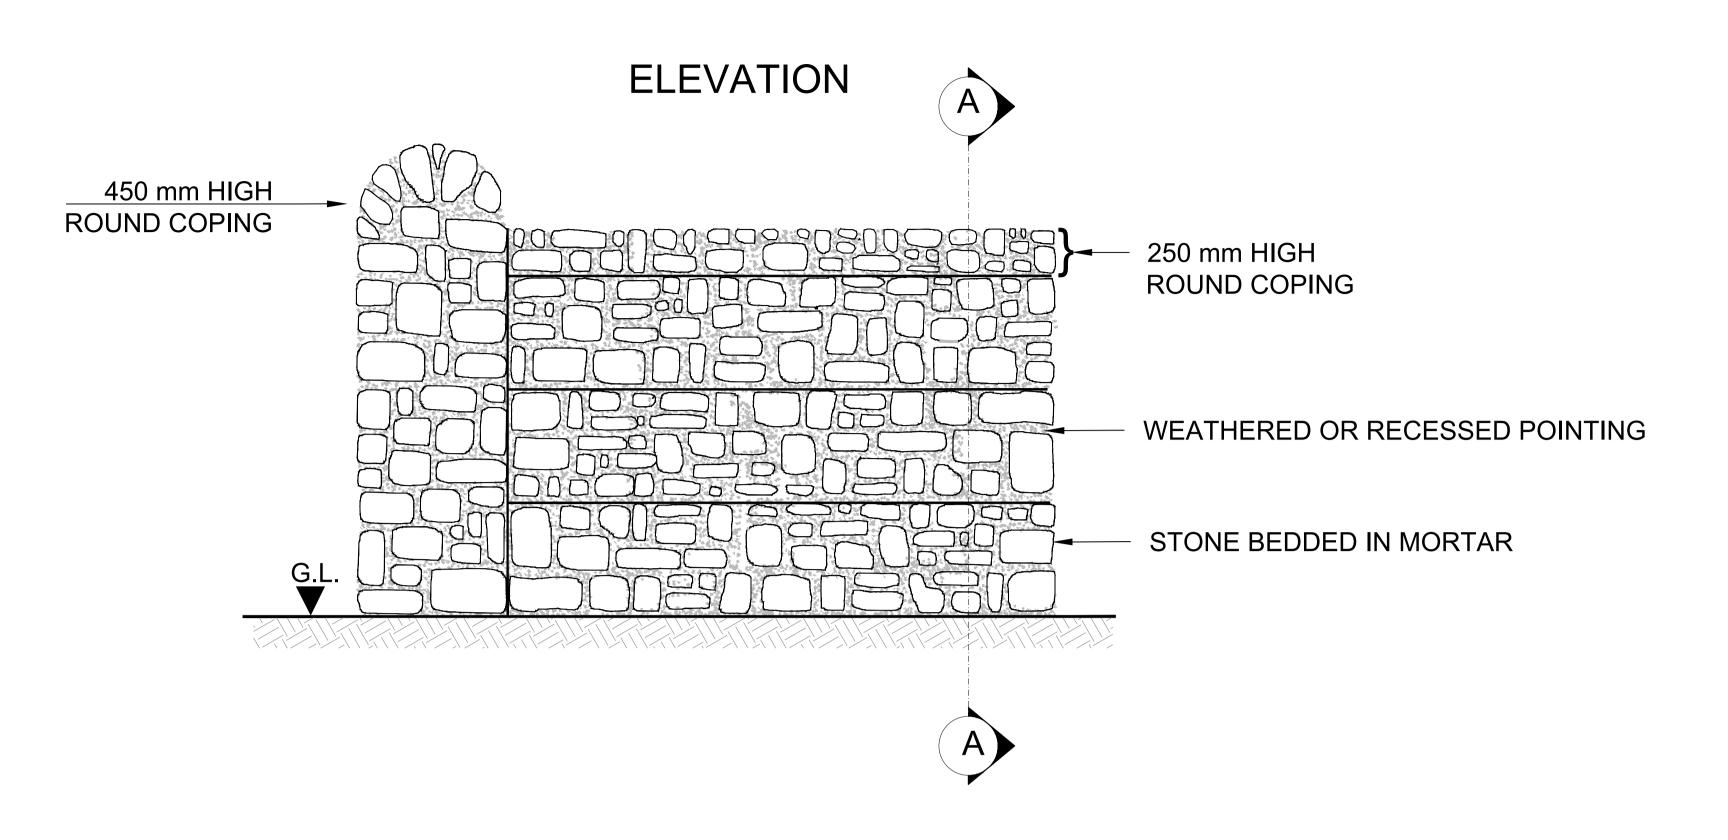


SECTION A-A

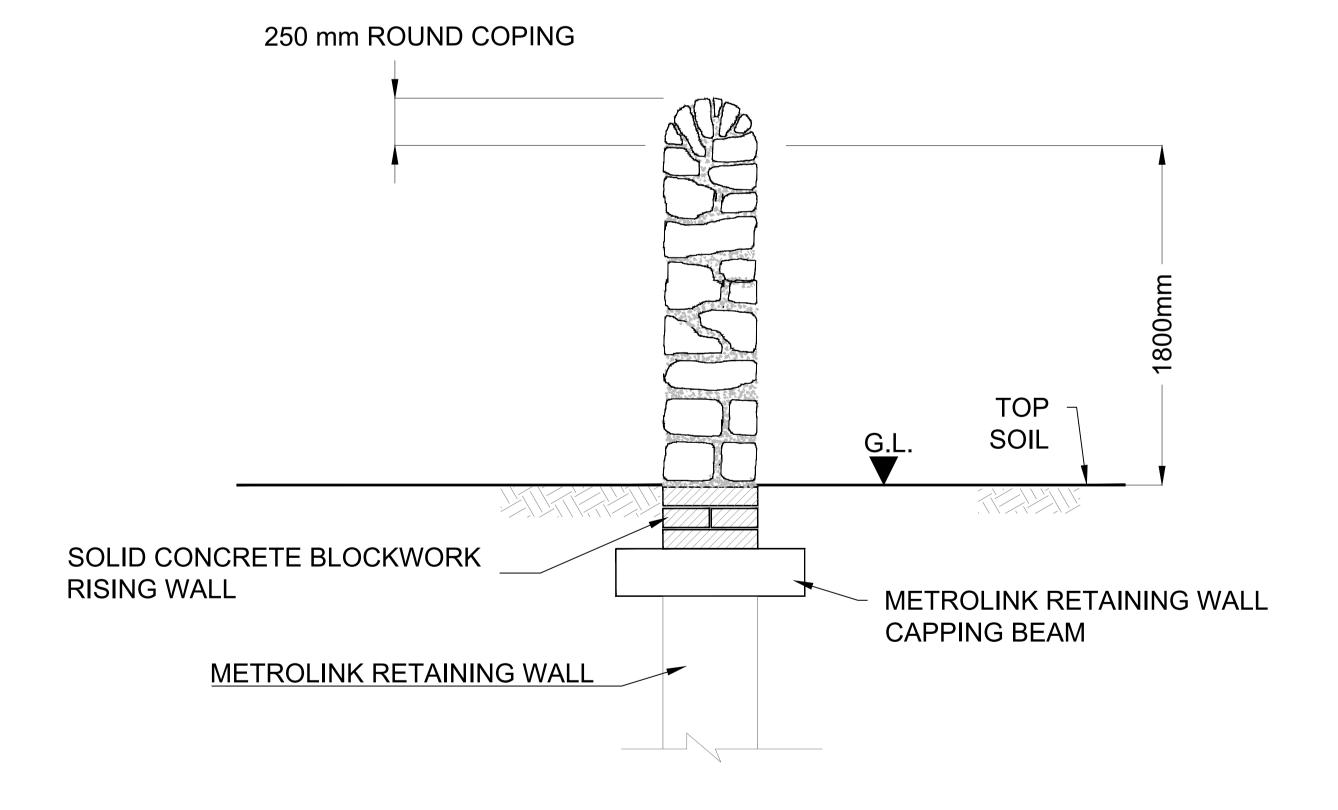


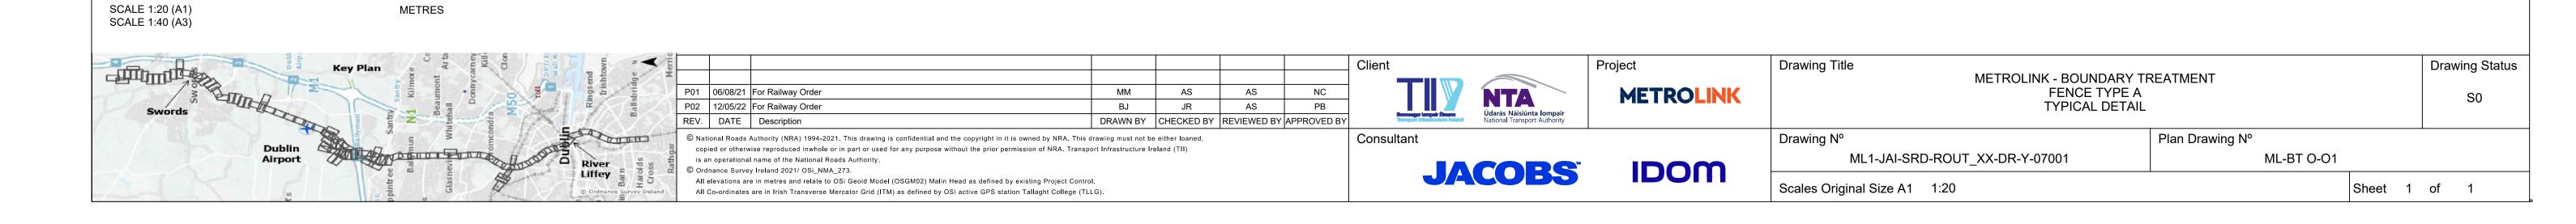

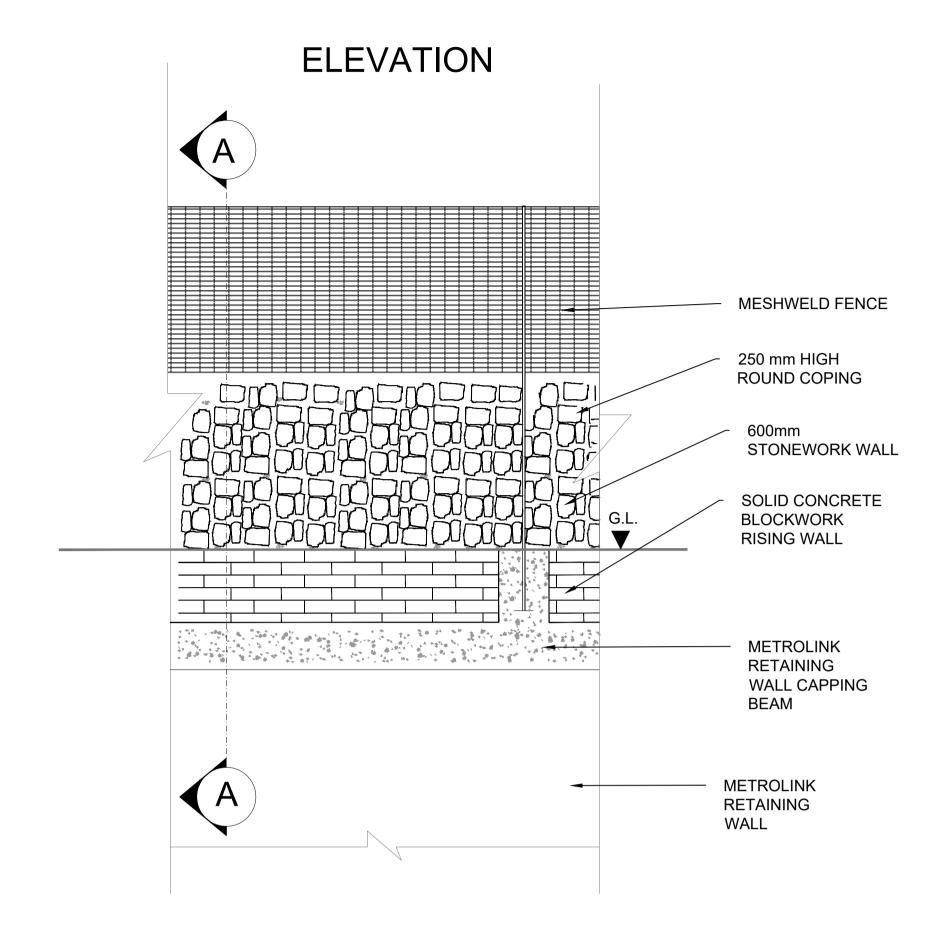

SECTION A-A

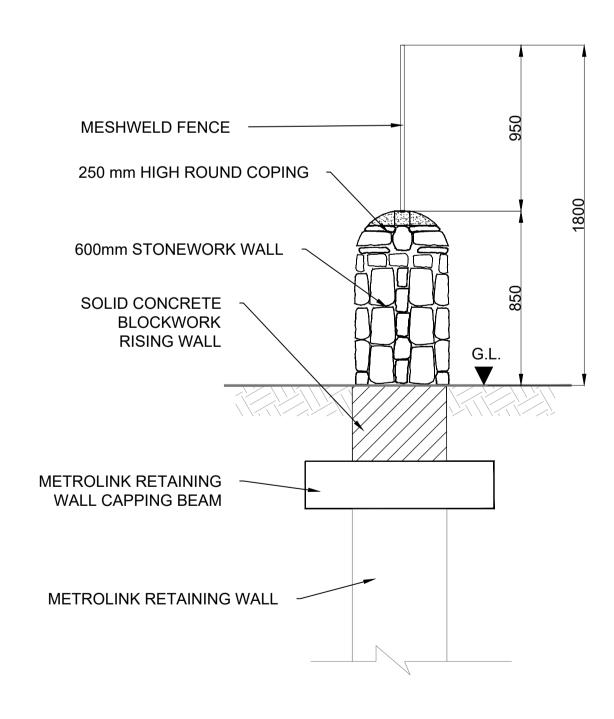

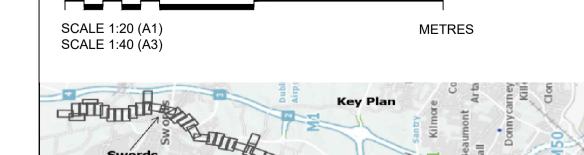

1	06/08/21	For Railway Order	MM	AS	AS	NC				
2	12/05/22	For Railway Order	BJ	JR	AS	PB				
V.	DATE	Description	DRAWN BY	CHECKED BY	REVIEWED BY	APPROVED BY				
Nati	National Roads Authority (NRA) 1994-2021. This drawing is confidential and the copyright in it is owned by NRA. This drawing must not be either loaned,									

© National Roads Authority (NRA) 1994-2021. This drawing is confidential and the copyright in it is owned by NRA. This drawing must not be either loaned, copied or otherwise reproduced inwhole or in part or used for any purpose without the prior permission of NRA. Transport Infrastructure Ireland (TII) is an operational name of the National Roads Authority.

© Ordnance Survey Ireland 2021/ OSi_NMA_273.

All elevations are in metres and relate to OSi Geoid Model (OSGM02) Malin Head as defined by existing Project Control.

All Co-ordinates are in Irish Transverse Mercator Grid (ITM) as defined by OSi active GPS station Tallaght College (TLLG).



JACOBS

Project
METROLINK

IDOM

Drawing Title

METROLINK - BOUNDARY TREATMENT
FENCE TYPE B
TYPICAL DETAIL

Drawing N°

Plan Drawing N°


Drawing Status

Sheet 1 of 1


Drawing N° Plan Drawing N° ML1-JAI-SRD-ROUT_XX-DR-Y-07002 ML-BT O-O2


Scales Original Size A1 1:20

ELEVATION

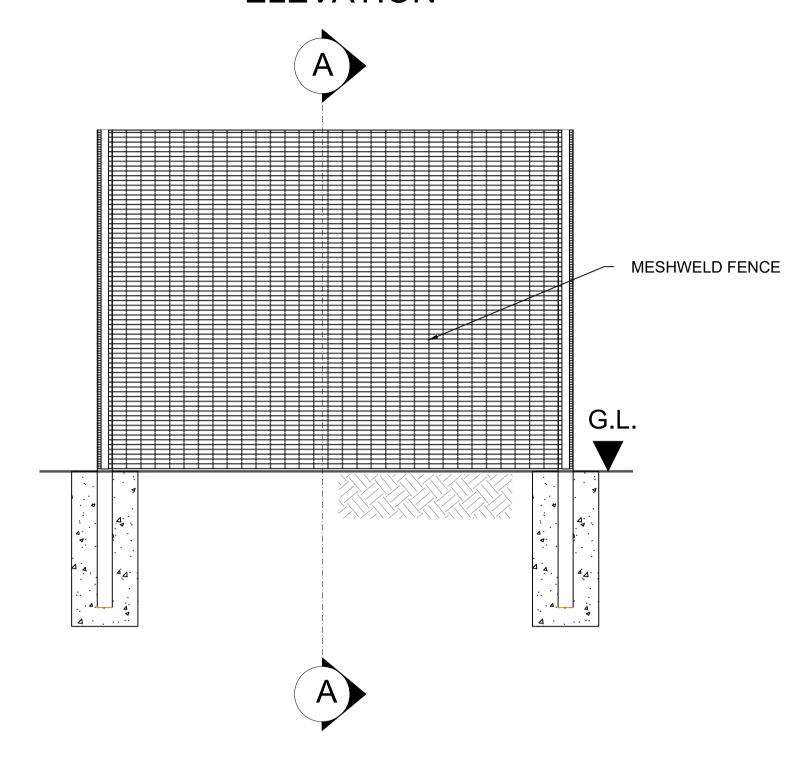


SECTION A - A

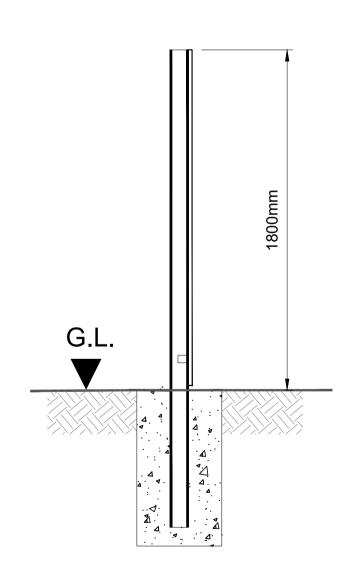


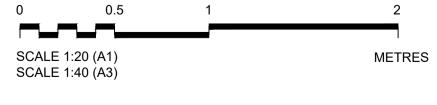


Key Plan						Client		Project	Drawing Title		Drawing Status
Santy Kilmo Santy Kilmo Domnyo Domnyo Domnyo Domnyo Milishida	P01 06/08/21 For Railway Order	MM	AS	AS	NC		NTA	METROLINK	METROLINK - BOUNDARY T FENCE TYPE C		S0
Swords North Market Barren Barren Market Bar	REV. DATE Description	DRAWN BY	CHECKED BY	REVIEWED BY	APPROVED BY		Údarás Náisiúnta lompair National Transport Authority		TYPICAL DETAIL		
Dublin Airport © National Roads Authority (NRA) 1994-2021. This drawing is confidential and the copyright in it is owned by NRA. This drawing must not be either loaned, copied or otherwise reproduced inwhole or in part or used for any purpose without the prior permission of NRA. Transport Infrastructure Ireland (TII) is an operational name of the National Roads Authority. © Ordnance Survey Ireland 2021/ OSI, NMA, 273						Consultant		IDOM	Drawing N° ML1-JAI-SRD-ROUT_XX-DR-Y-07003	Plan Drawing N° ML-BT O-O3	
Eliffey Se Ordnance Survey Ireland	All elevations are in metres and relate to OSi Geoid Model (OSGM02) Malin Head as defined by existing Project Contro All Co-ordinates are in Irish Transverse Mercator Grid (ITM) as defined by OSi active GPS station Tallaght College (TLI	il. LG).				JA	JUBS	IDOIII	Scales Original Size A1 1:20	Sheet 1	of 1

SECTION A-A ELEVATION FIELD SIDE TIMBER RAIL 2100 G.L. CHAINLINK MESH COVERS WHOLE FENCE **PLAN ELEVATION ROAD SIDE** SCALE 1:20 (A1) SCALE 1:40 (A3) Drawing Status Drawing Title METROLINK - BOUNDARY TREATMENT FENCE TYPE D TYPICAL DETAIL Údarás Náisiúnta lompair National Transport Authority **METROLINK** P01 06/08/21 For Railway Order MM AS NC P02 12/05/22 For Railway Order DRAWN BY CHECKED BY REVIEWED BY APPROVED BY REV. DATE Description Plan Drawing Nº Drawing Nº © National Roads Authority (NRA) 1994-2021. This drawing is confidential and the copyright in it is owned by NRA. This drawing must not be either loaned, ML1-JAI-SRD-ROUT_XX-DR-Y-07004 ML-BT O-O4 **JACOBS** IDOM © Ordnance Survey Ireland 2021/ OSi_NMA_273. All elevations are in metres and relate to OSi Geoid Model (OSGM02) Malin Head as defined by existing Project Control. Scales Original Size A1 1:20 Sheet 1 of 1 All Co-ordinates are in Irish Transverse Mercator Grid (ITM) as defined by OSi active GPS station Tallaght College (TLLG).

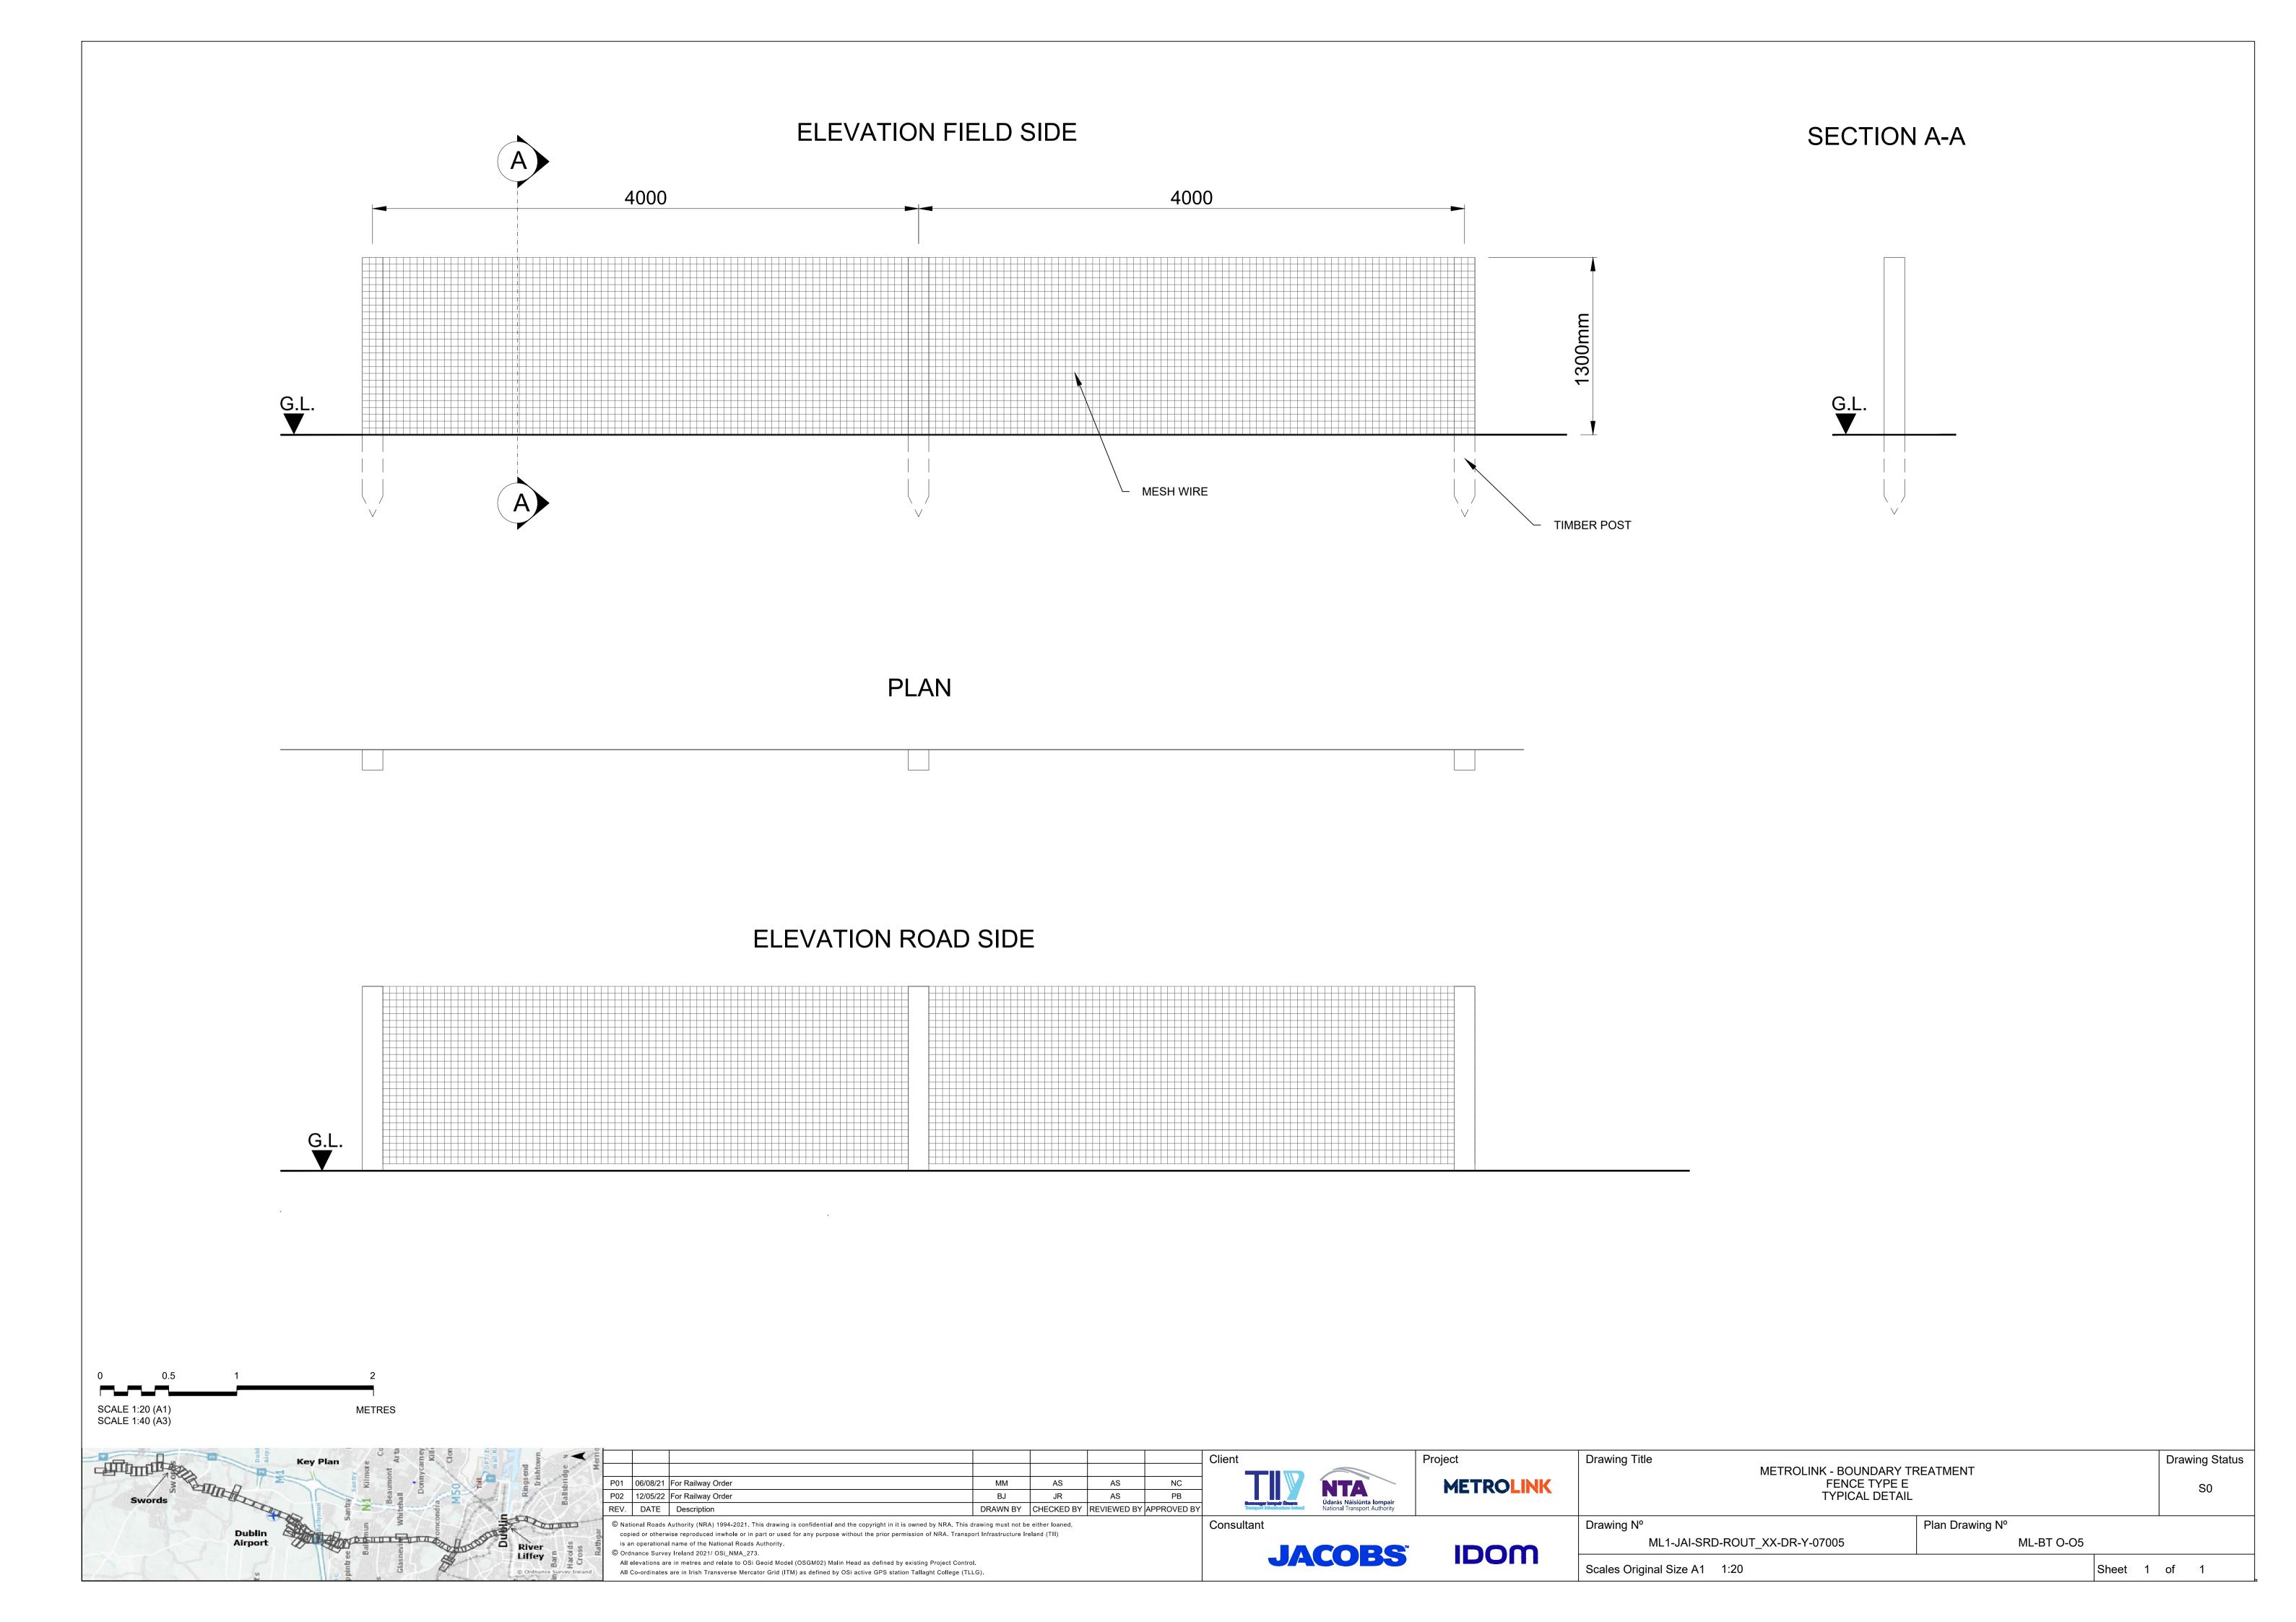


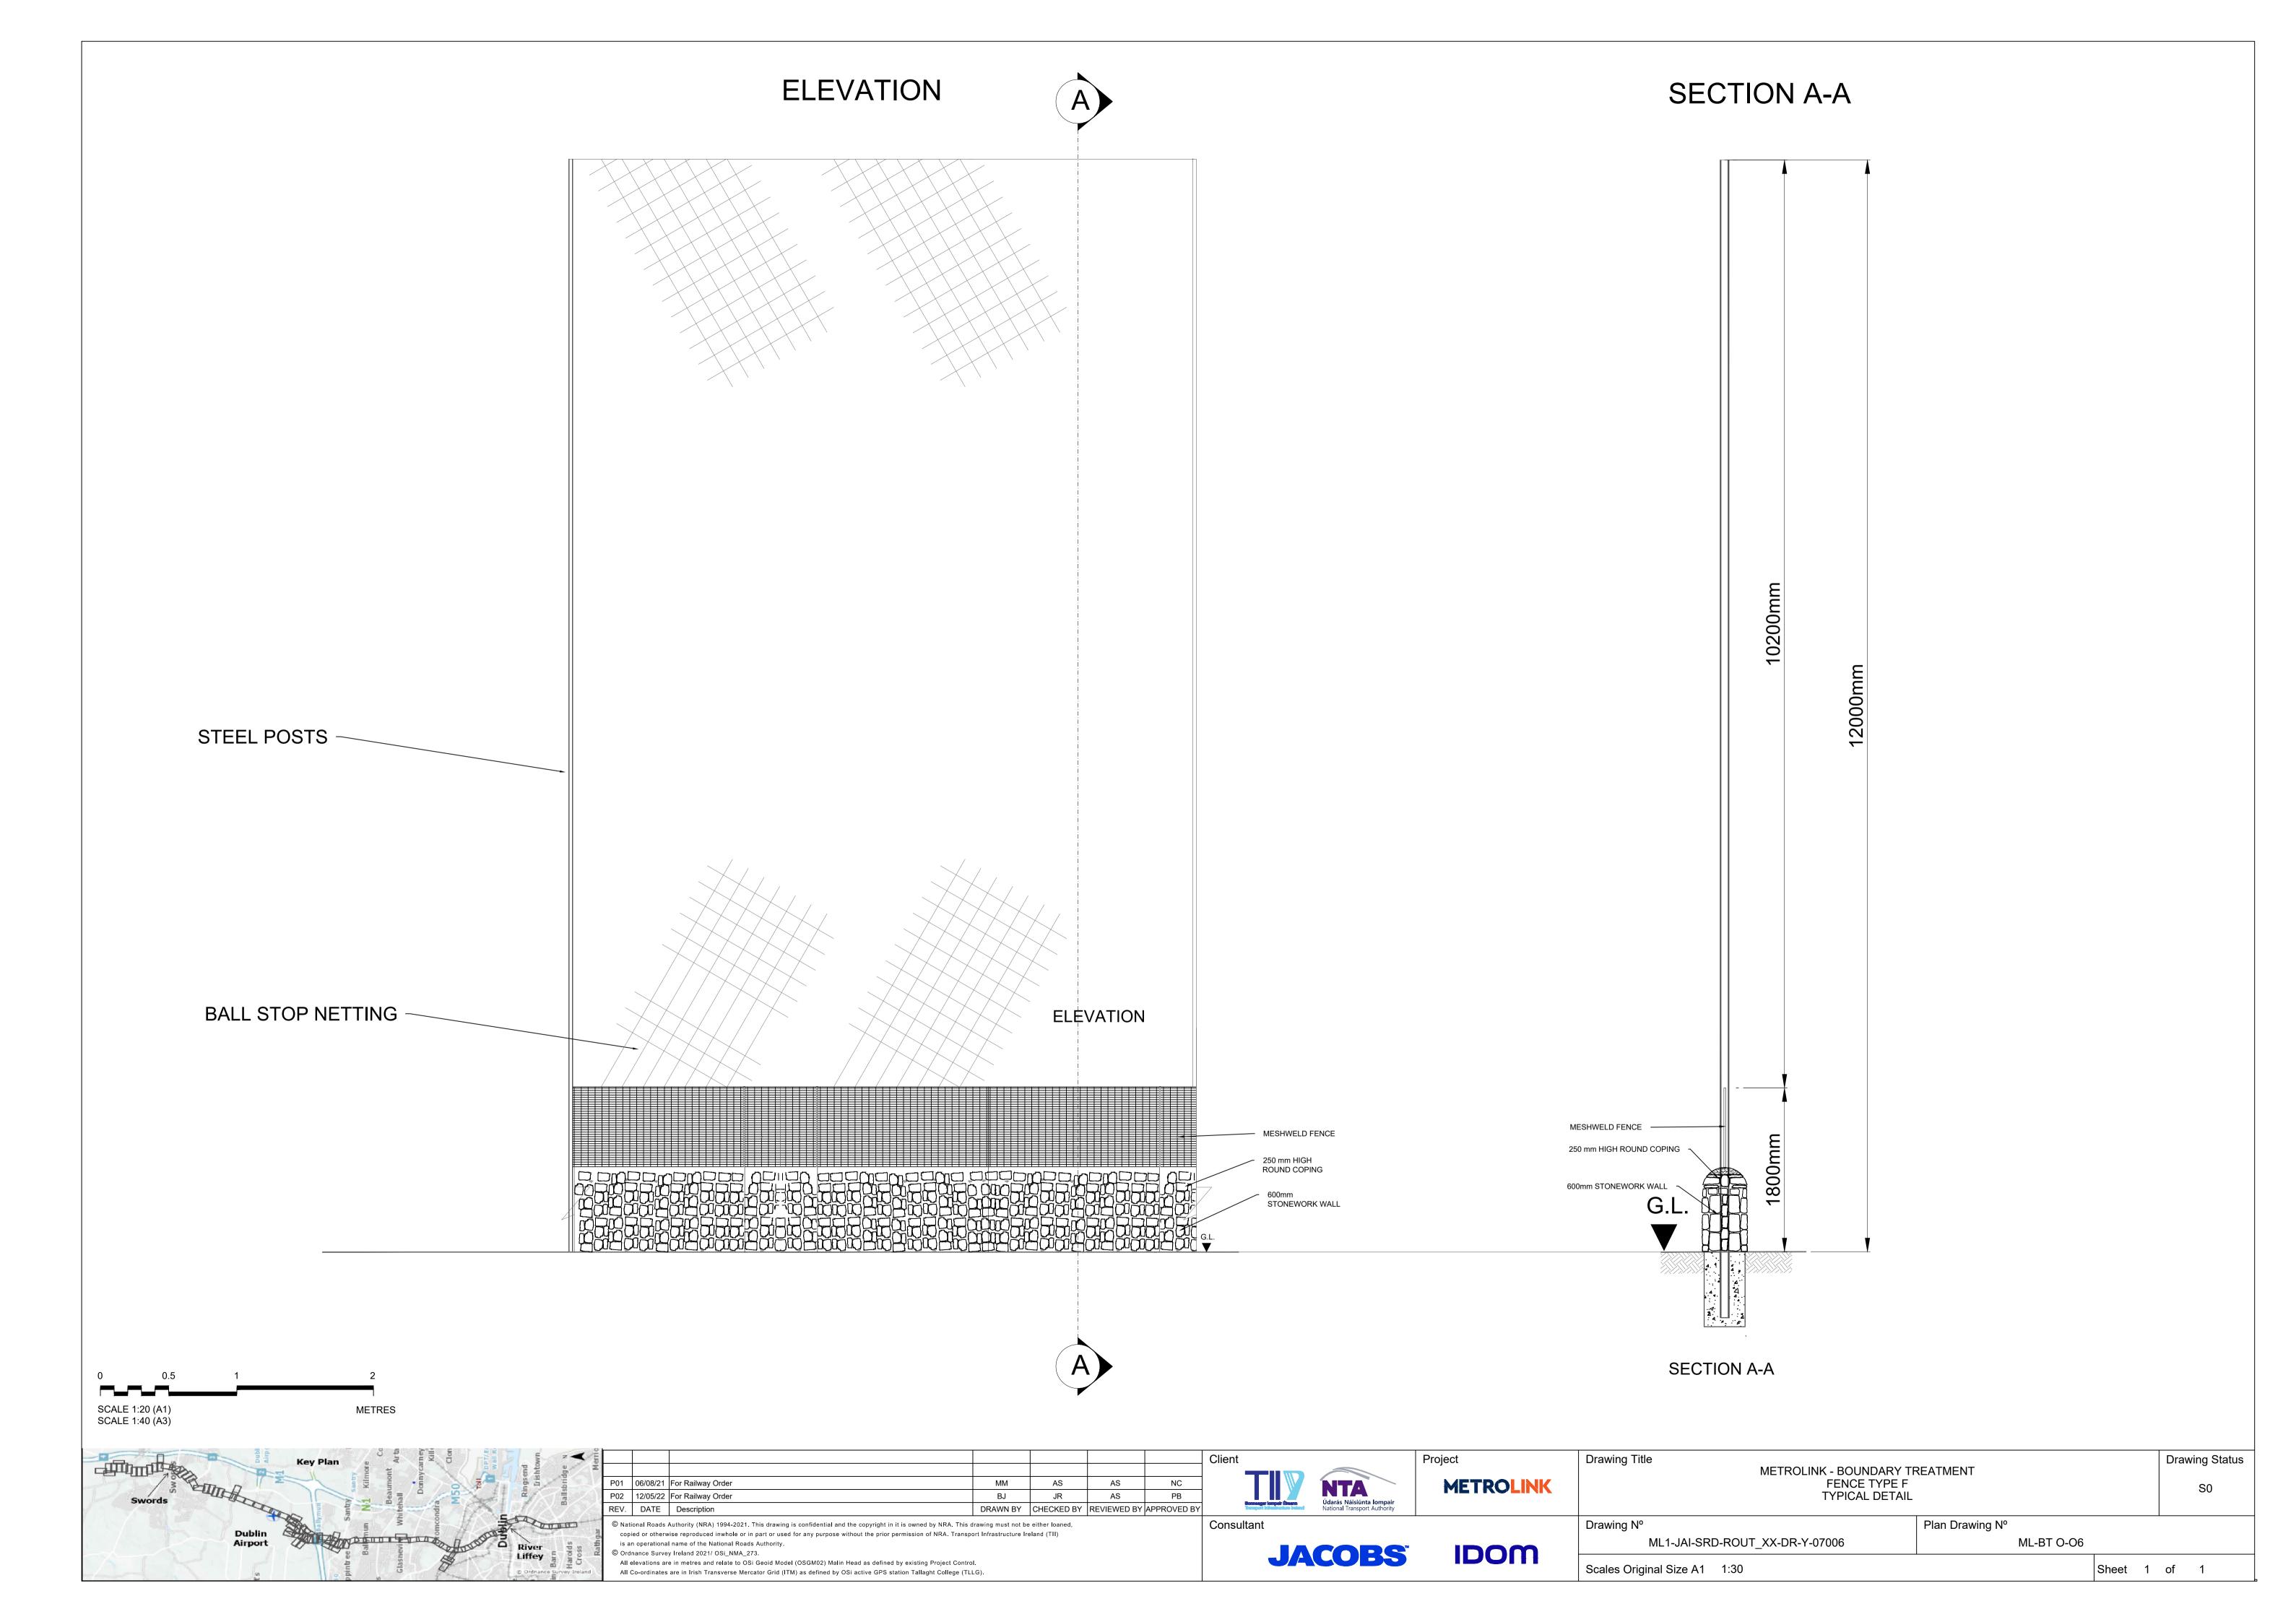


ELEVATION

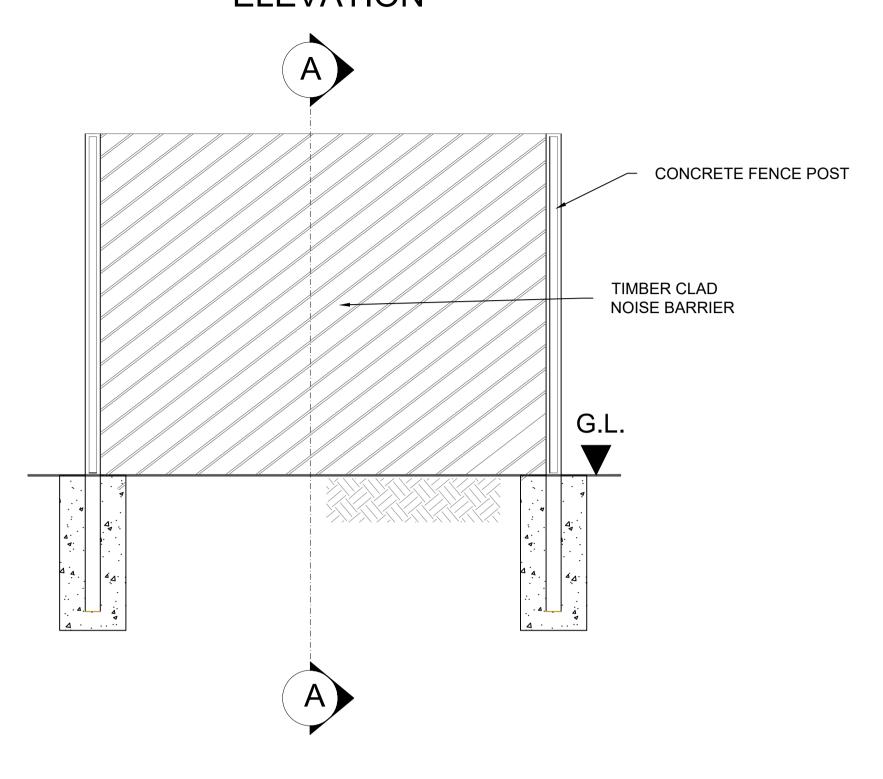



SECTION A - A

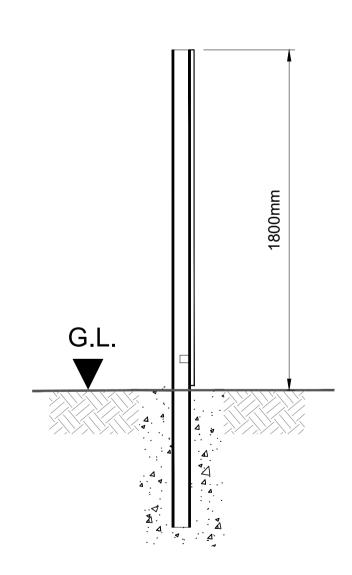


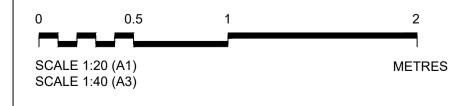

Key Plan					Client		Project	Drawing Title	METROLINIC DOLINDARY TREATMENT	Drawing Status
Spridg sbridg spridg					TIV NT	TA	METROLINK		METROLINK - BOUNDARY TREATMENT FENCE TYPE G	S0
Swords	P01 15/05/22 For Railway Order BJ	JR	AS	PB	Údarás N	Náisiúnta Iompair			TYPICAL DETAIL	
	REV. DATE Description DRAWN BY	CHECKED BY	REVIEWED E	BY APPROVED BY	National T	Transport Authority				
Sam Sallyman Sam Sallyman Sallyman Sam Sallyman	© National Roads Authority (NRA) 1994-2021. This drawing is confidential and the copyright in it is owned by NRA. This drawing must not be	e either loaned,		·	Consultant	•		Drawing Nº	Plan Drawing N⁰	•
Dublin Airport River	copied or otherwise reproduced inwhole or in part or used for any purpose without the prior permission of NRA. Transport Infrastructure Ir is an operational name of the National Roads Authority.	reland (TII)			IACC		IDOM		OUT_XX-DR-Y-07007 ML-BT O-O7	
Eliffey E S E S C Crdnance Survey Ireland	All elevations are in metres and relate to OSi Geoid Model (OSGM02) Malin Head as defined by existing Project Control. All Co-ordinates are in Irish Transverse Mercator Grid (ITM) as defined by OSi active GPS station Tallaght College (TLLG).				JACC	JD3	IDOM	Scales Original Size A1 1:2	0 Sho	eet 1 of 1

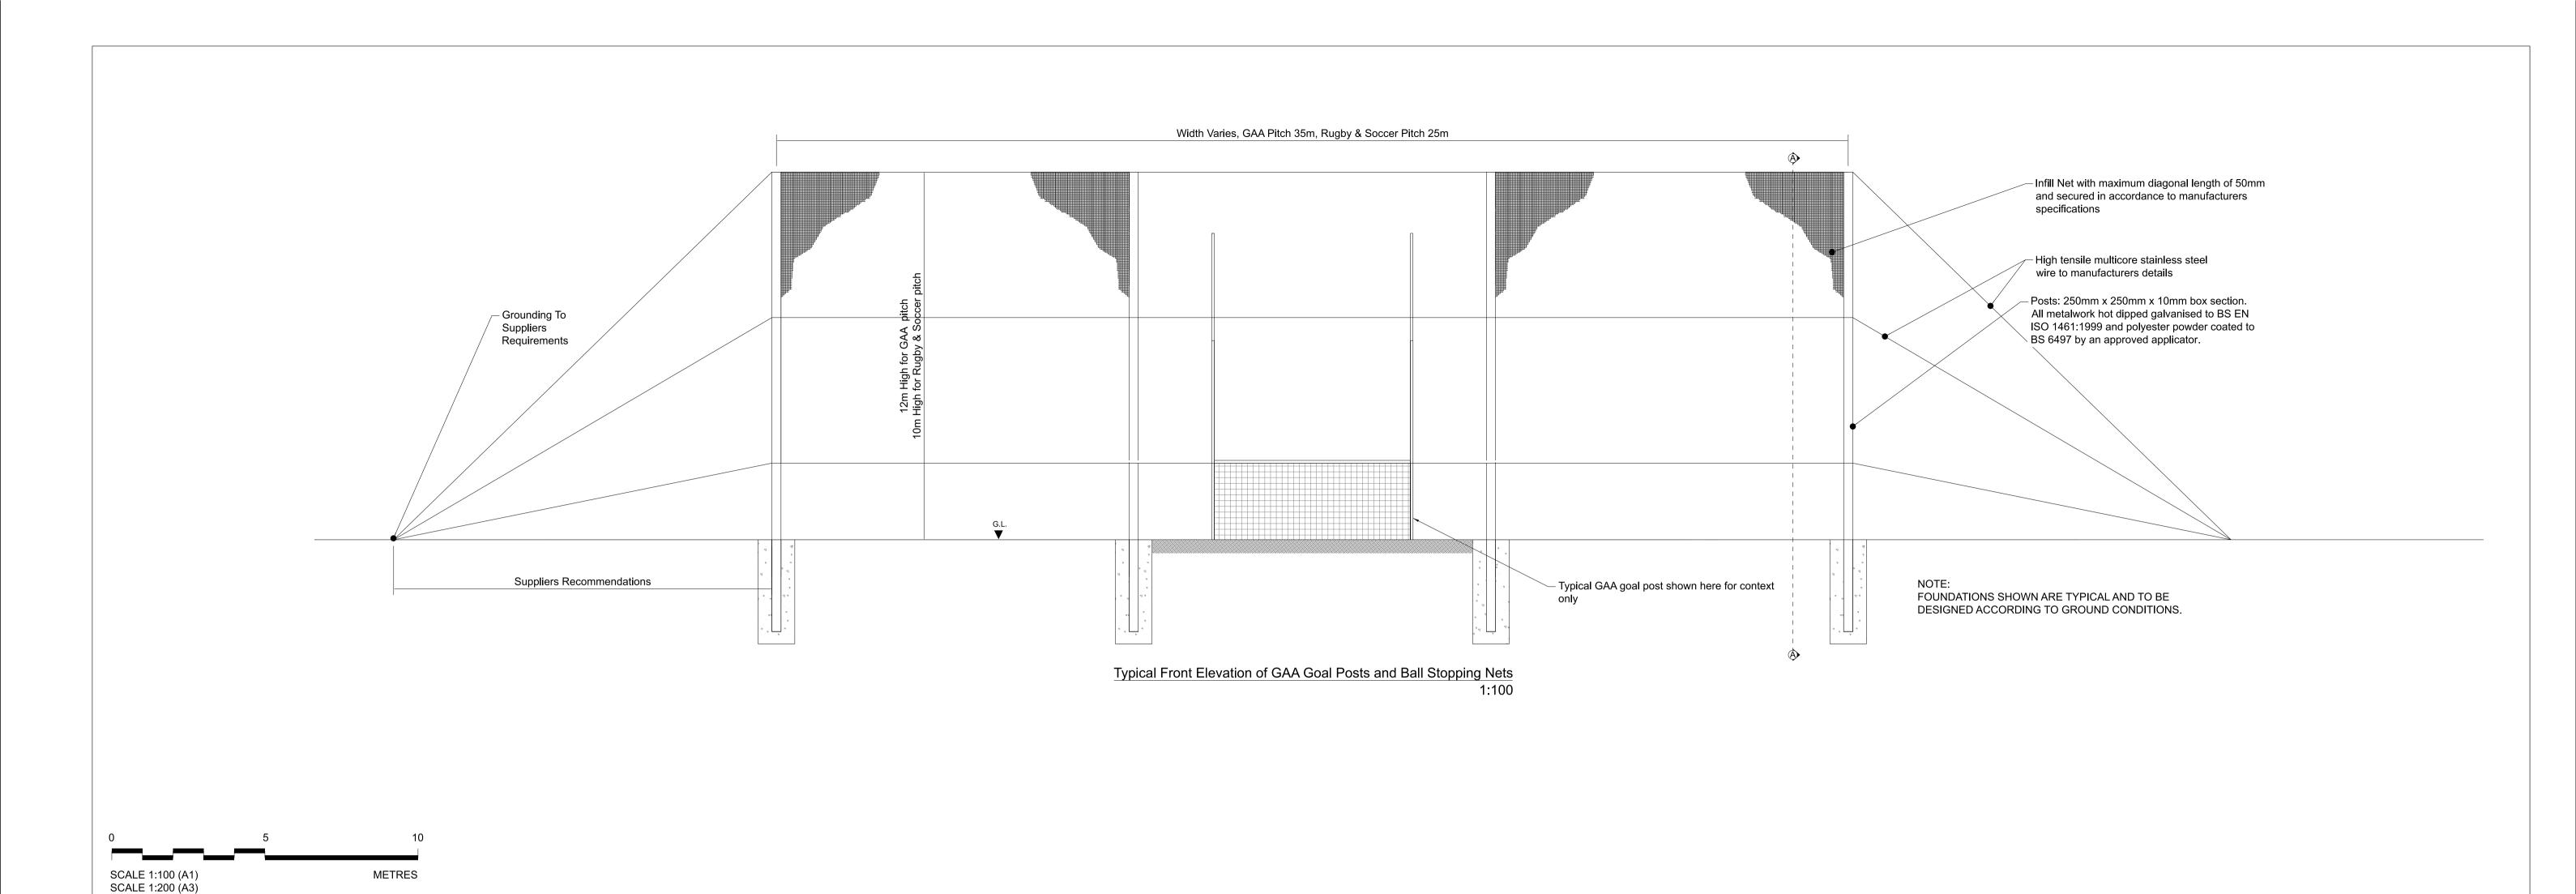

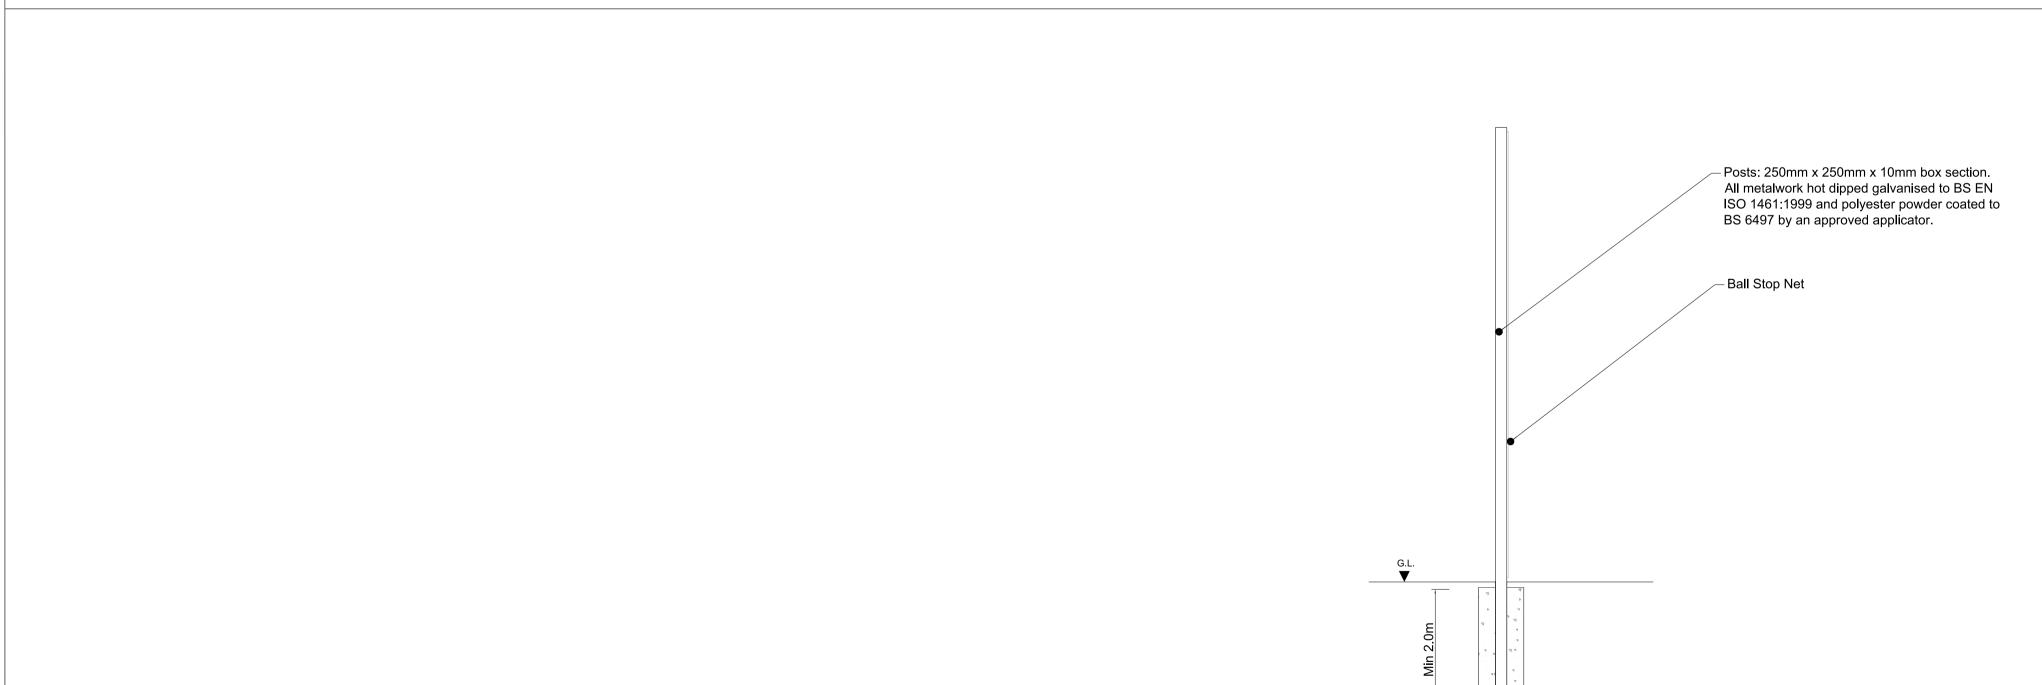

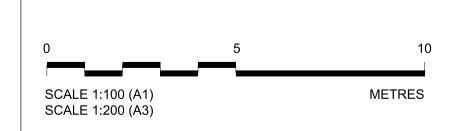

2 11	th ch	e e	5							
7=	Lris	brio								
基其周	2	Salls	P01	02/08/22	For Railway Order	GB	MM	MM	РВ	
	I/X	70%	REV.	DATE	Description	DRAWN BY	CHECKED BY	REVIEWED BY	APPROVED BY	Bonneagar lompa Transport Infrastr
	ALVI	THE STREET			Authority (NRA) 1994-2022. This drawing is confidential and the copyright in it is owned by NRA. This c vise reproduced inwhole or in part or used for any purpose without the prior permission of NRA. Transpo					Consultant

is an operational name of the National Roads Authority.

© Ordnance Survey Ireland 2022/ OSi_NMA_273. All elevations are in metres and relate to OSi Geoid Model (OSGM02) Malin Head as defined by existing Project Control. All Co-ordinates are in Irish Transverse Mercator Grid (ITM) as defined by OSi active GPS station Tallaght College (TLLG).



JACOBS

1:100

Typical Side Elevation of Ball Stop Net Section A - A




METROLINK	
	г


IDOM


5 1 10	DI D I NO
Drawing Title METROLINK - BOUNDARY FENCE TYPE H TYPICAL DETAI	l

Drawing Status

Drawing Nº Plan Drawing N⁰ ML1-JAI-SRD-ROUT_XX-DR-Y-07008 ML-BT O-O8 Scales Original Size A1 AS SHOWN Sheet 1 of 1

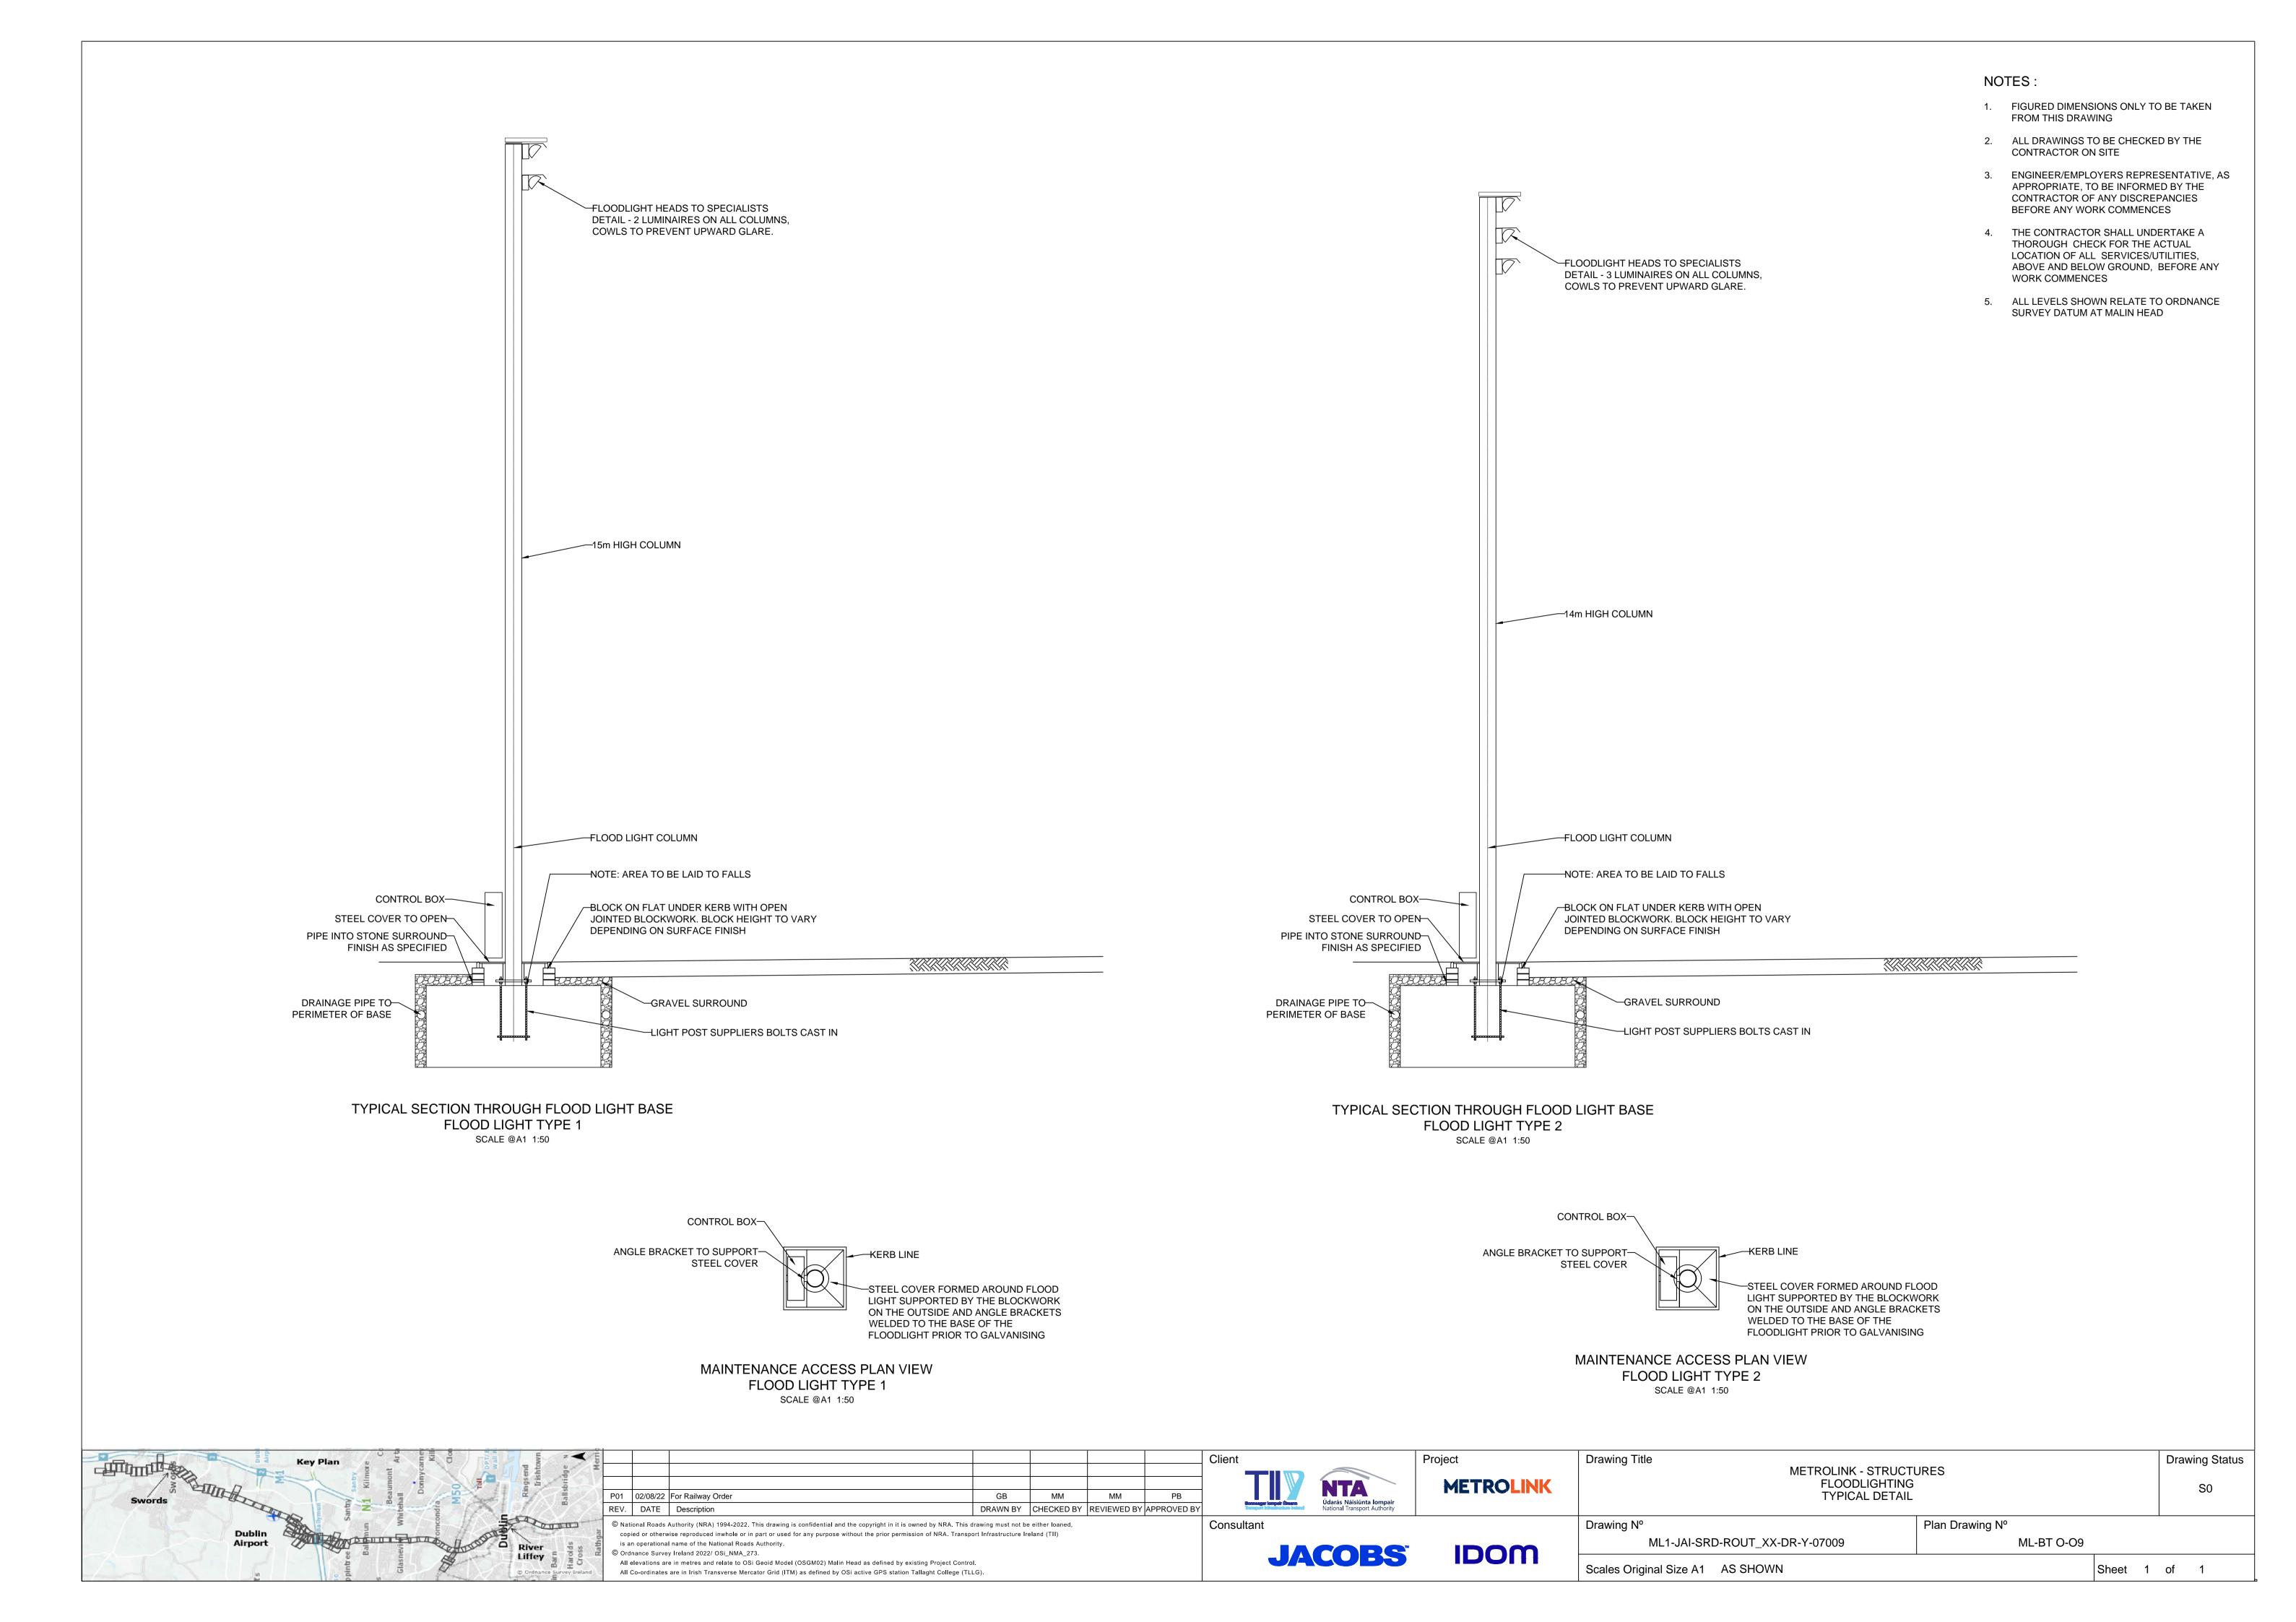

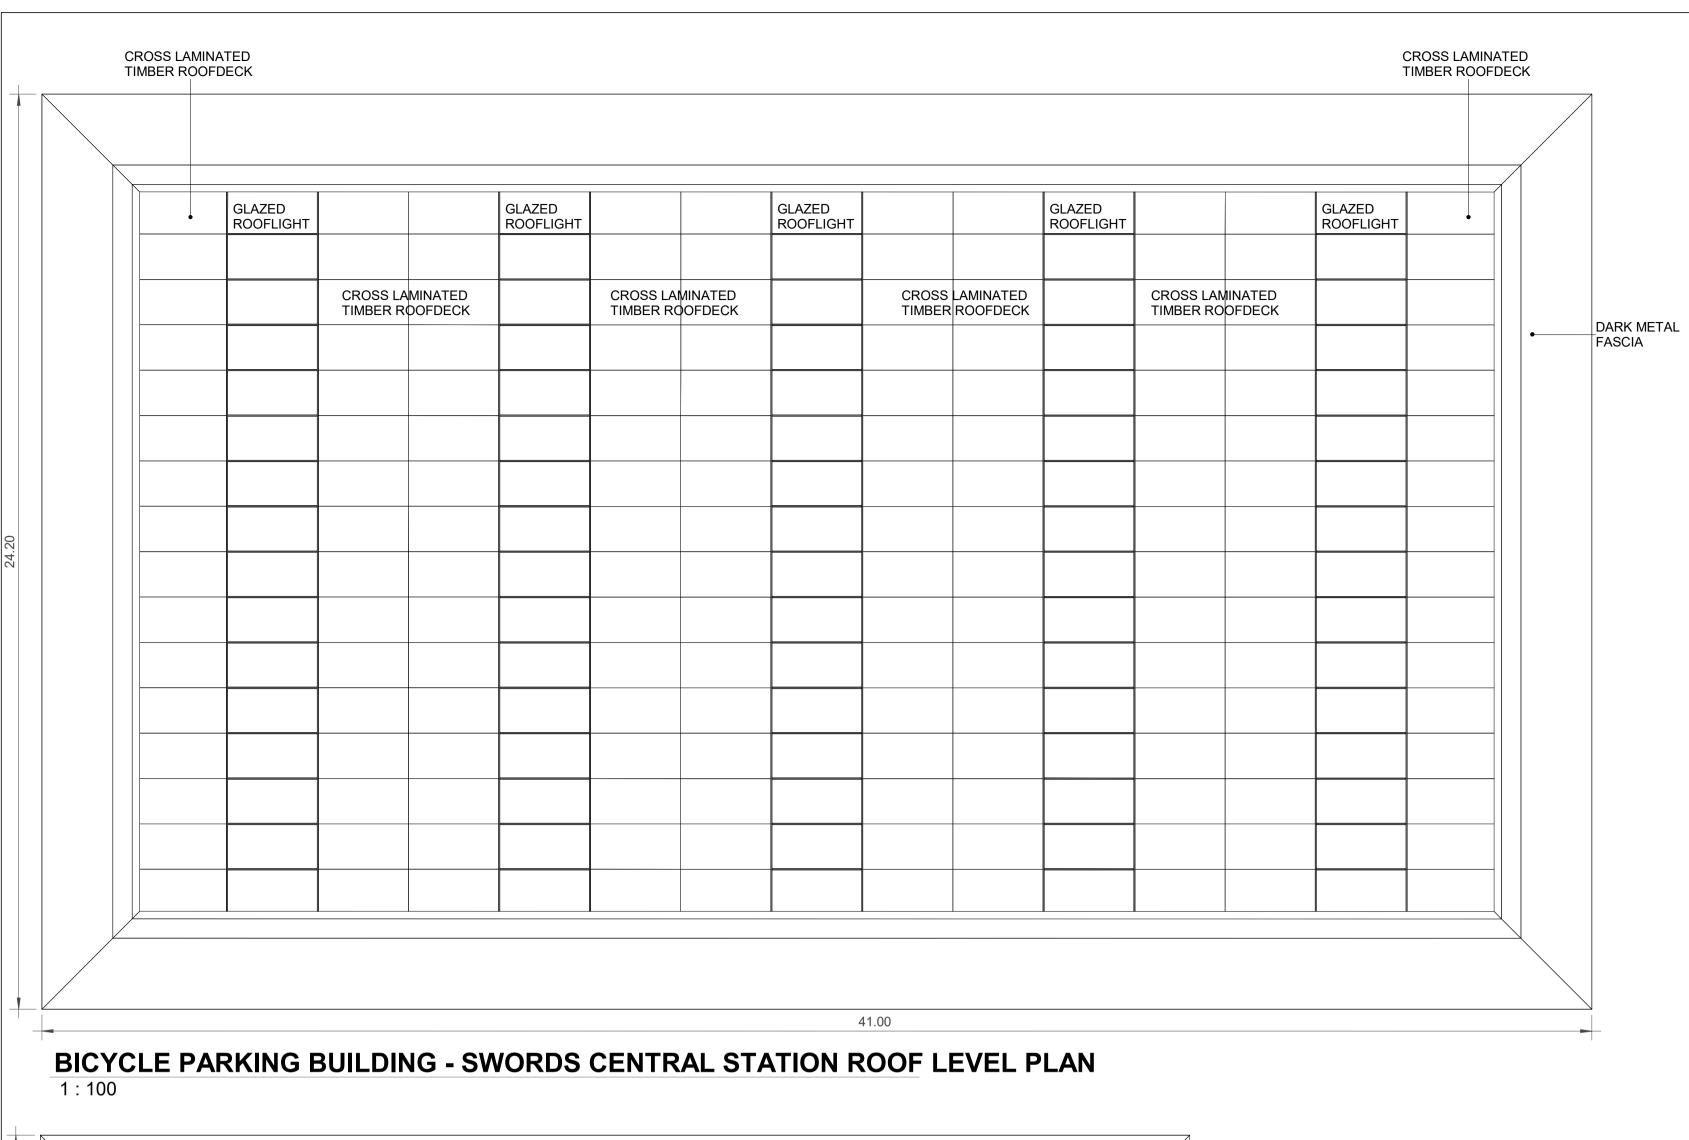

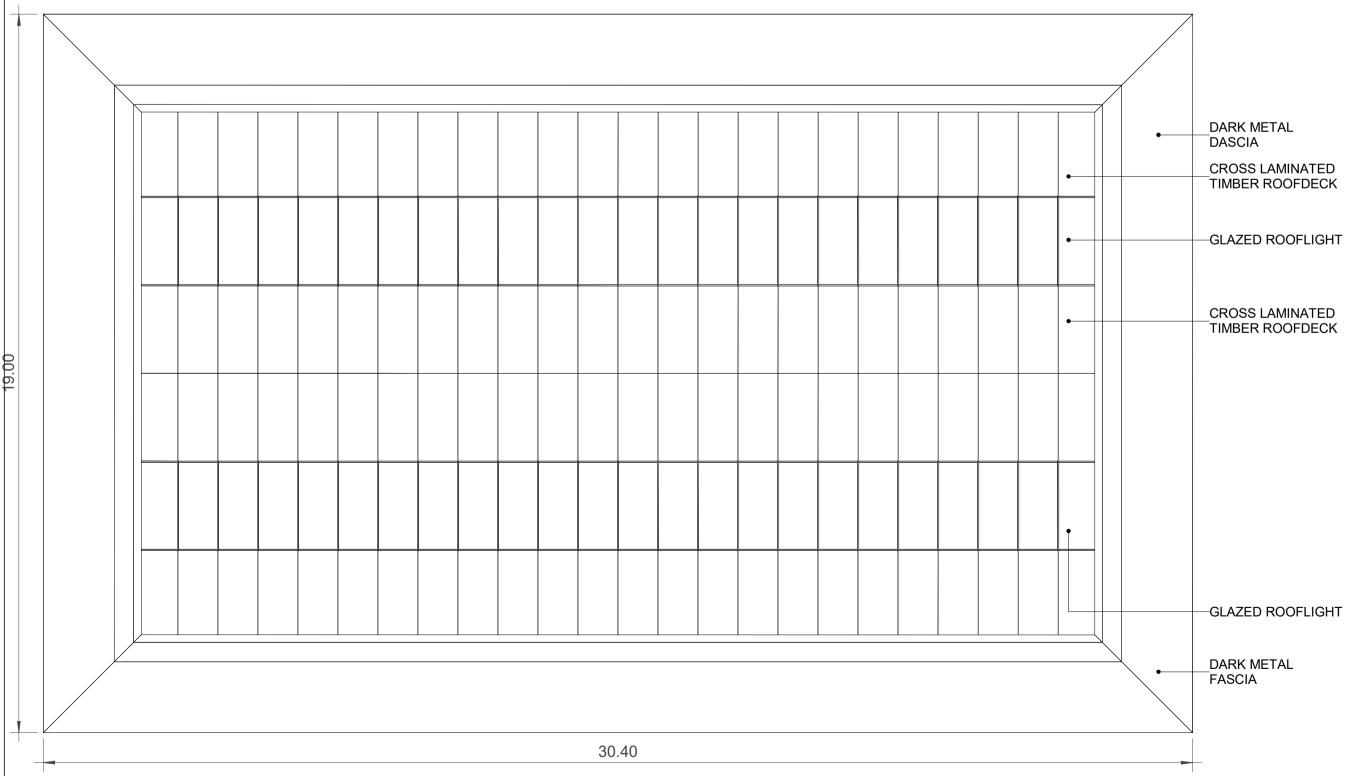


BICYCLE PARKING BUILDING - SEATOWN AND FOSTERSTOWN STATIONS ROOF LEVEL PLAN

1:100


TIMBER SOFFIT GLULAM PRIMARY DARK METAL SLIDING DOOR W/ KEY FOB ACCESS— W/ INSECT MESH STRUCTURE FASCIA DARK METAL MULLIONS-CANOPY LAMINATED GLAZED **PANELS** DARK METAL BASE MULLION **BICYCLE BICYCLE PARKING** PARKING BUILDING BUILDING ACCESS ACCESS

TYPICAL BICYCLE PARKING BUILDING - SOUTH ELEVATION

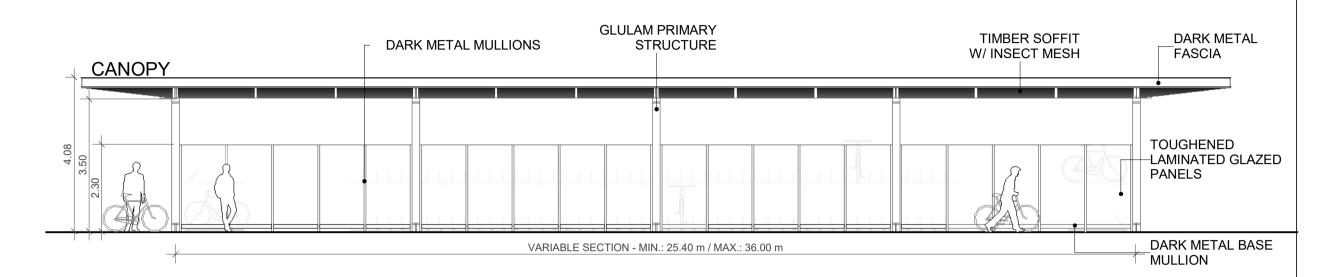


TYPICAL BICYCLE PARKING BUILDING - NORTH ELEVATION

1:100

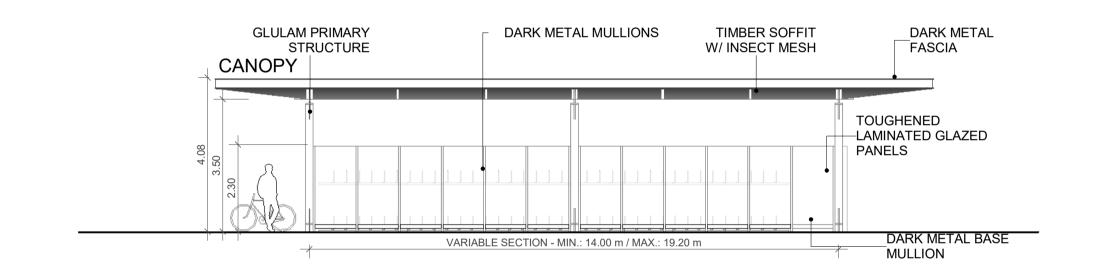

TYPICAL BICYCLE PARKING BUILDING - WEST ELEVATION

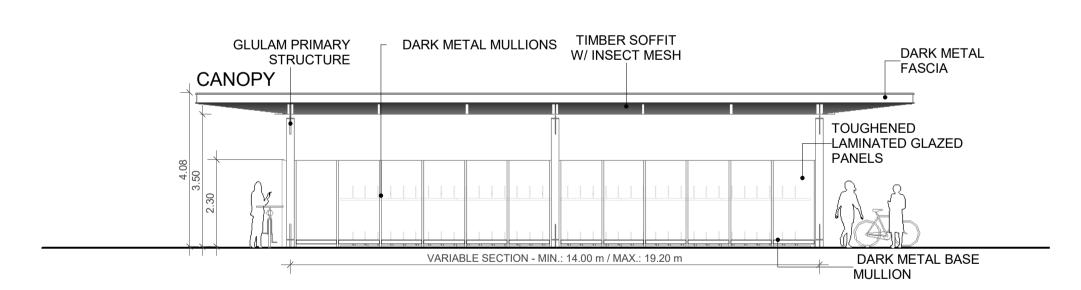

TYPICAL BICYCLE PARKING BUILDING - EAST ELEVATION

STATION	CYCLE HUB SPACES	SHEFFIELD STANDS SPACES	TOTAL SPACES	BUILDING DIMENSIONS
Seatown Station	358	138	496	25.40m x 14.00m
Swords Central Station	708	264	972	36.00m x 19.20m
Fosterstown Station	378	80	458	25.40m x 14.00m


1. FOR DETAILS OF UTILITIES, SEE BOOK OF UTILITY DRAWINGS (DRAWINGS COMMENCING ML-UC) AND BOOK OF SURFACE WATER DRAWINGS (DRAWINGS COMMENCING ML-UN).


2. FOR DETAILS OF GENERAL ARRANGEMENT (ALIGNMENT), SEE BOOK OF ALIGNMENT DRAWINGS (DRAWINGS COMMENCING ML-RO).


3. FOR LANDSCAPE DETAILS, SEE PROPOSED STREET LEVEL DESIGN PLAN AND STREET LEVEL ELEVATIONS DRAWINGS, IN BOOK OF STRUCTURES DRAWINGS (DRAWINGS COMMENCING ML-ST).


BICYCLE PARKING BUILDING - BICYCLE PROVISION


Sooter on the Clon far family and the Clon fam					TII	Project METROLINK	Drawing Title METROLINK - STRUCTURES BICYCLE PARKING BUILDING	Drawing Status S0
303 305 306 307 Swords Dublin	P01 MAY. 22 FOR RAILWAY ORDER REV. DATE Description © National Roads Authority (NRA) 1994-2022. This drawing is confidential and the copyright in it is owned be copied or otherwise reproduced inwhole or in part or used for any purpose without the prior permission of is an operational name of the National Roads Authority. © Ordnance Supervireland 2022/OSi, NMA, 273	DRAWN BY CHEC		PPROVED BY	Bonneager lompelr Étreenn Transport Infraedrukture troland Údarás Náisiúnta lompair National Transport Authority Consultant		Drawing N° ML1-JAI-SRD-ROUT_XX-DR-Y-08008 Plan Drawing N° ML-BP O-O1	
Airport River Liffey © Ordnance Survey Ireland	All elevations are in metres and relate to OSi Geoid Model (OSGM02) Malin Head as defined by existing All Co-ordinates are in Irish Transverse Mercator Grid (ITM) as defined by OSi active GPS station Tallagle	Project Control. ht College (TLLG).			JACOB5	IDOM	Scales Original Size A1 1: 100 Sheet	1 of 1

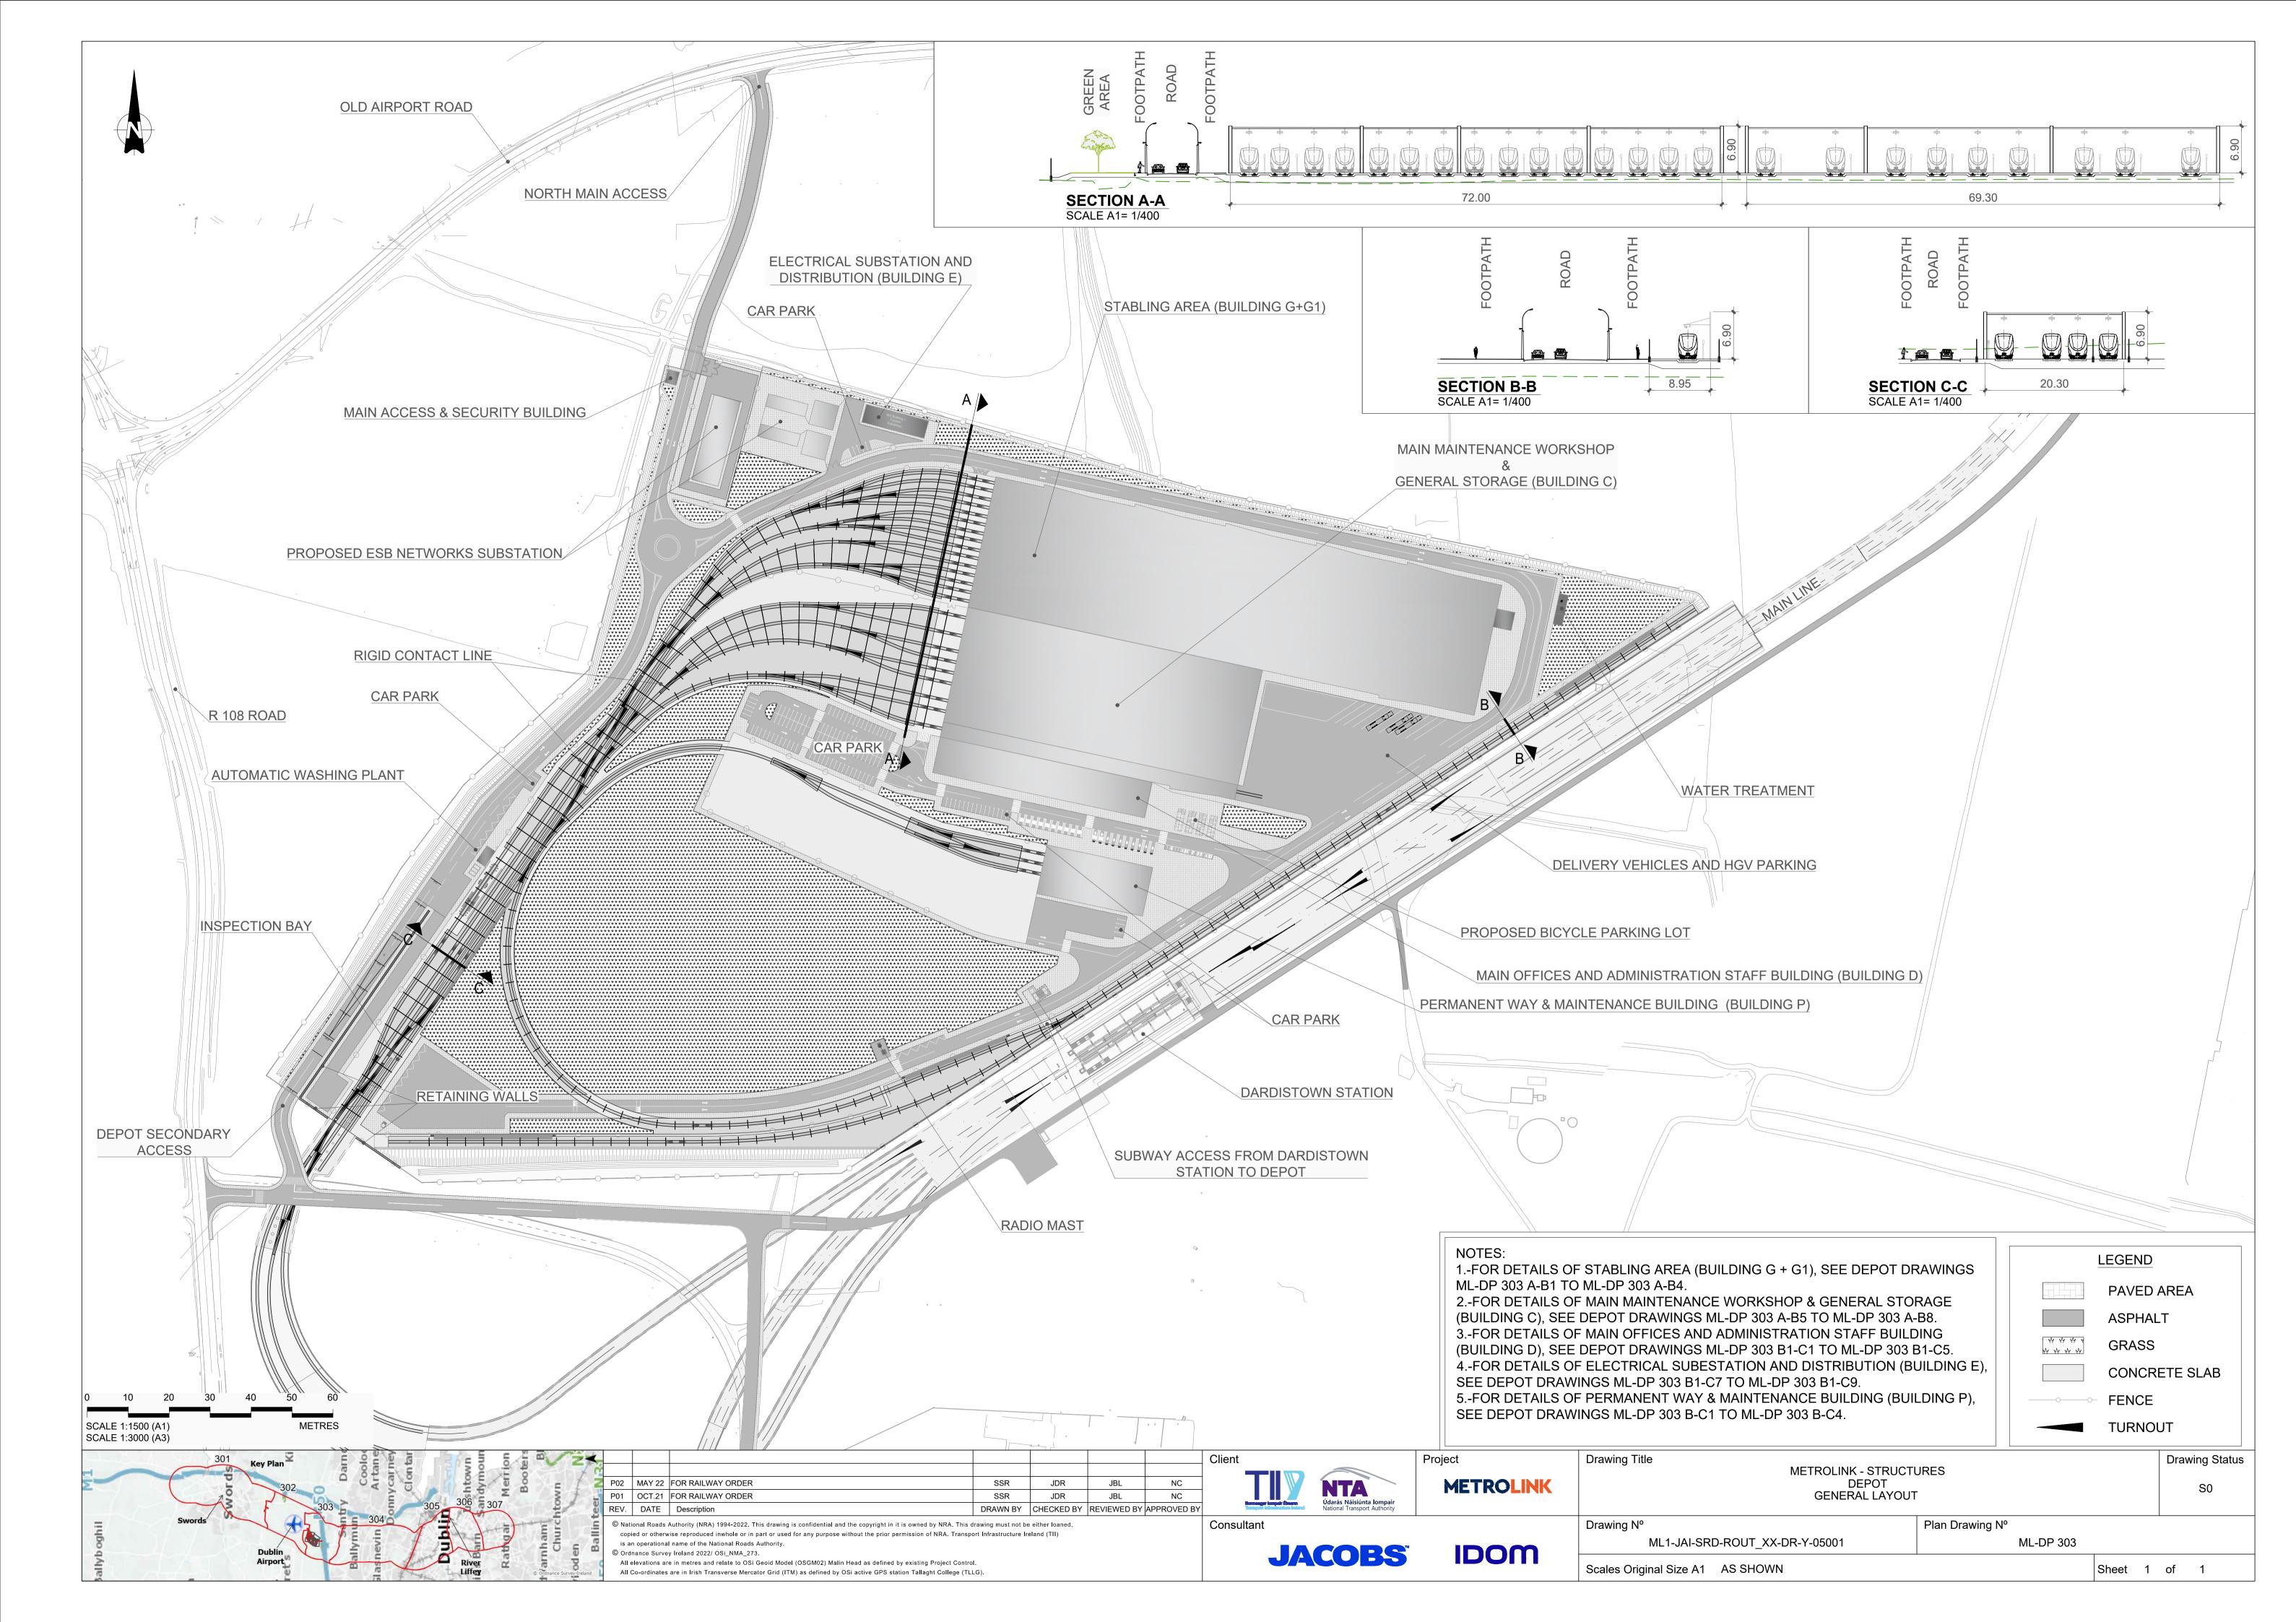


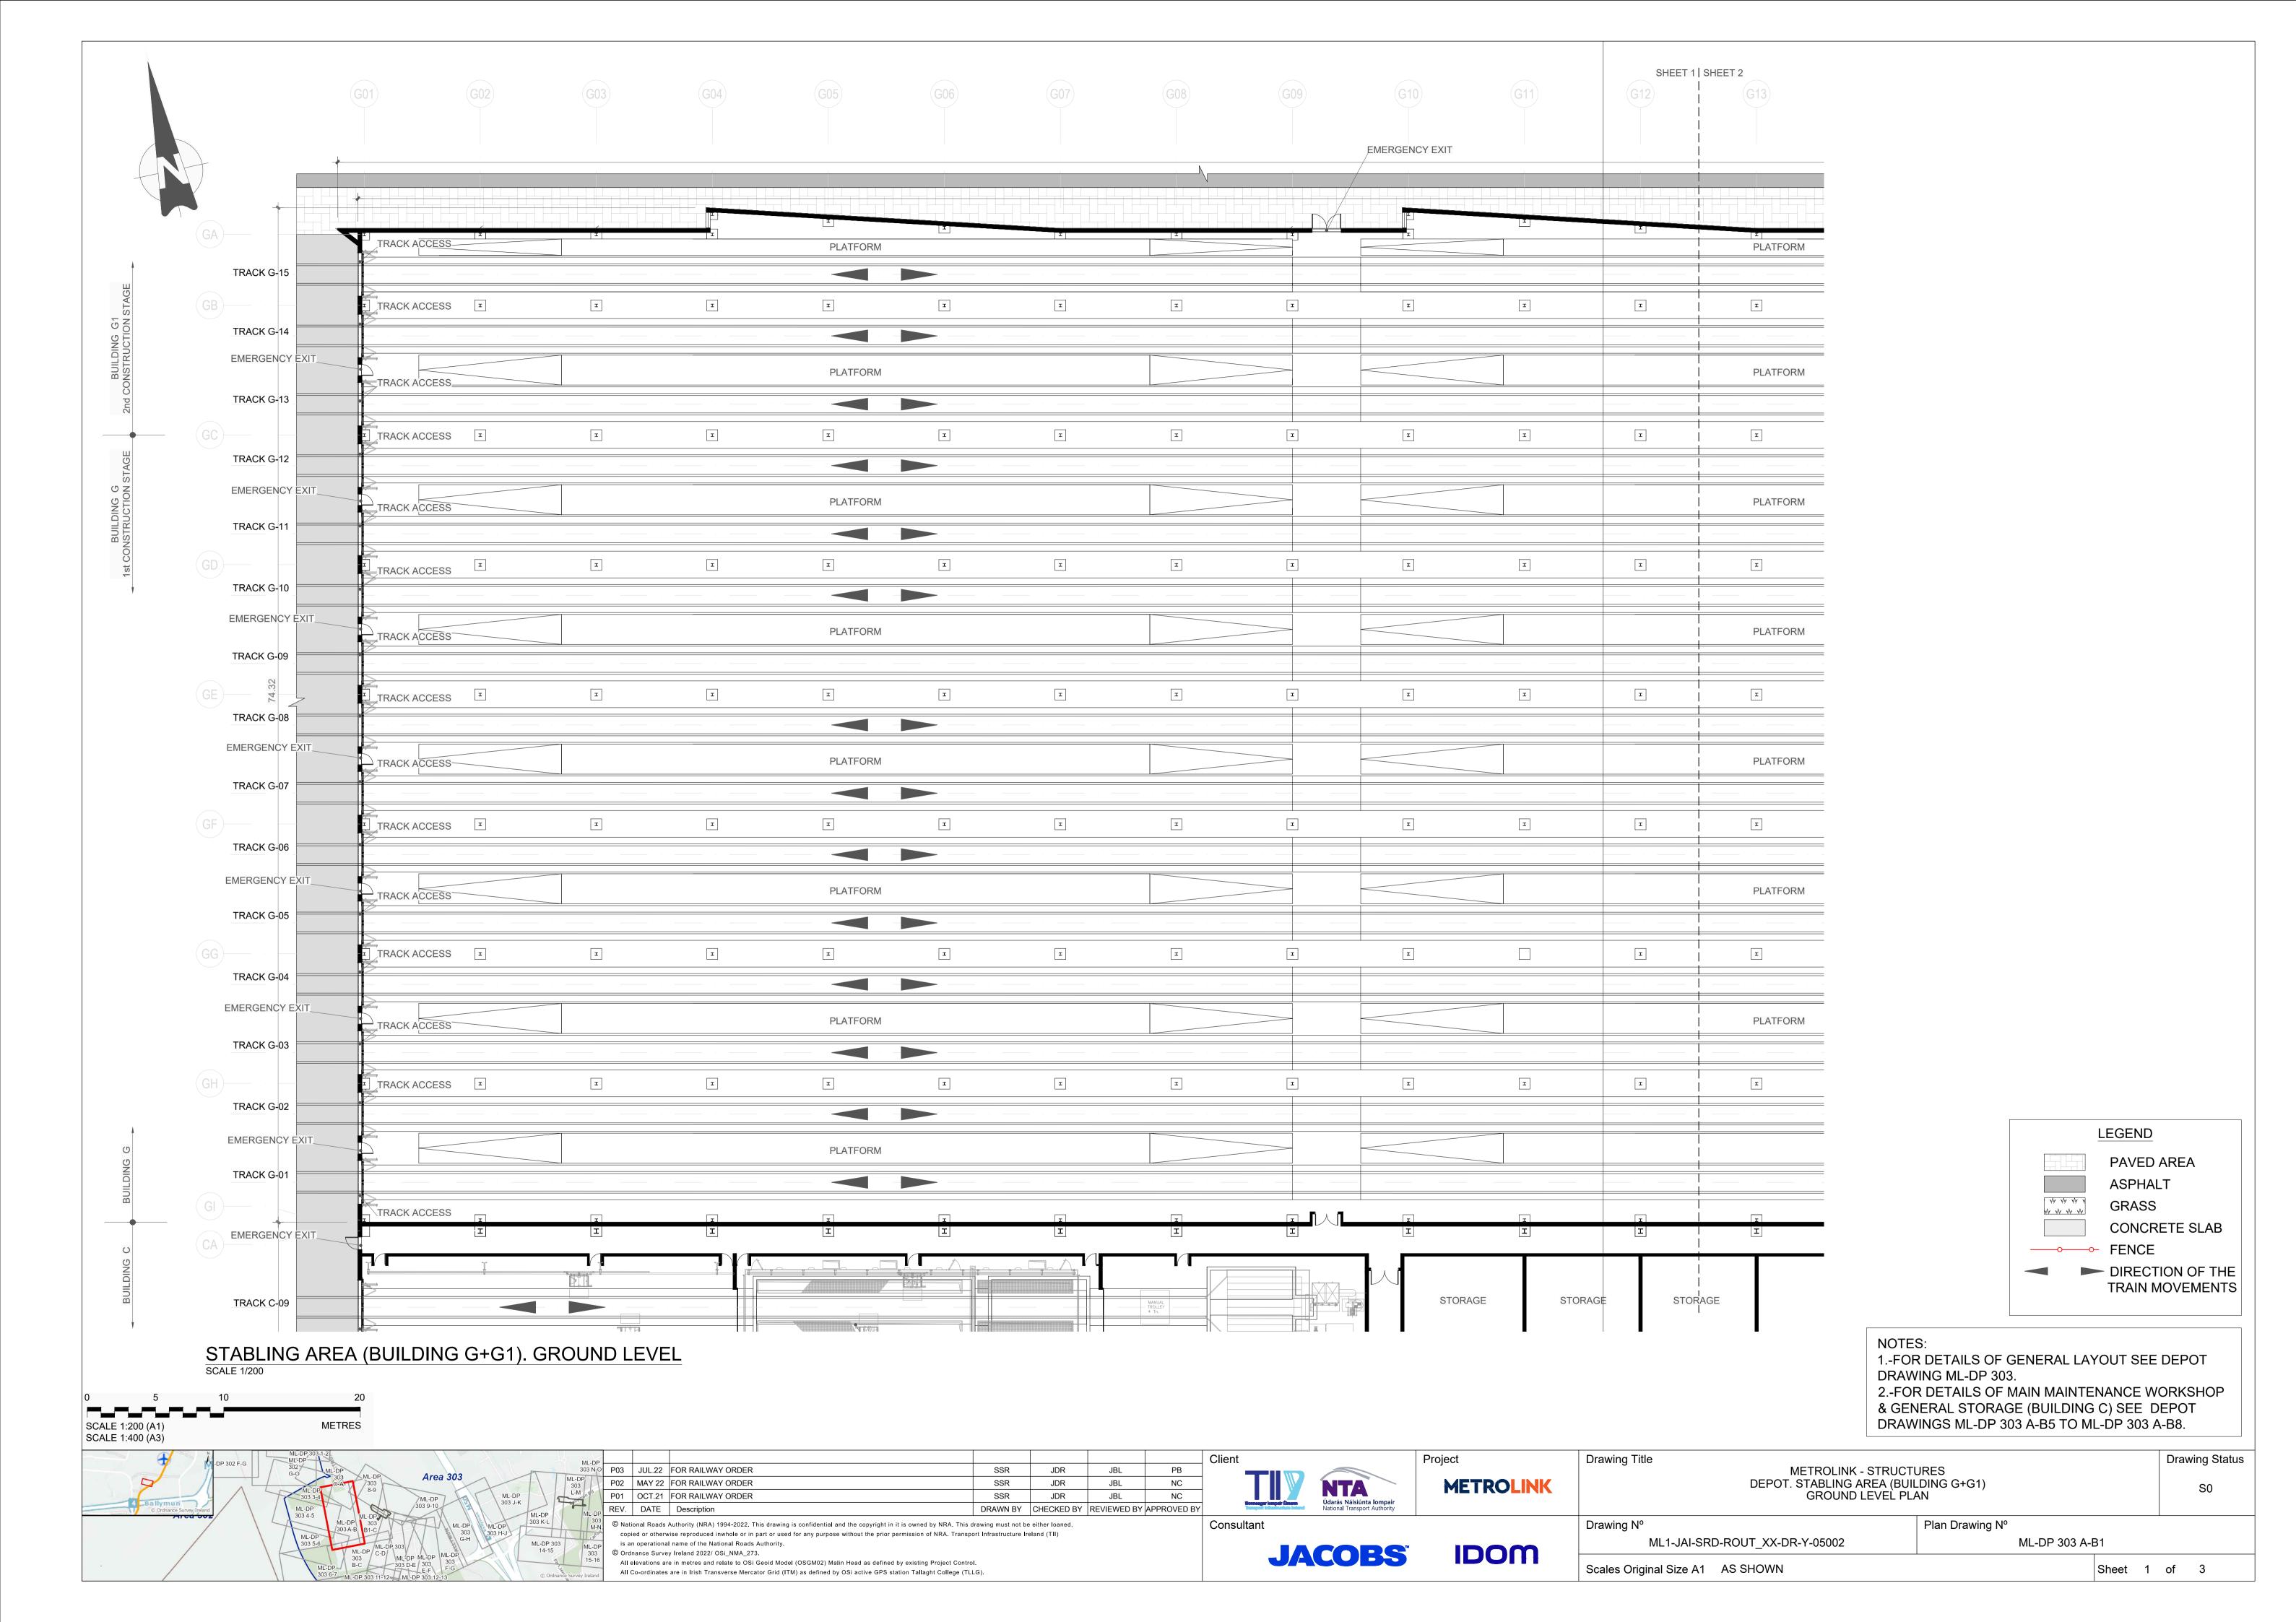


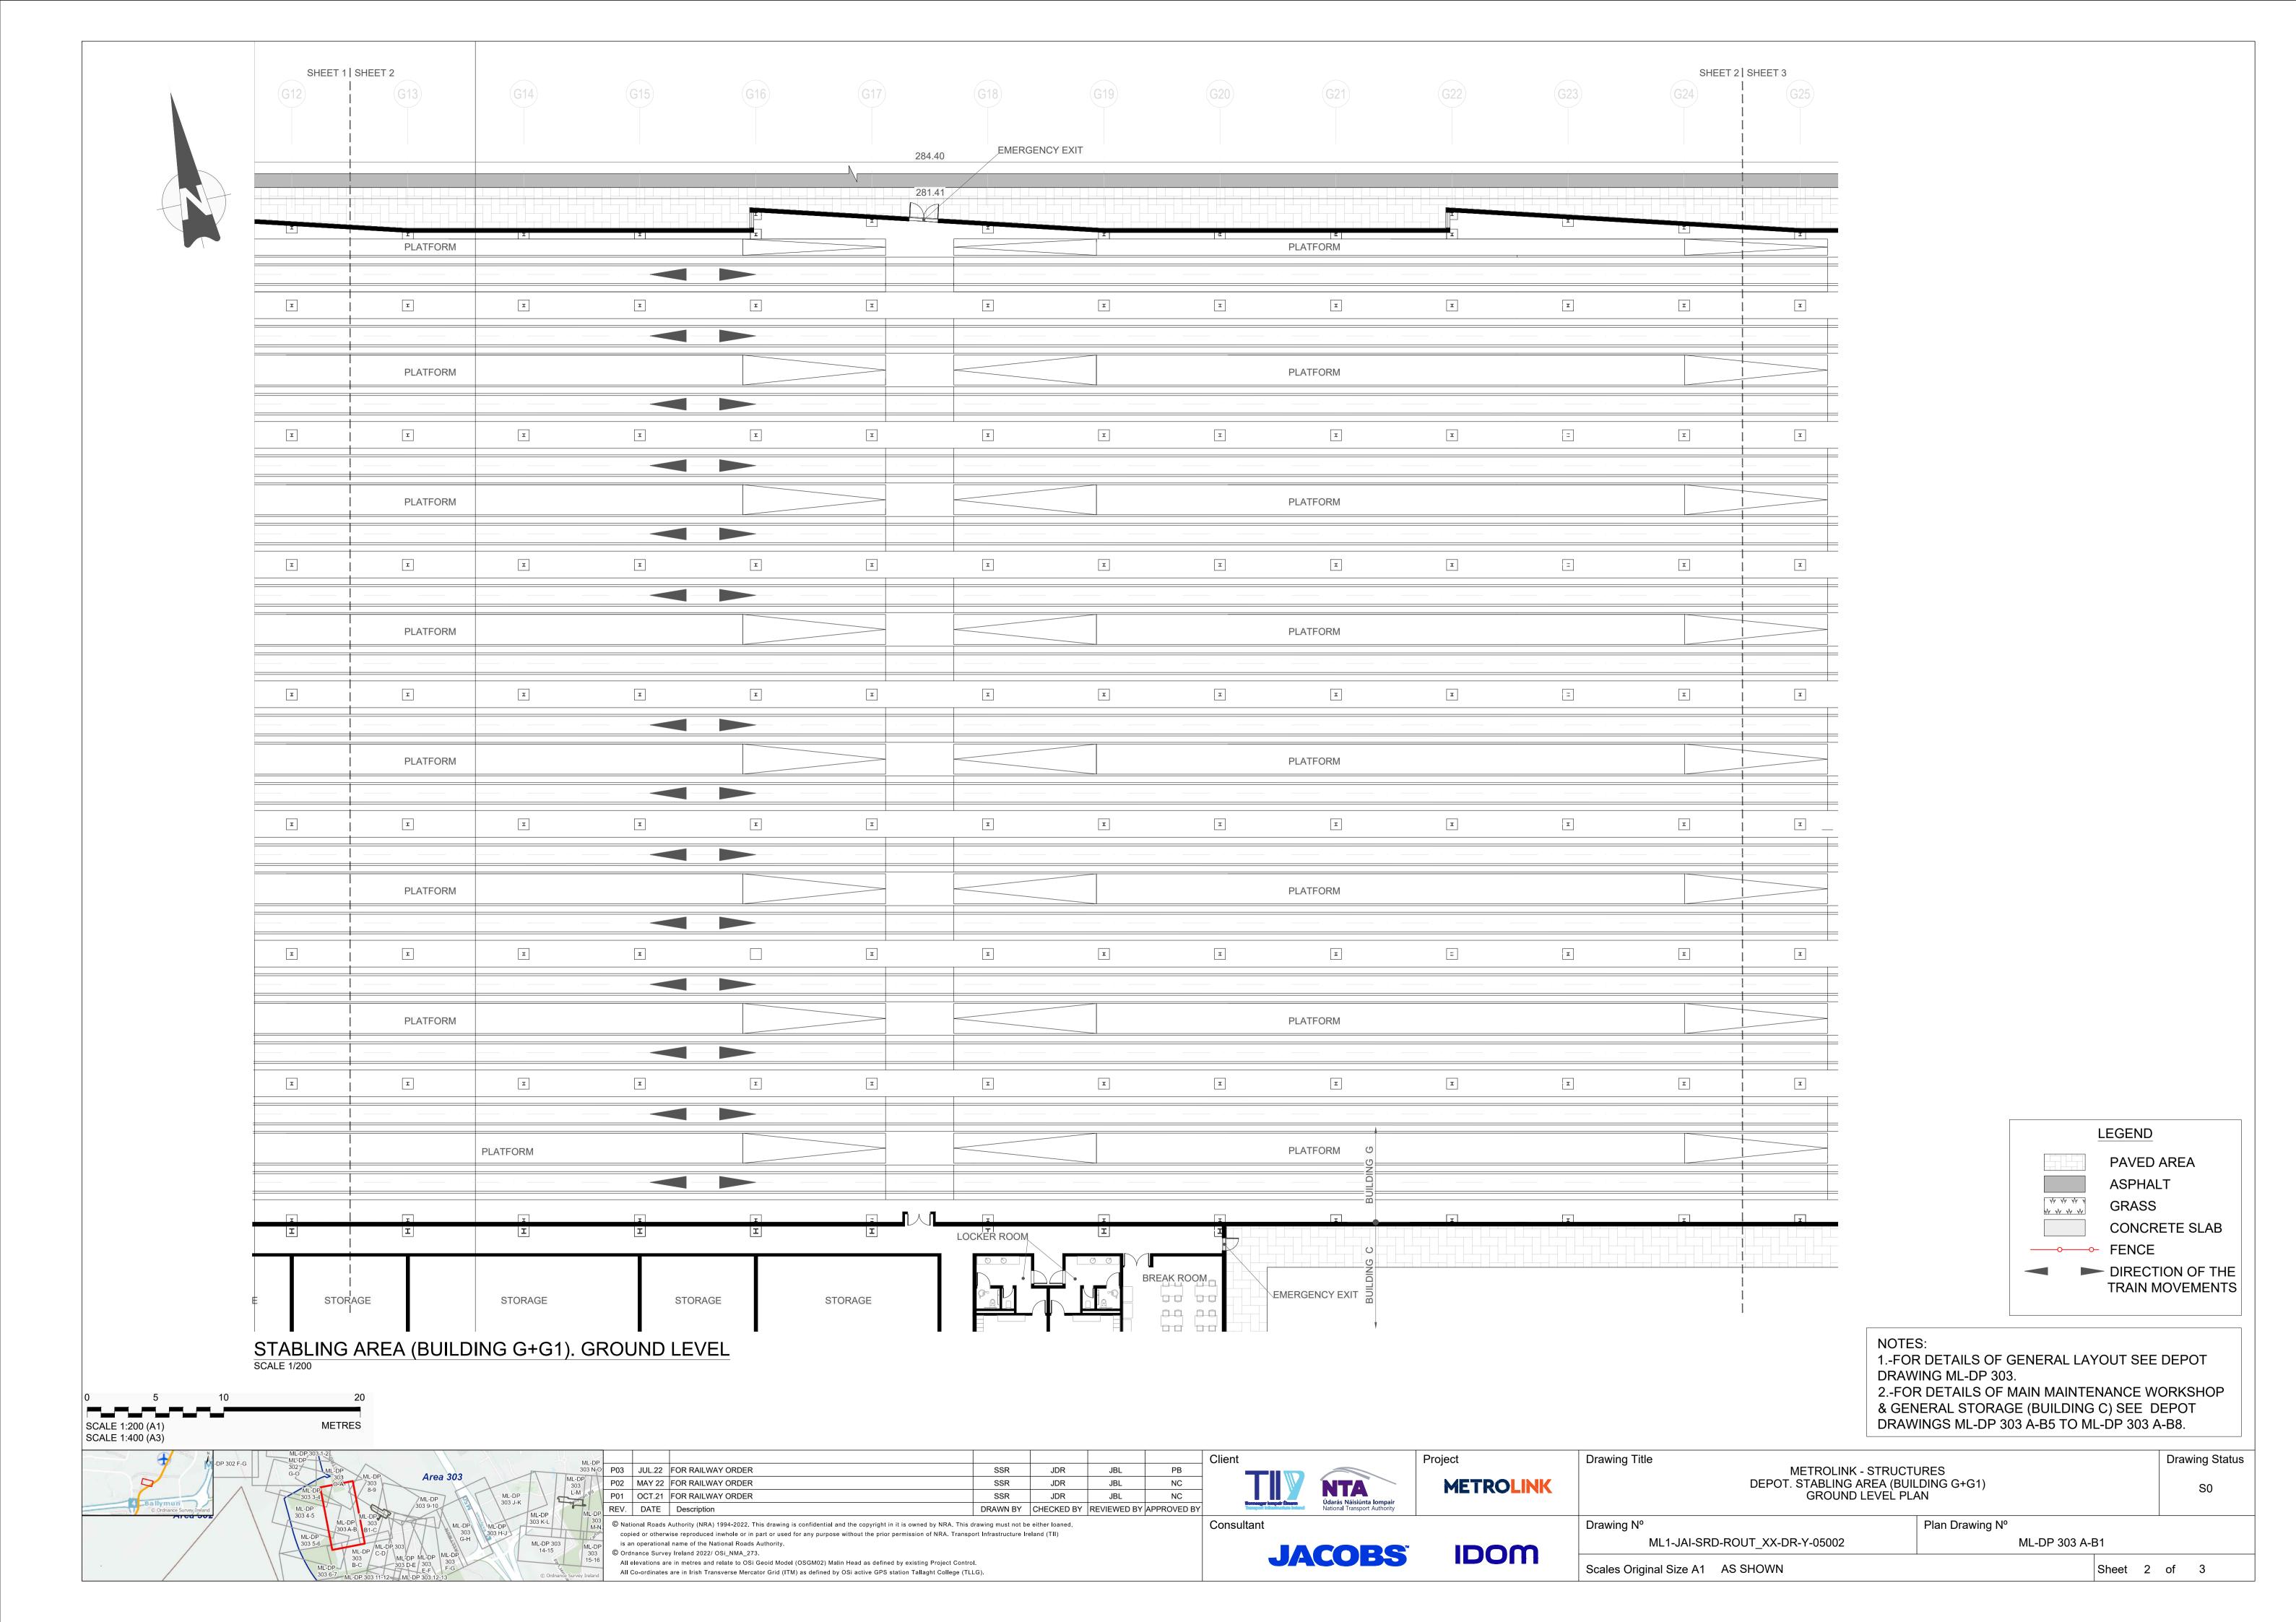


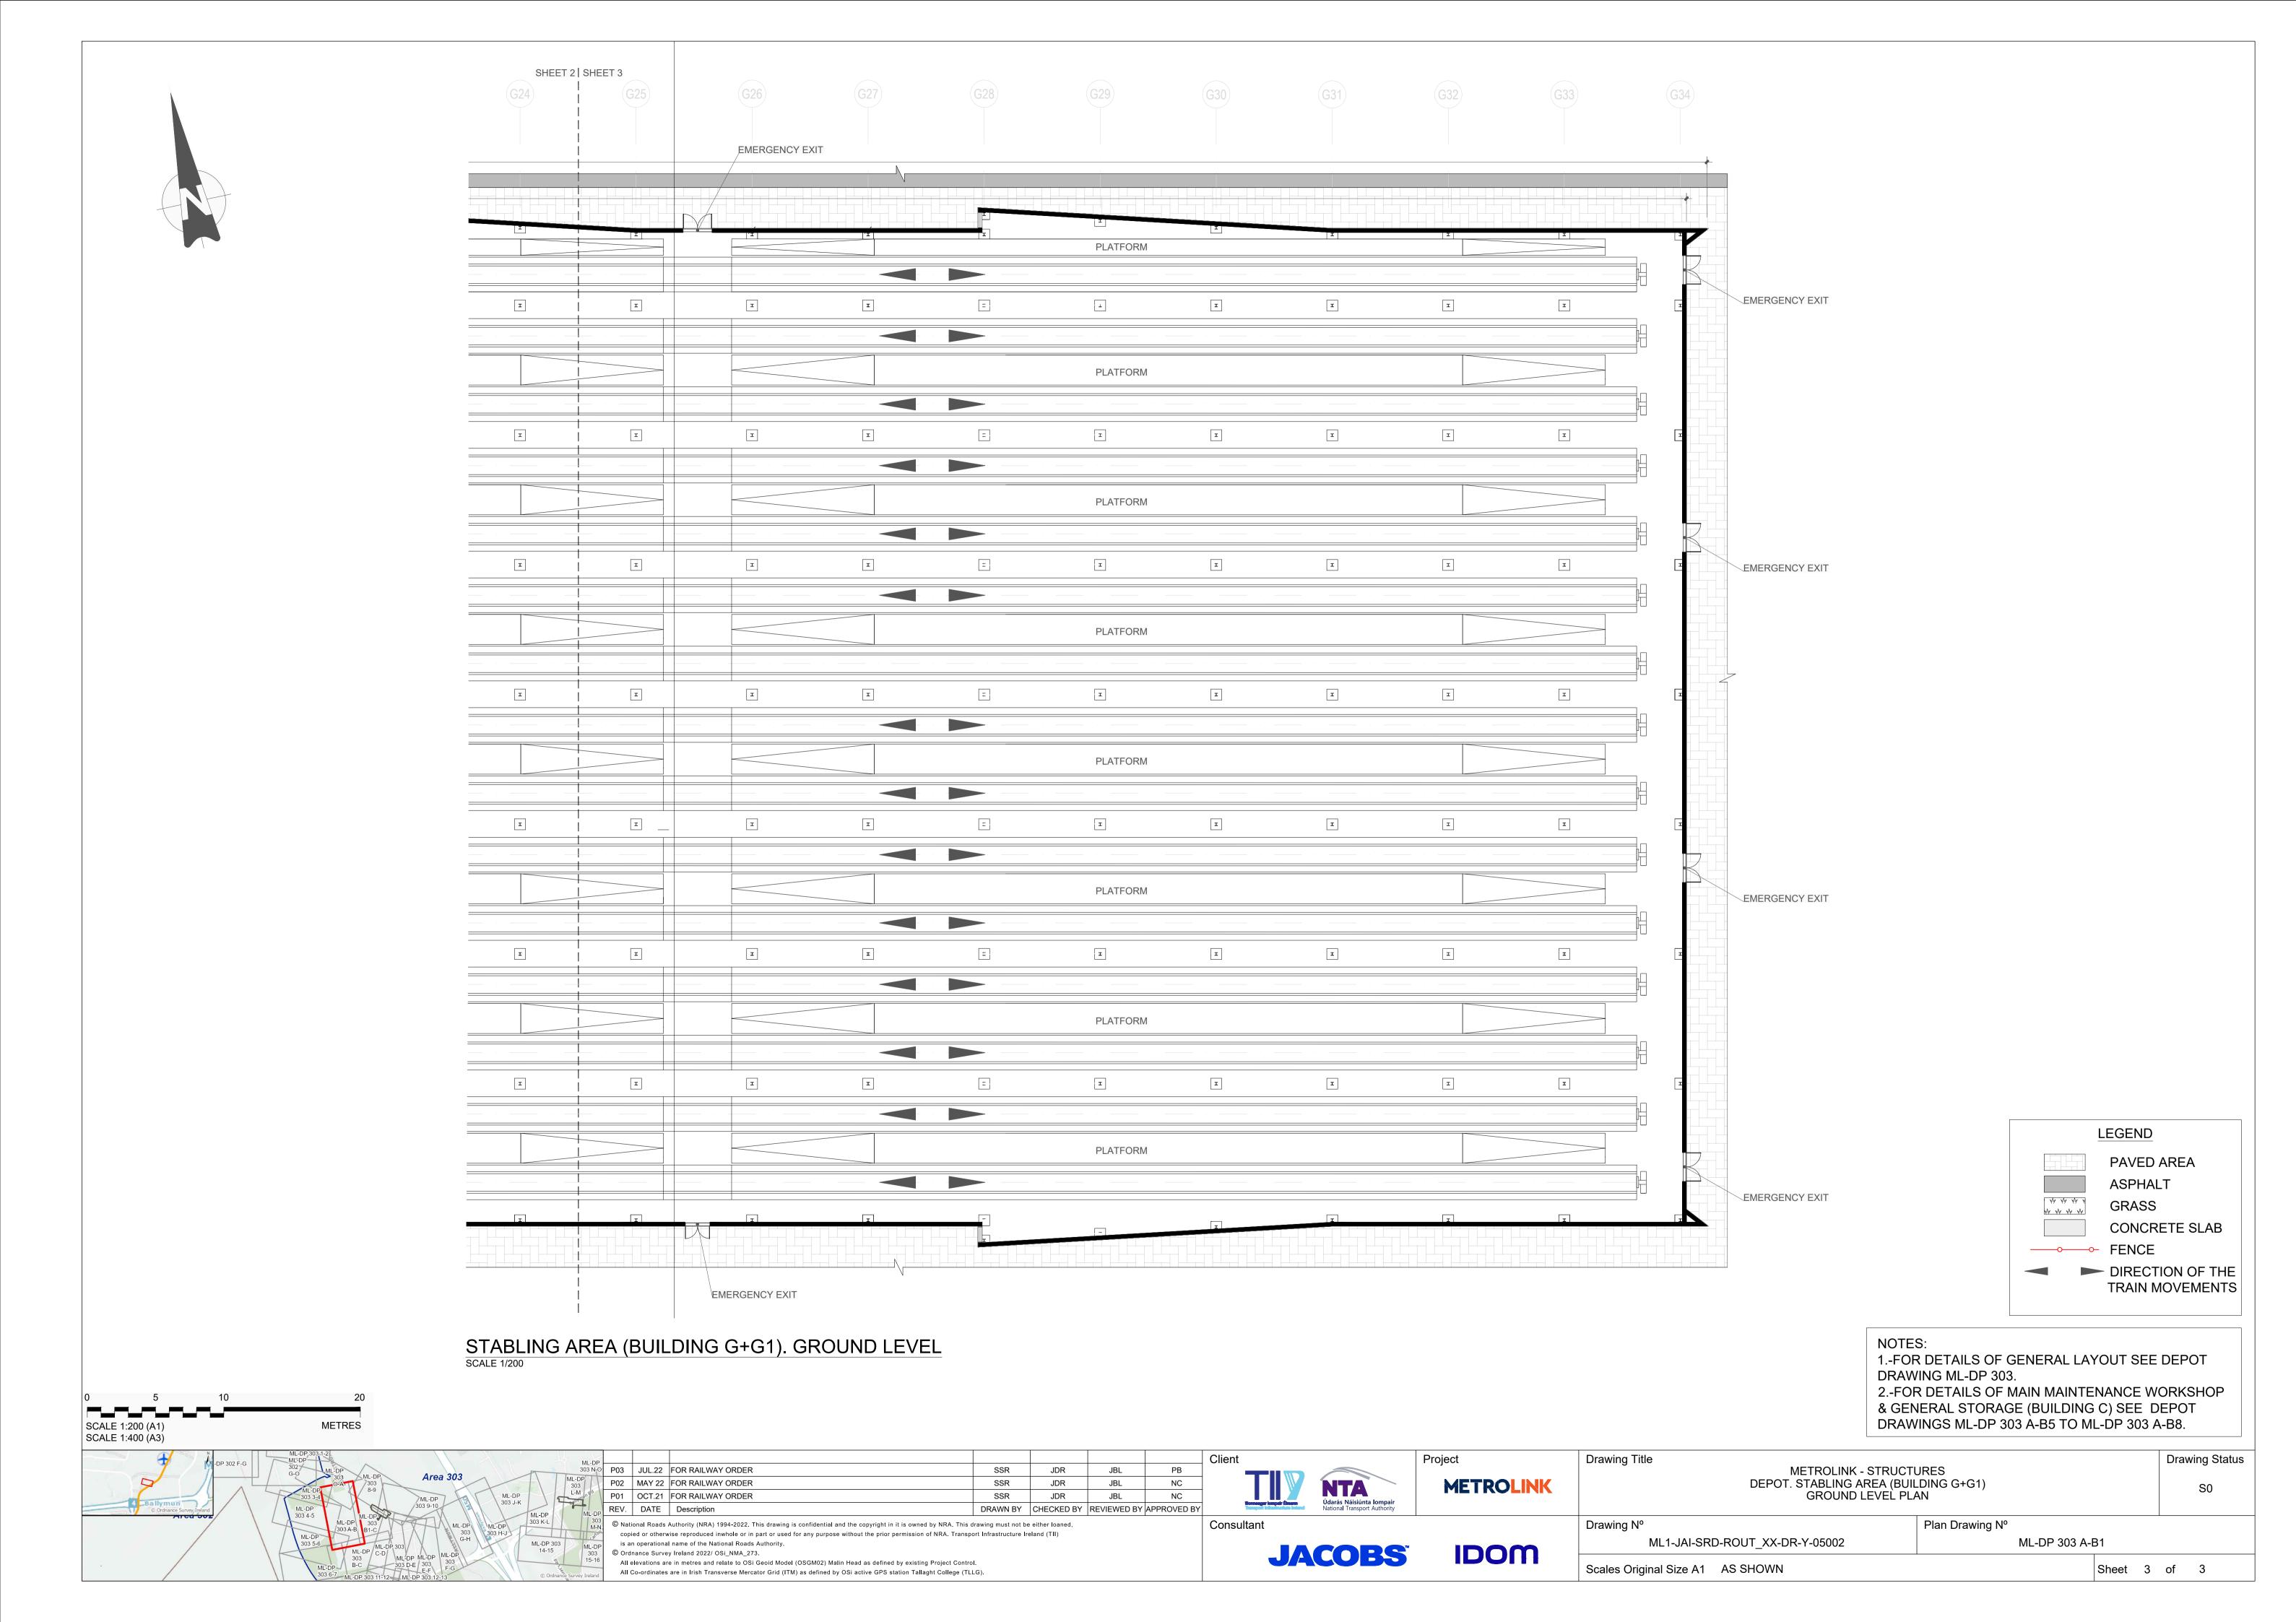


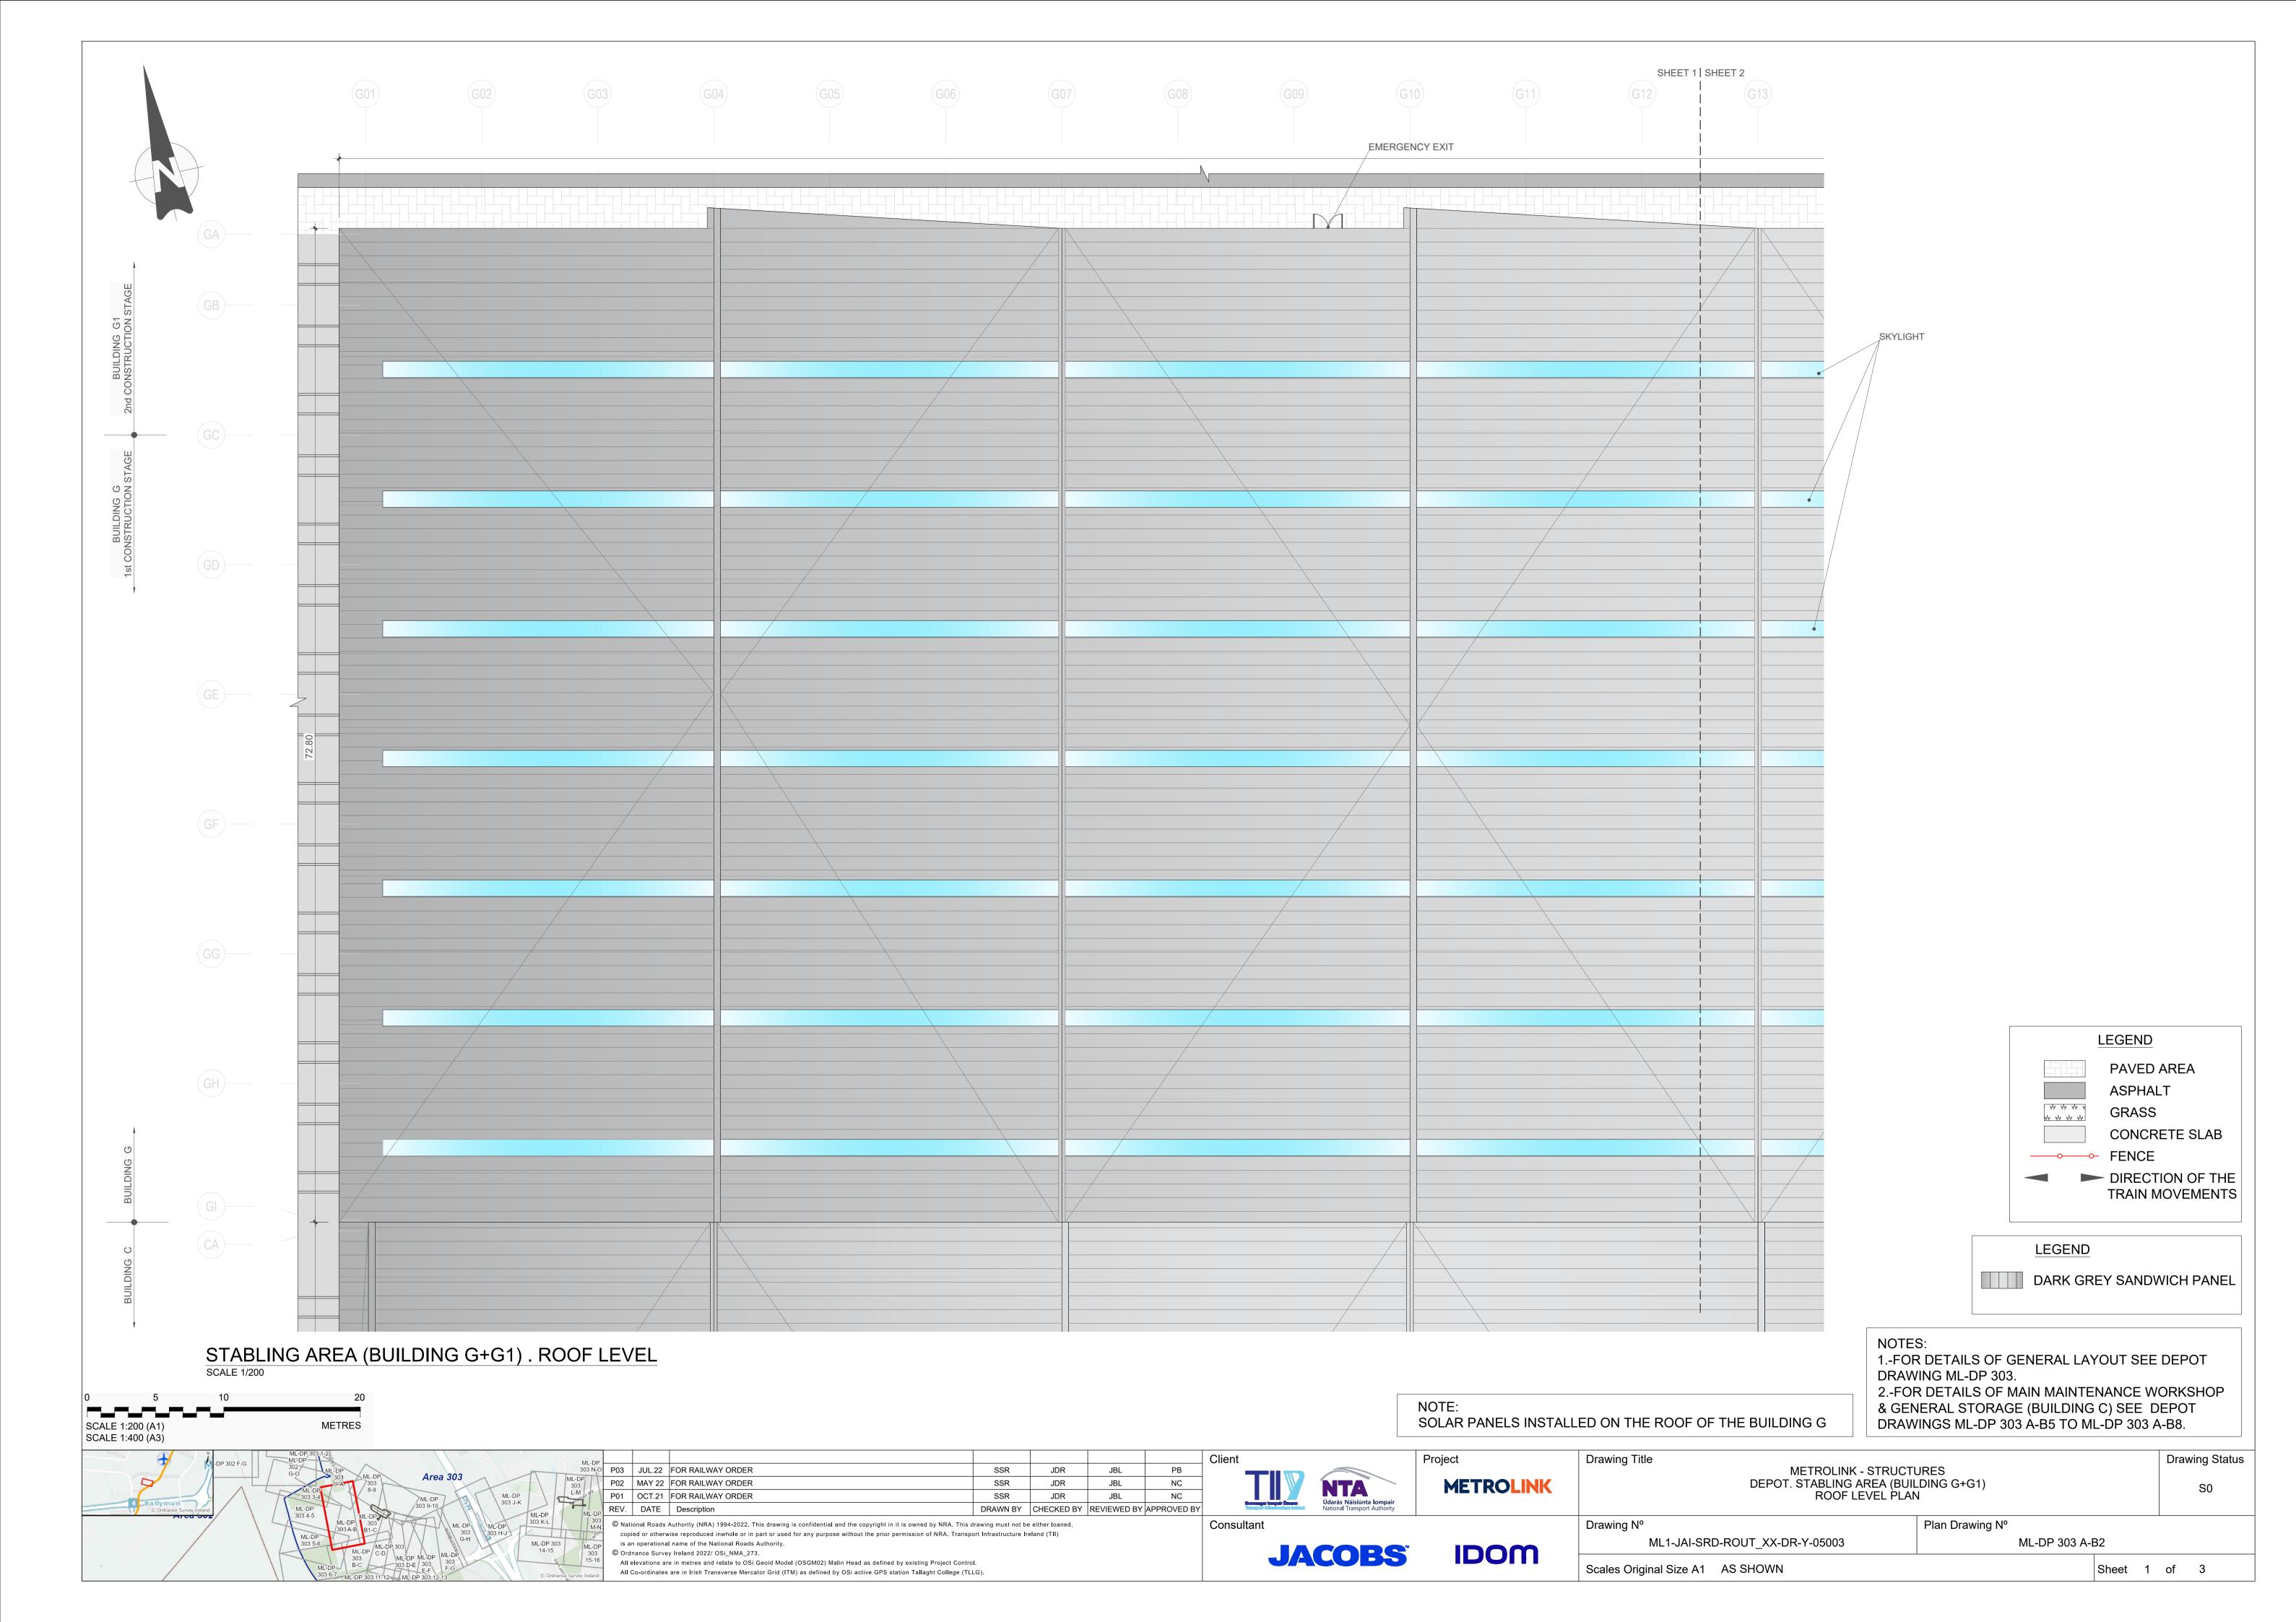

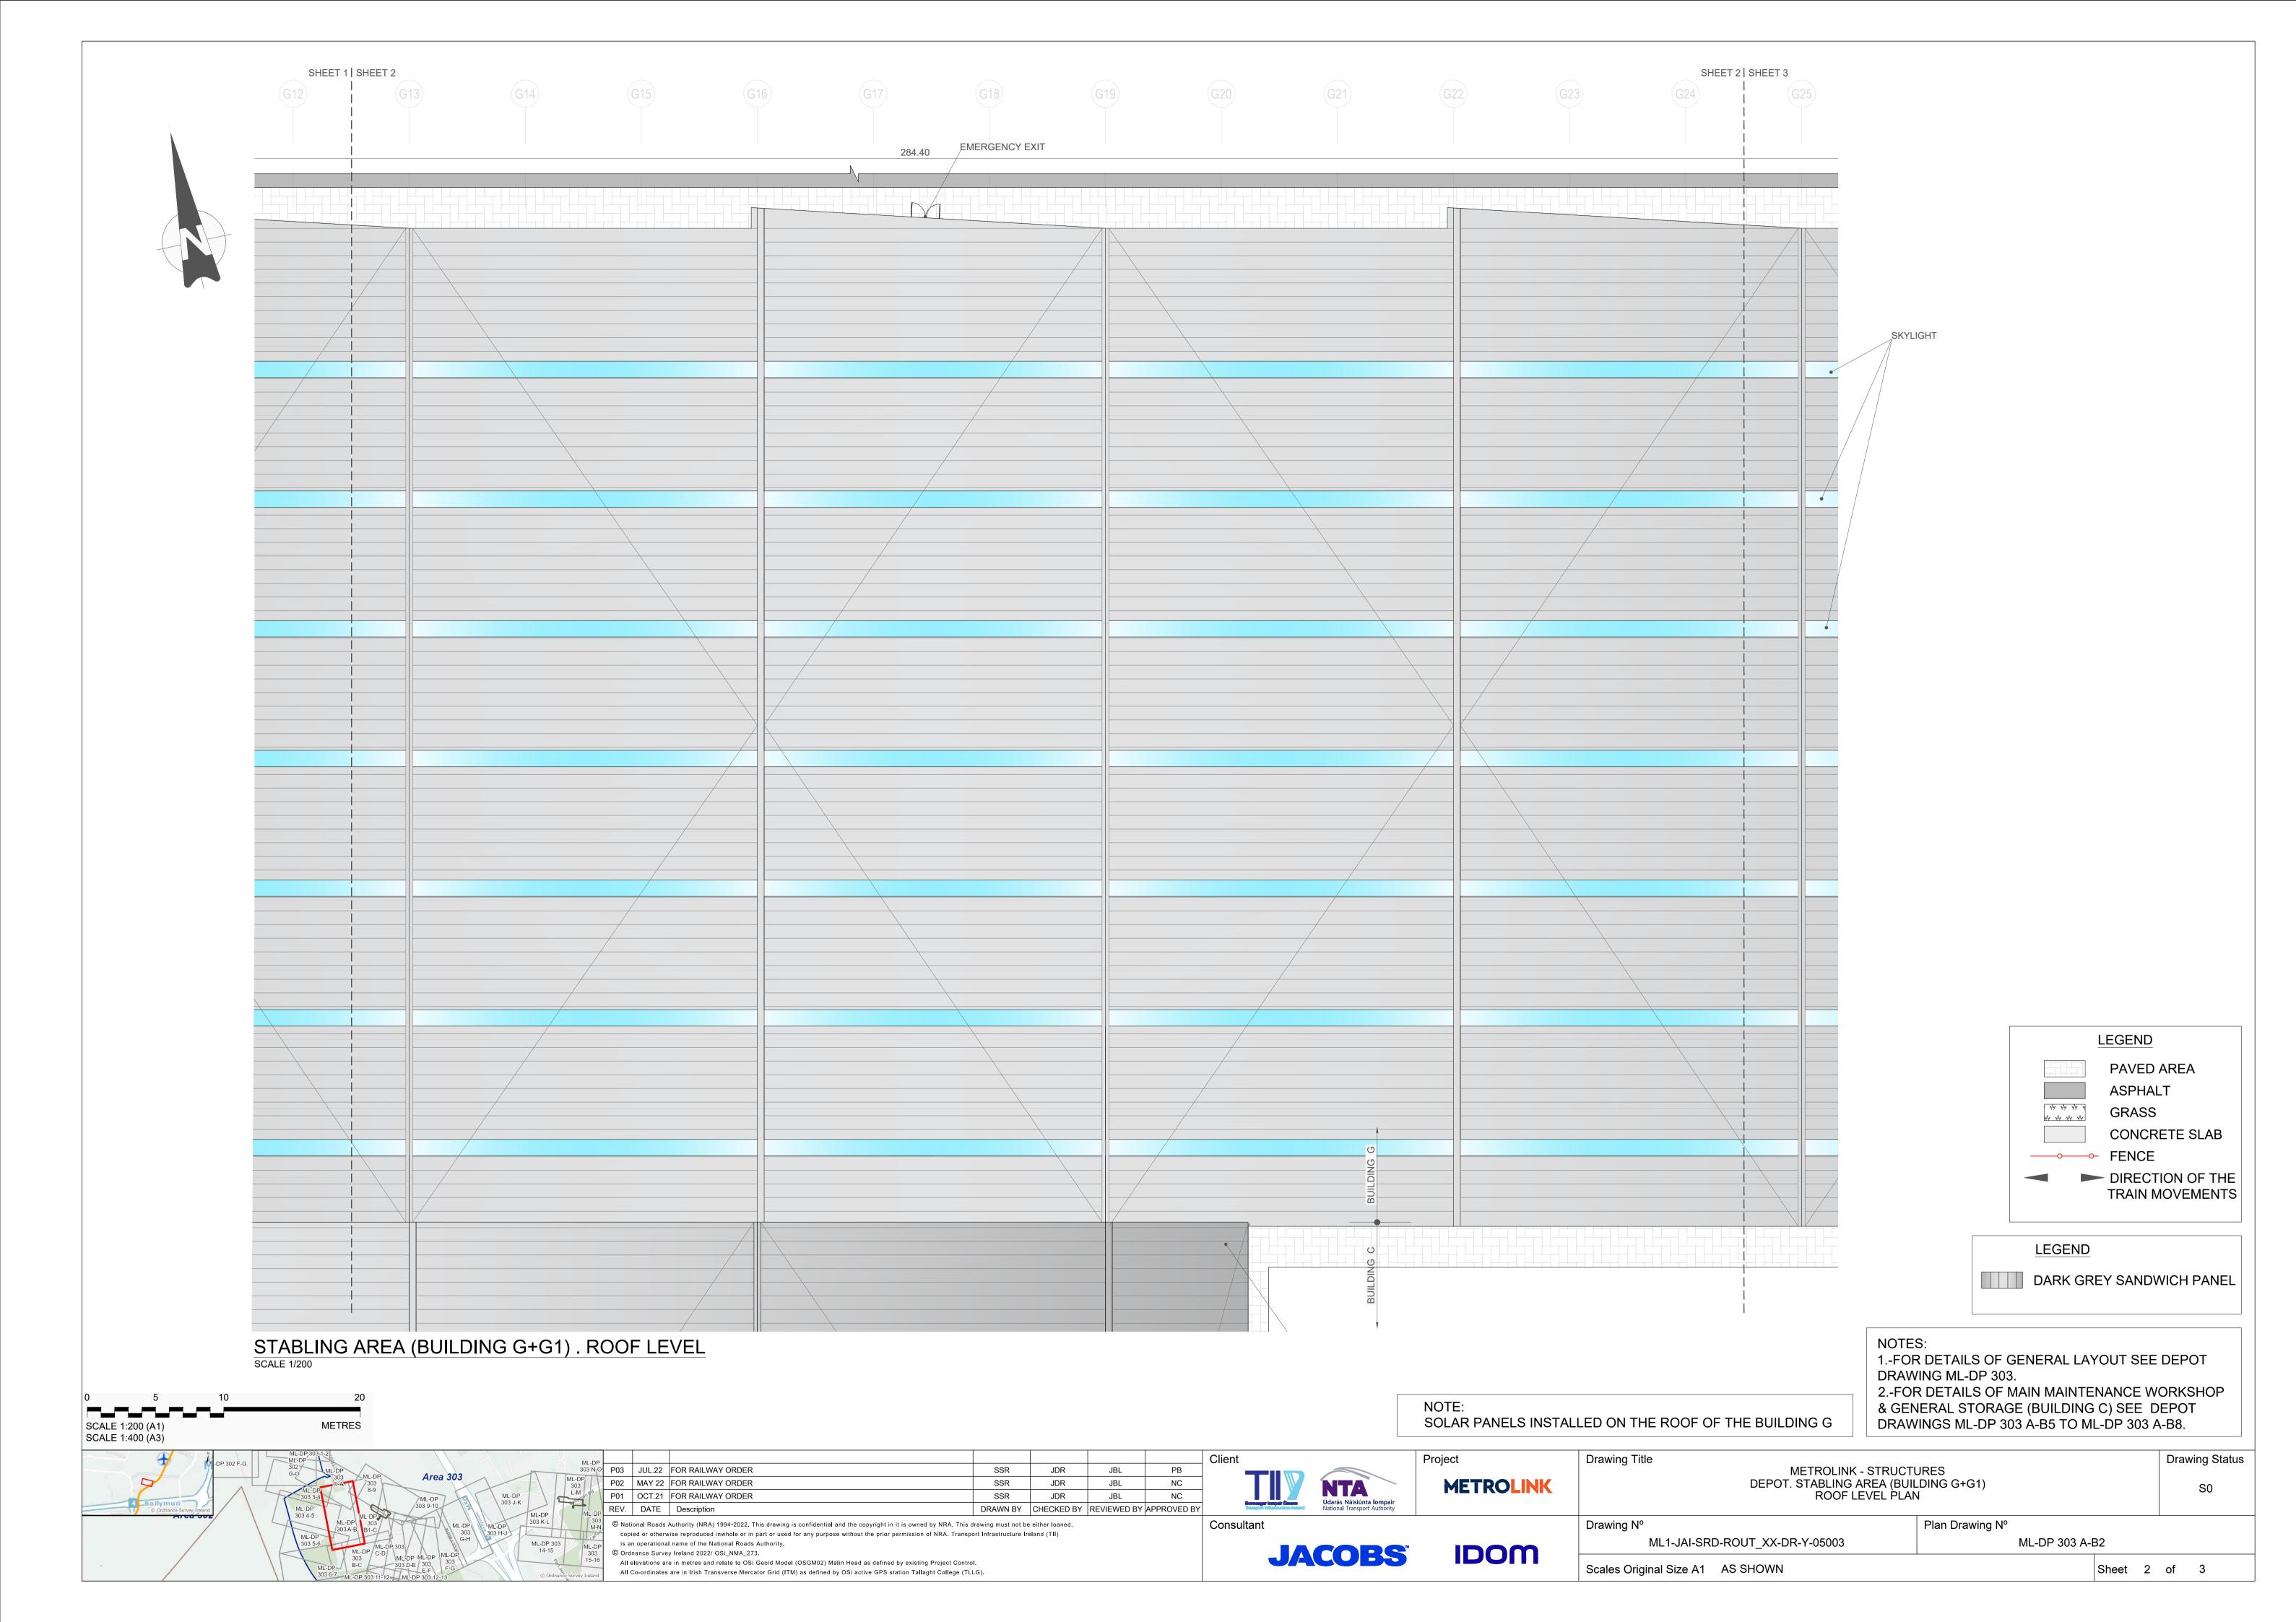

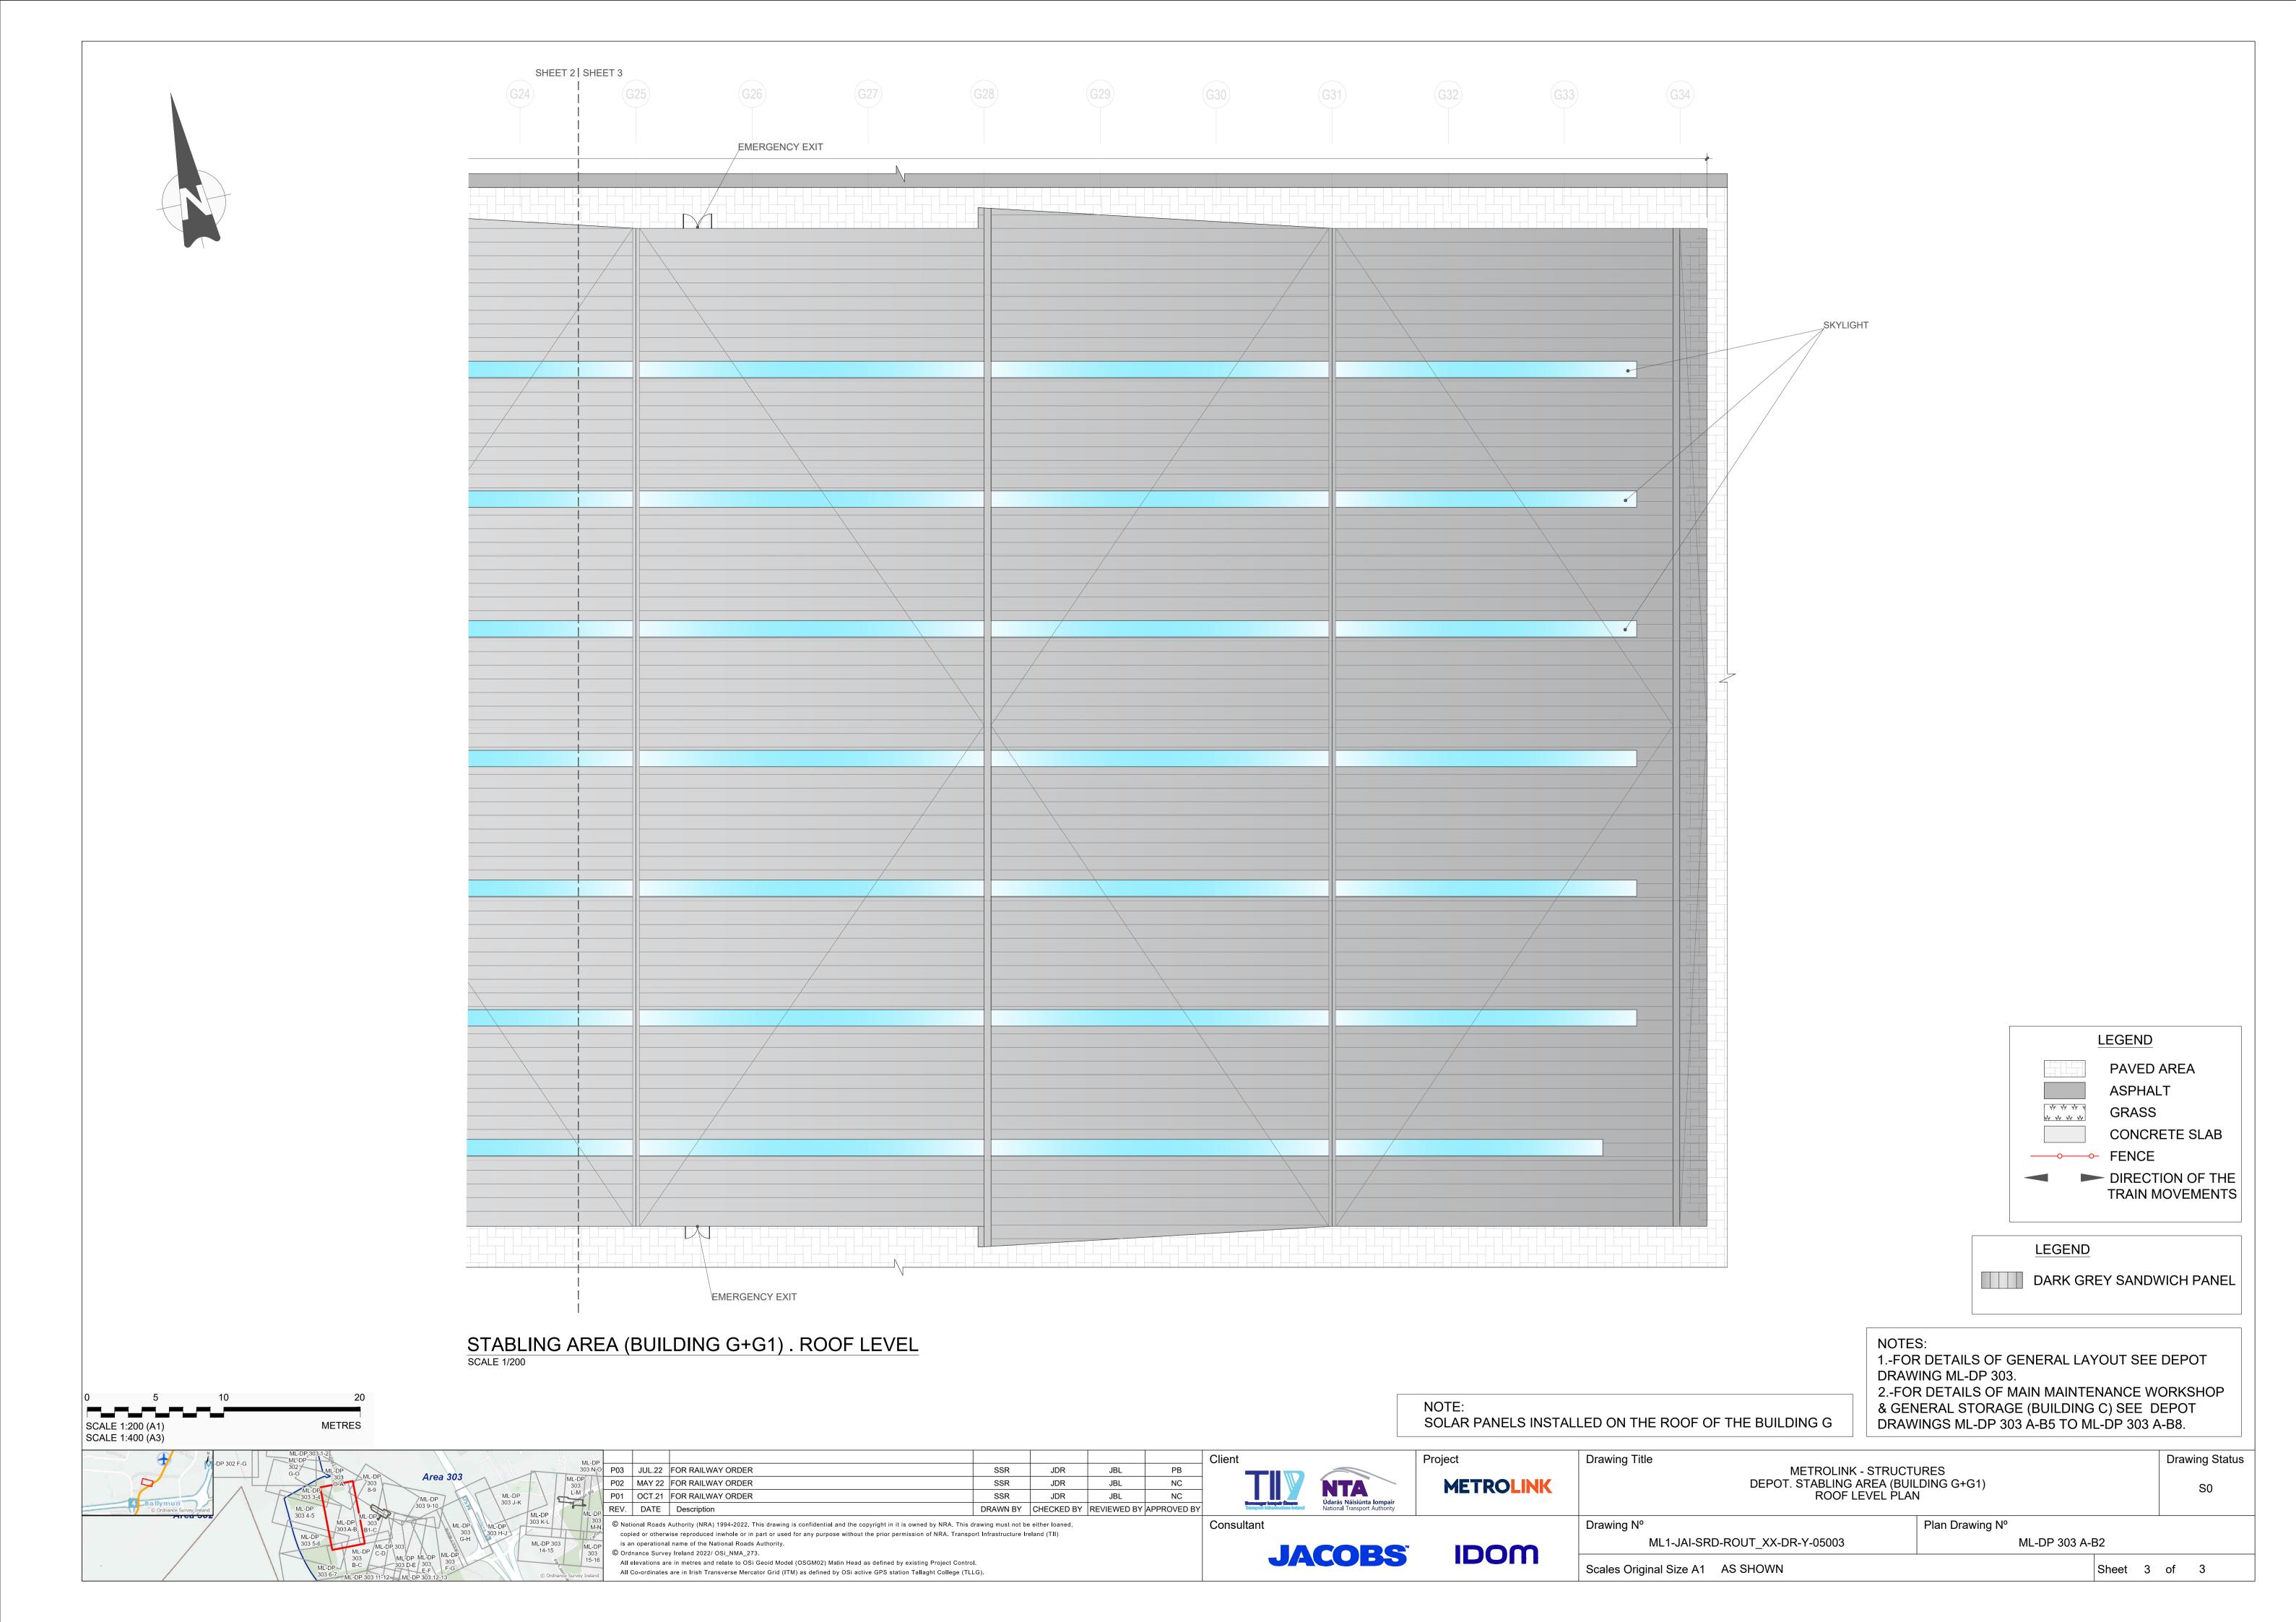


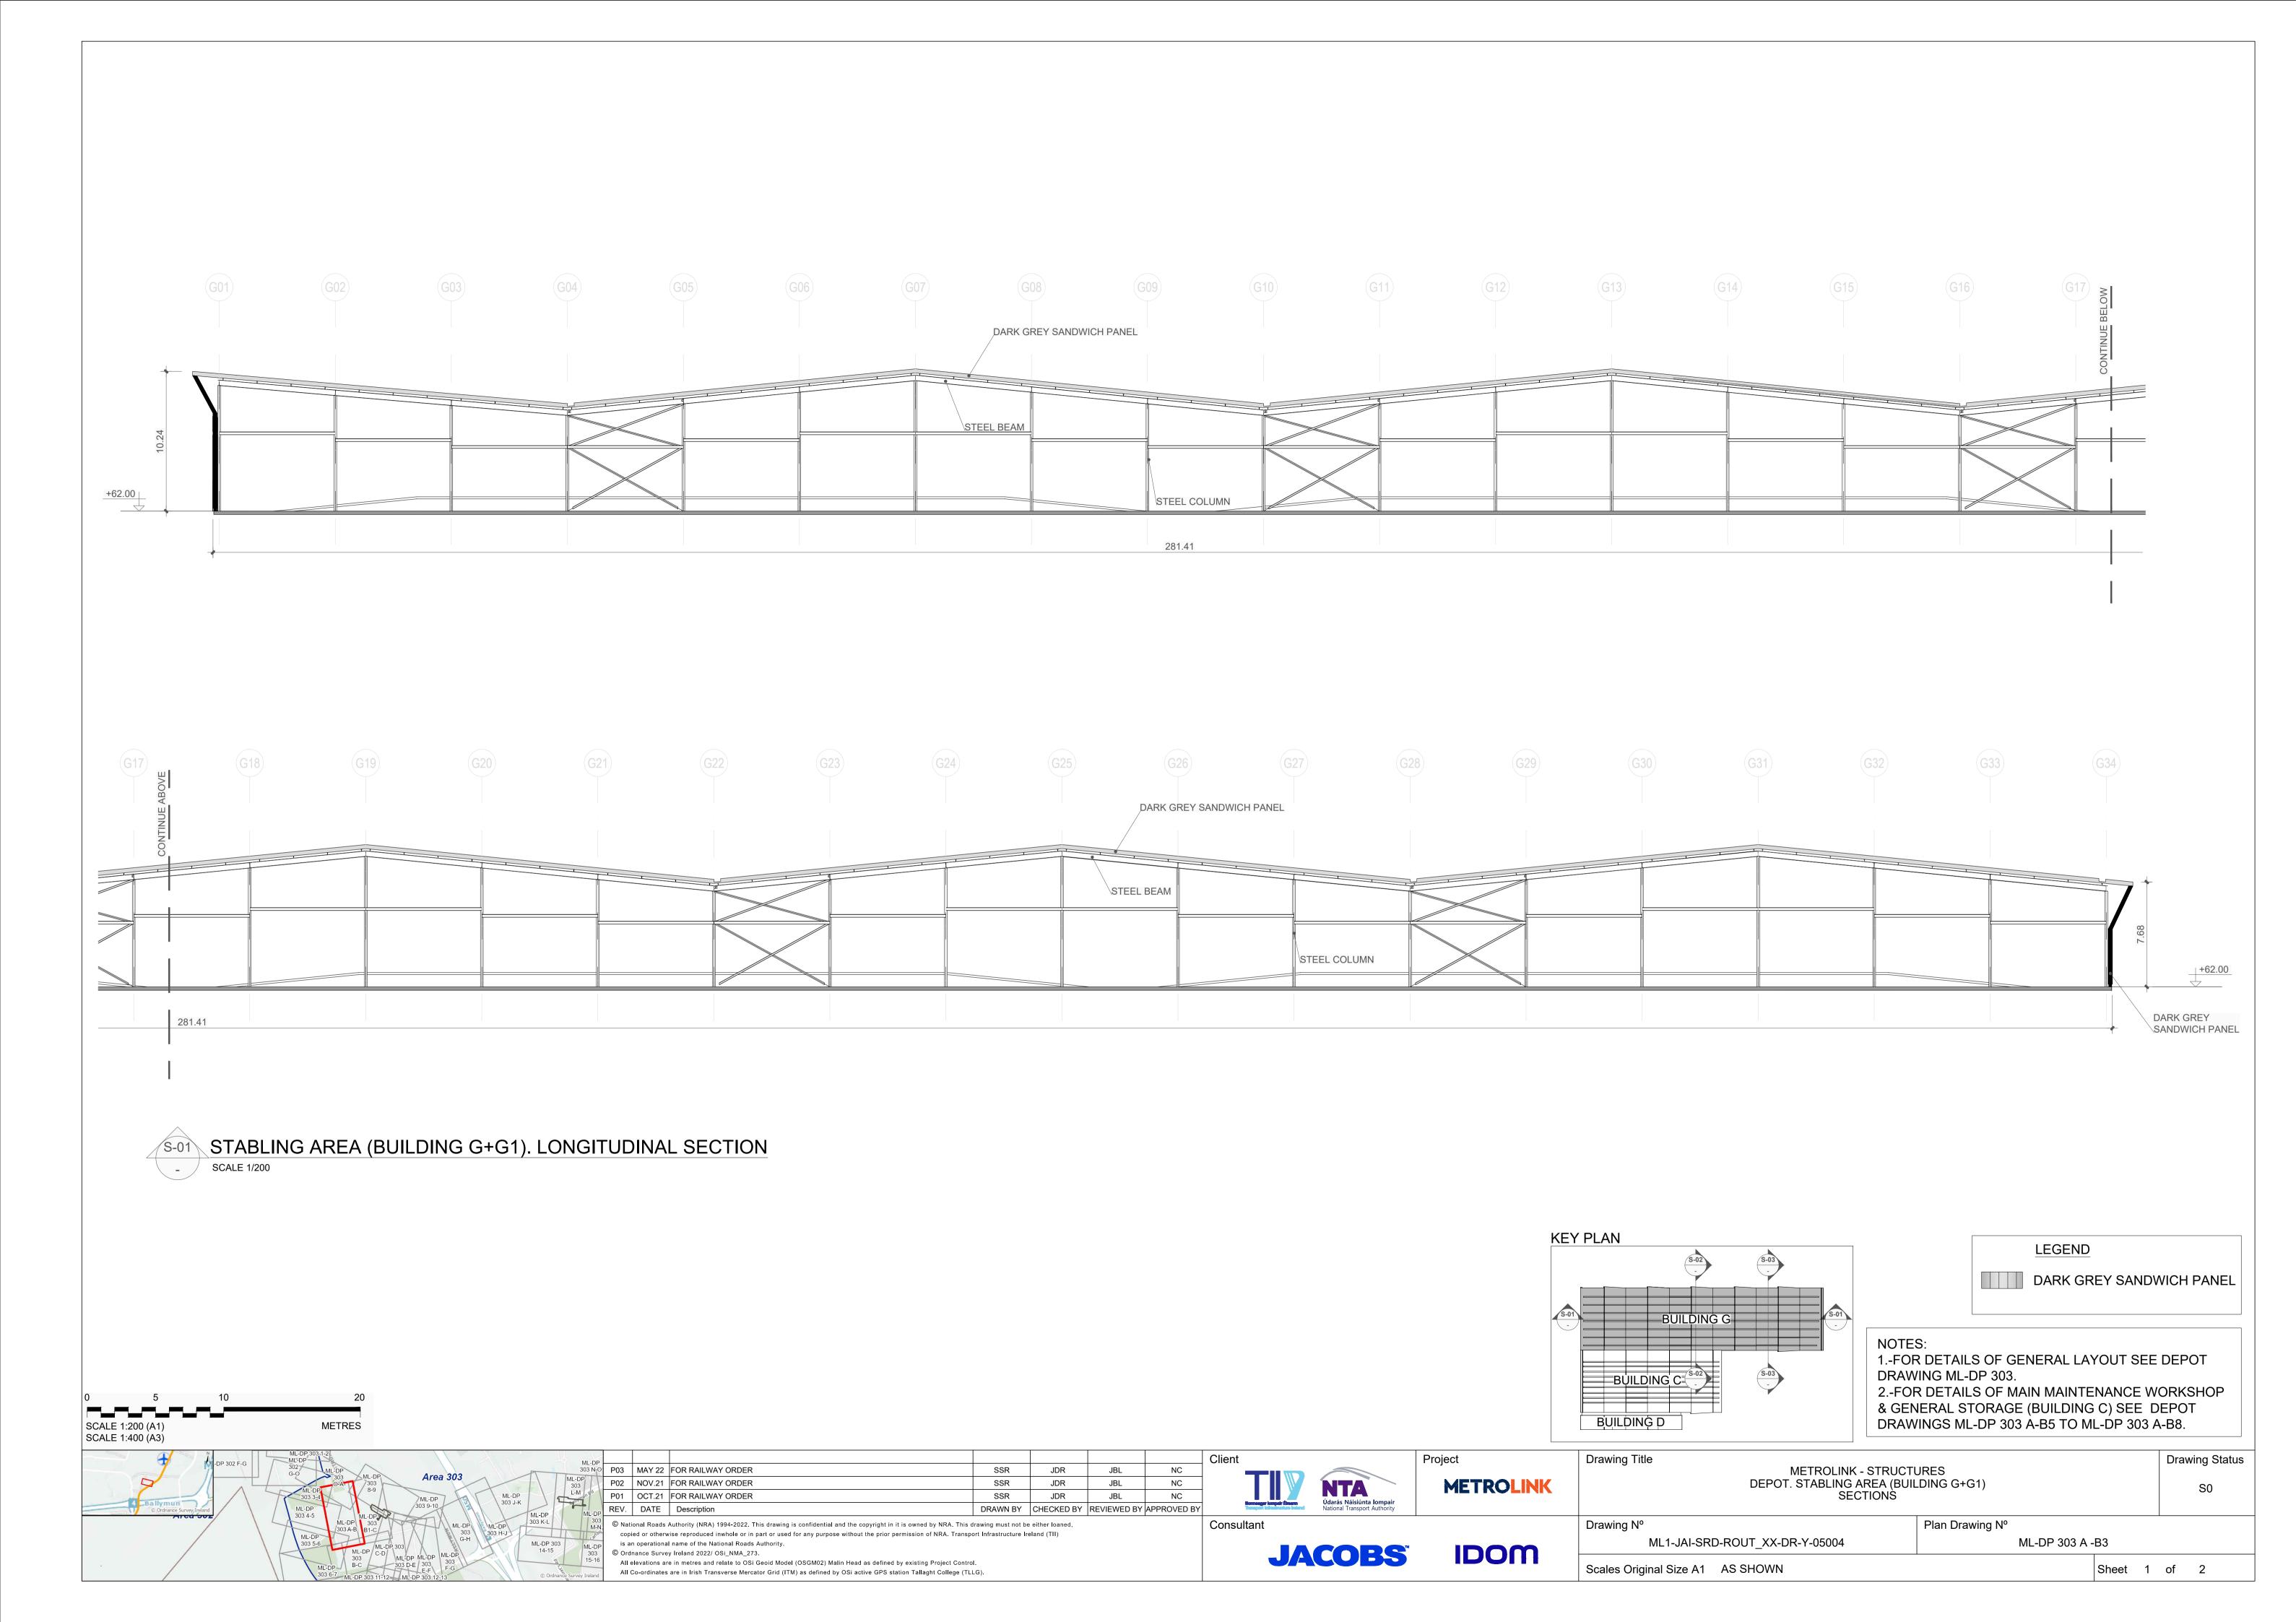

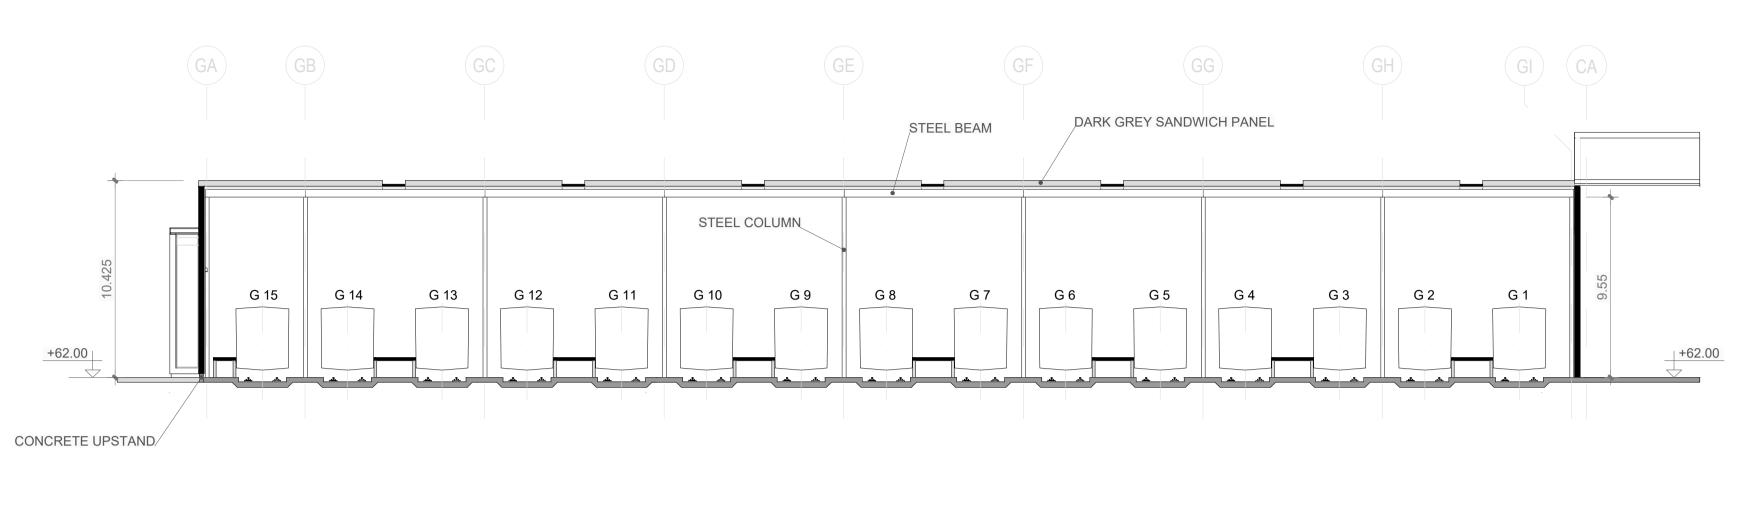

S-02 STABLING AREA (BUILDING G+G1). CROSS SECTION

SCALE 1/200

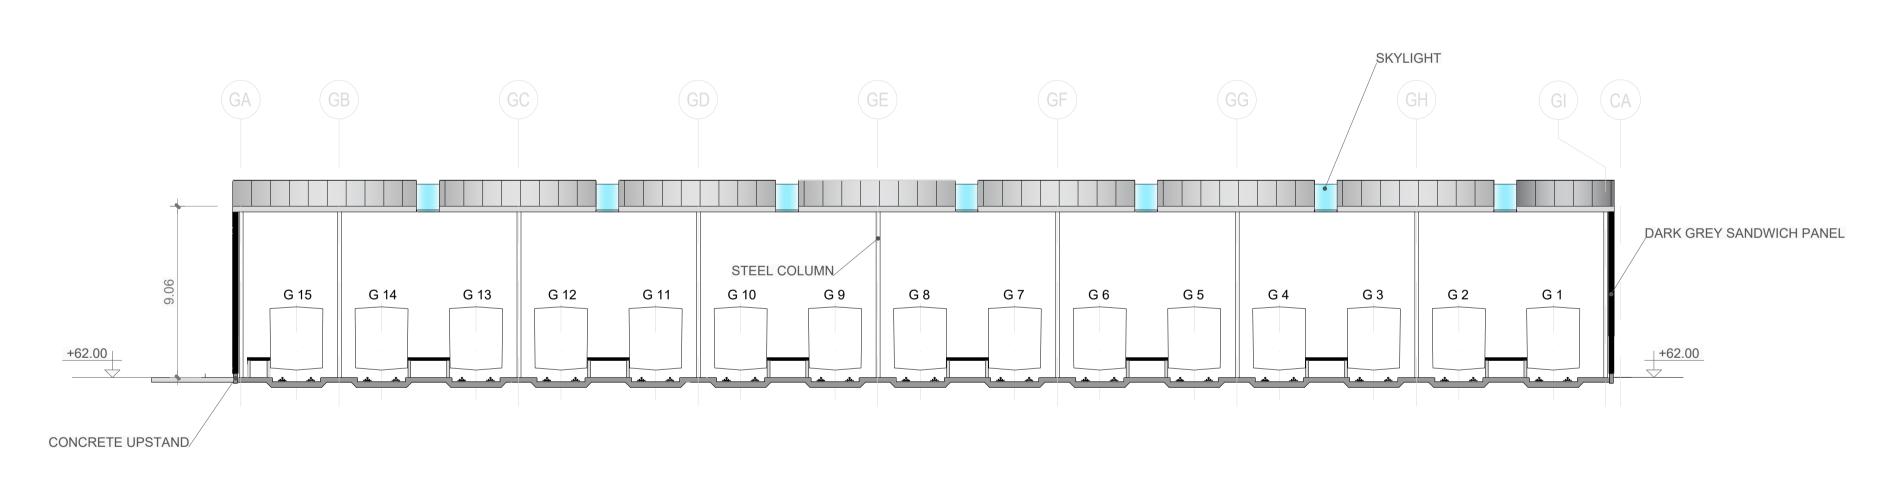

KEY PLAN


LEGEND


DARK GREY SANDWICH PANEL

S-03 STABLING AREA (BUILDING G+G1). CROSS SECTION

SCALE 1/200



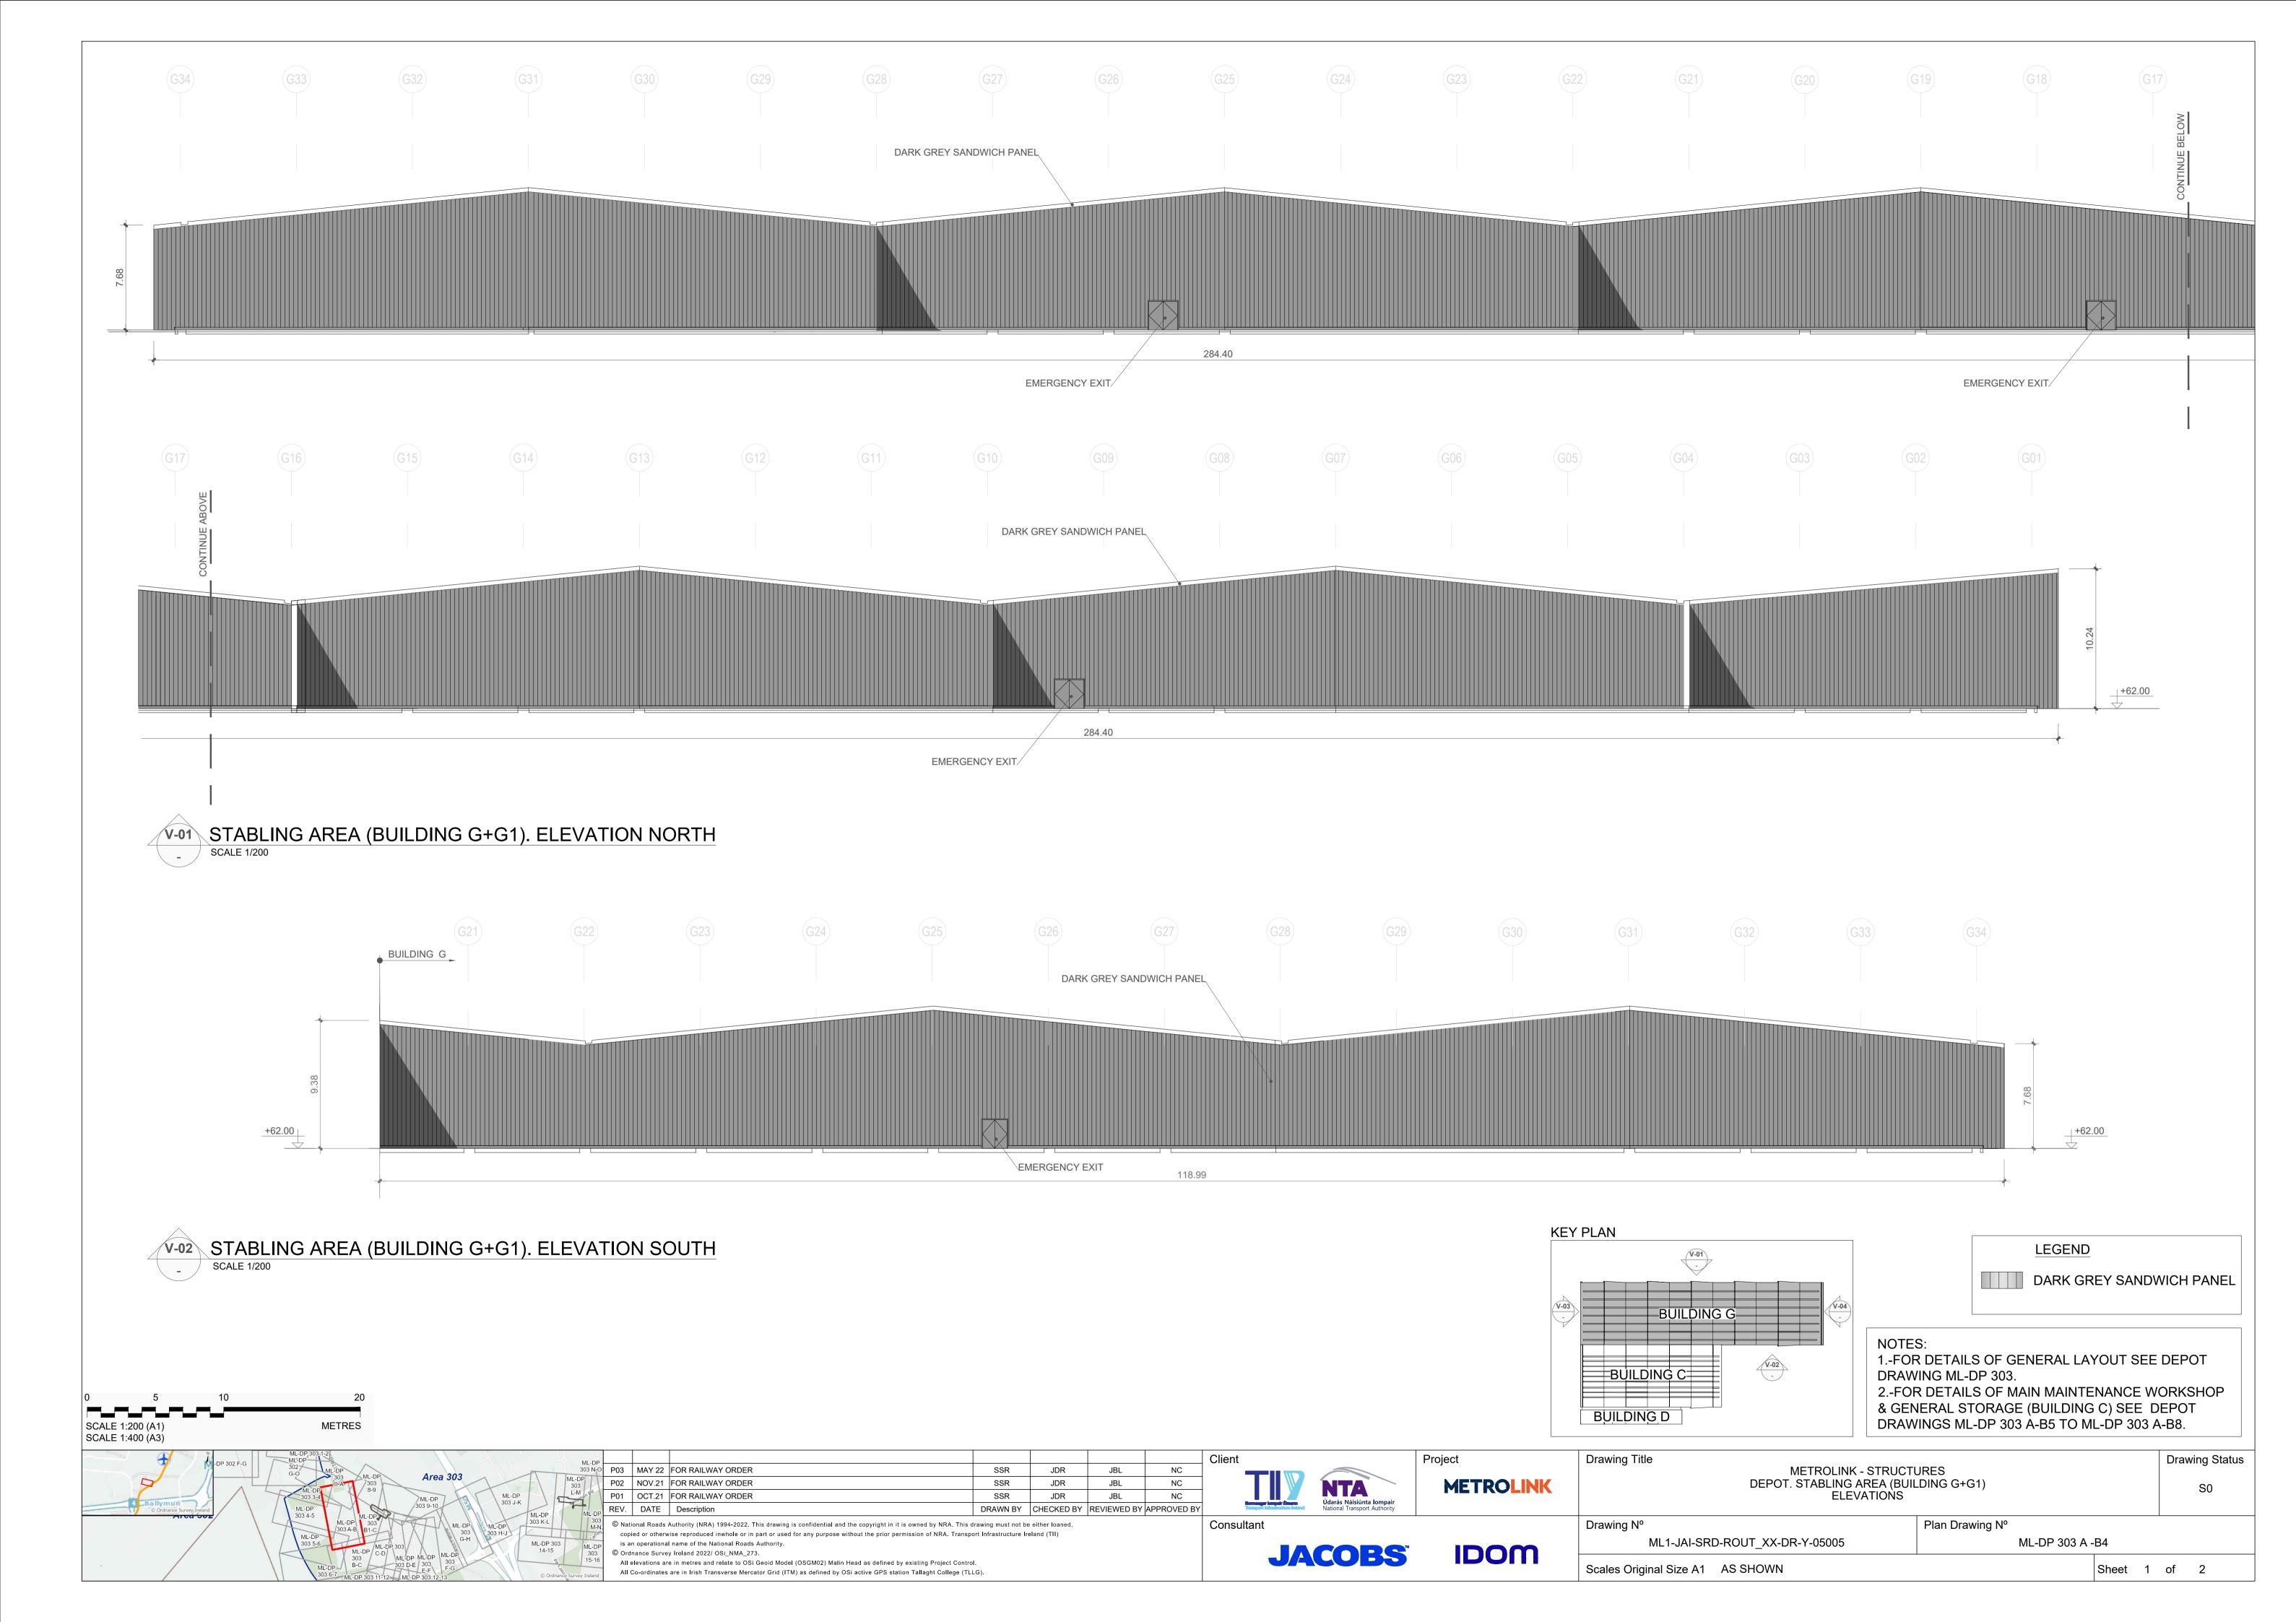

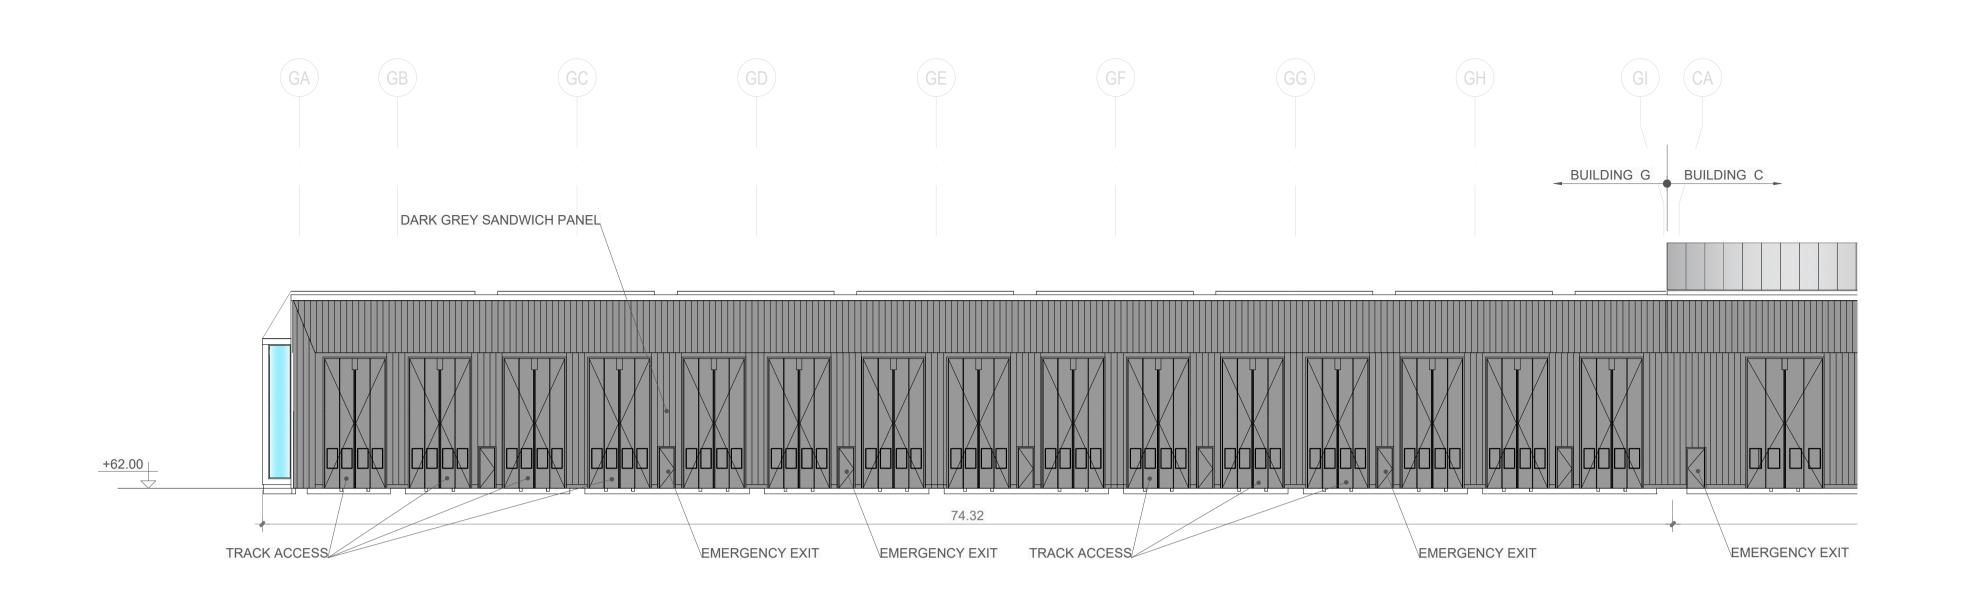

V-03 STABLING AREA (BUILDING G+G1). ELEVATION WEST


SCALE 1/200

is an operational name of the National Roads Authority.

All elevations are in metres and relate to OSi Geoid Model (OSGM02) Malin Head as defined by existing Project Control.

All Co-ordinates are in Irish Transverse Mercator Grid (ITM) as defined by OSi active GPS station Tallaght College (TLLG).

SCALE 1:200 (A1) SCALE 1:400 (A3)

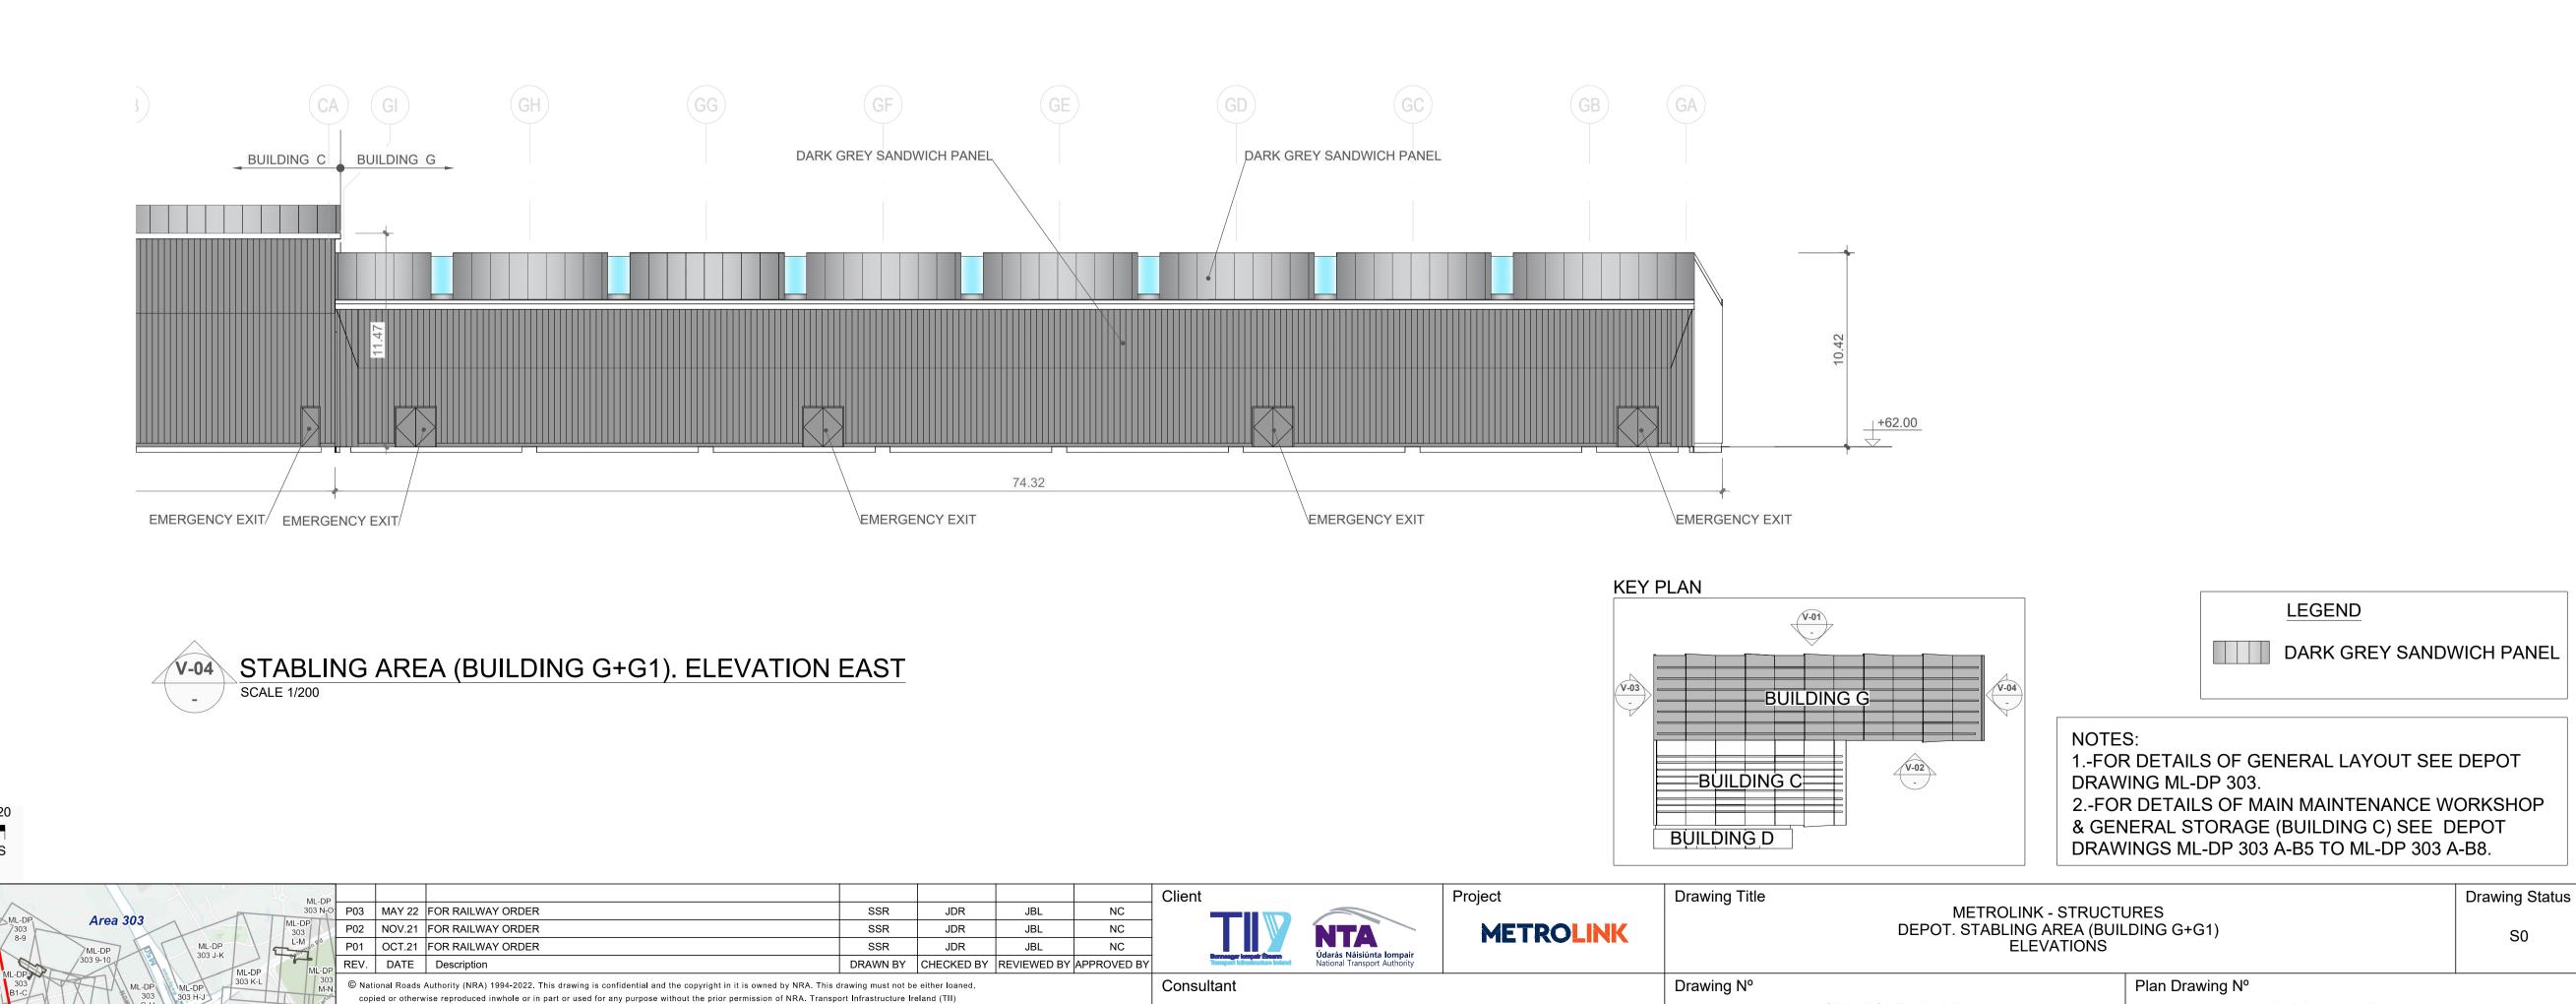

JACOBS


IDOM


ML1-JAI-SRD-ROUT_XX-DR-Y-05005


Scales Original Size A1 AS SHOWN


ML-DP 303 A -B4

Sheet 2 of 2

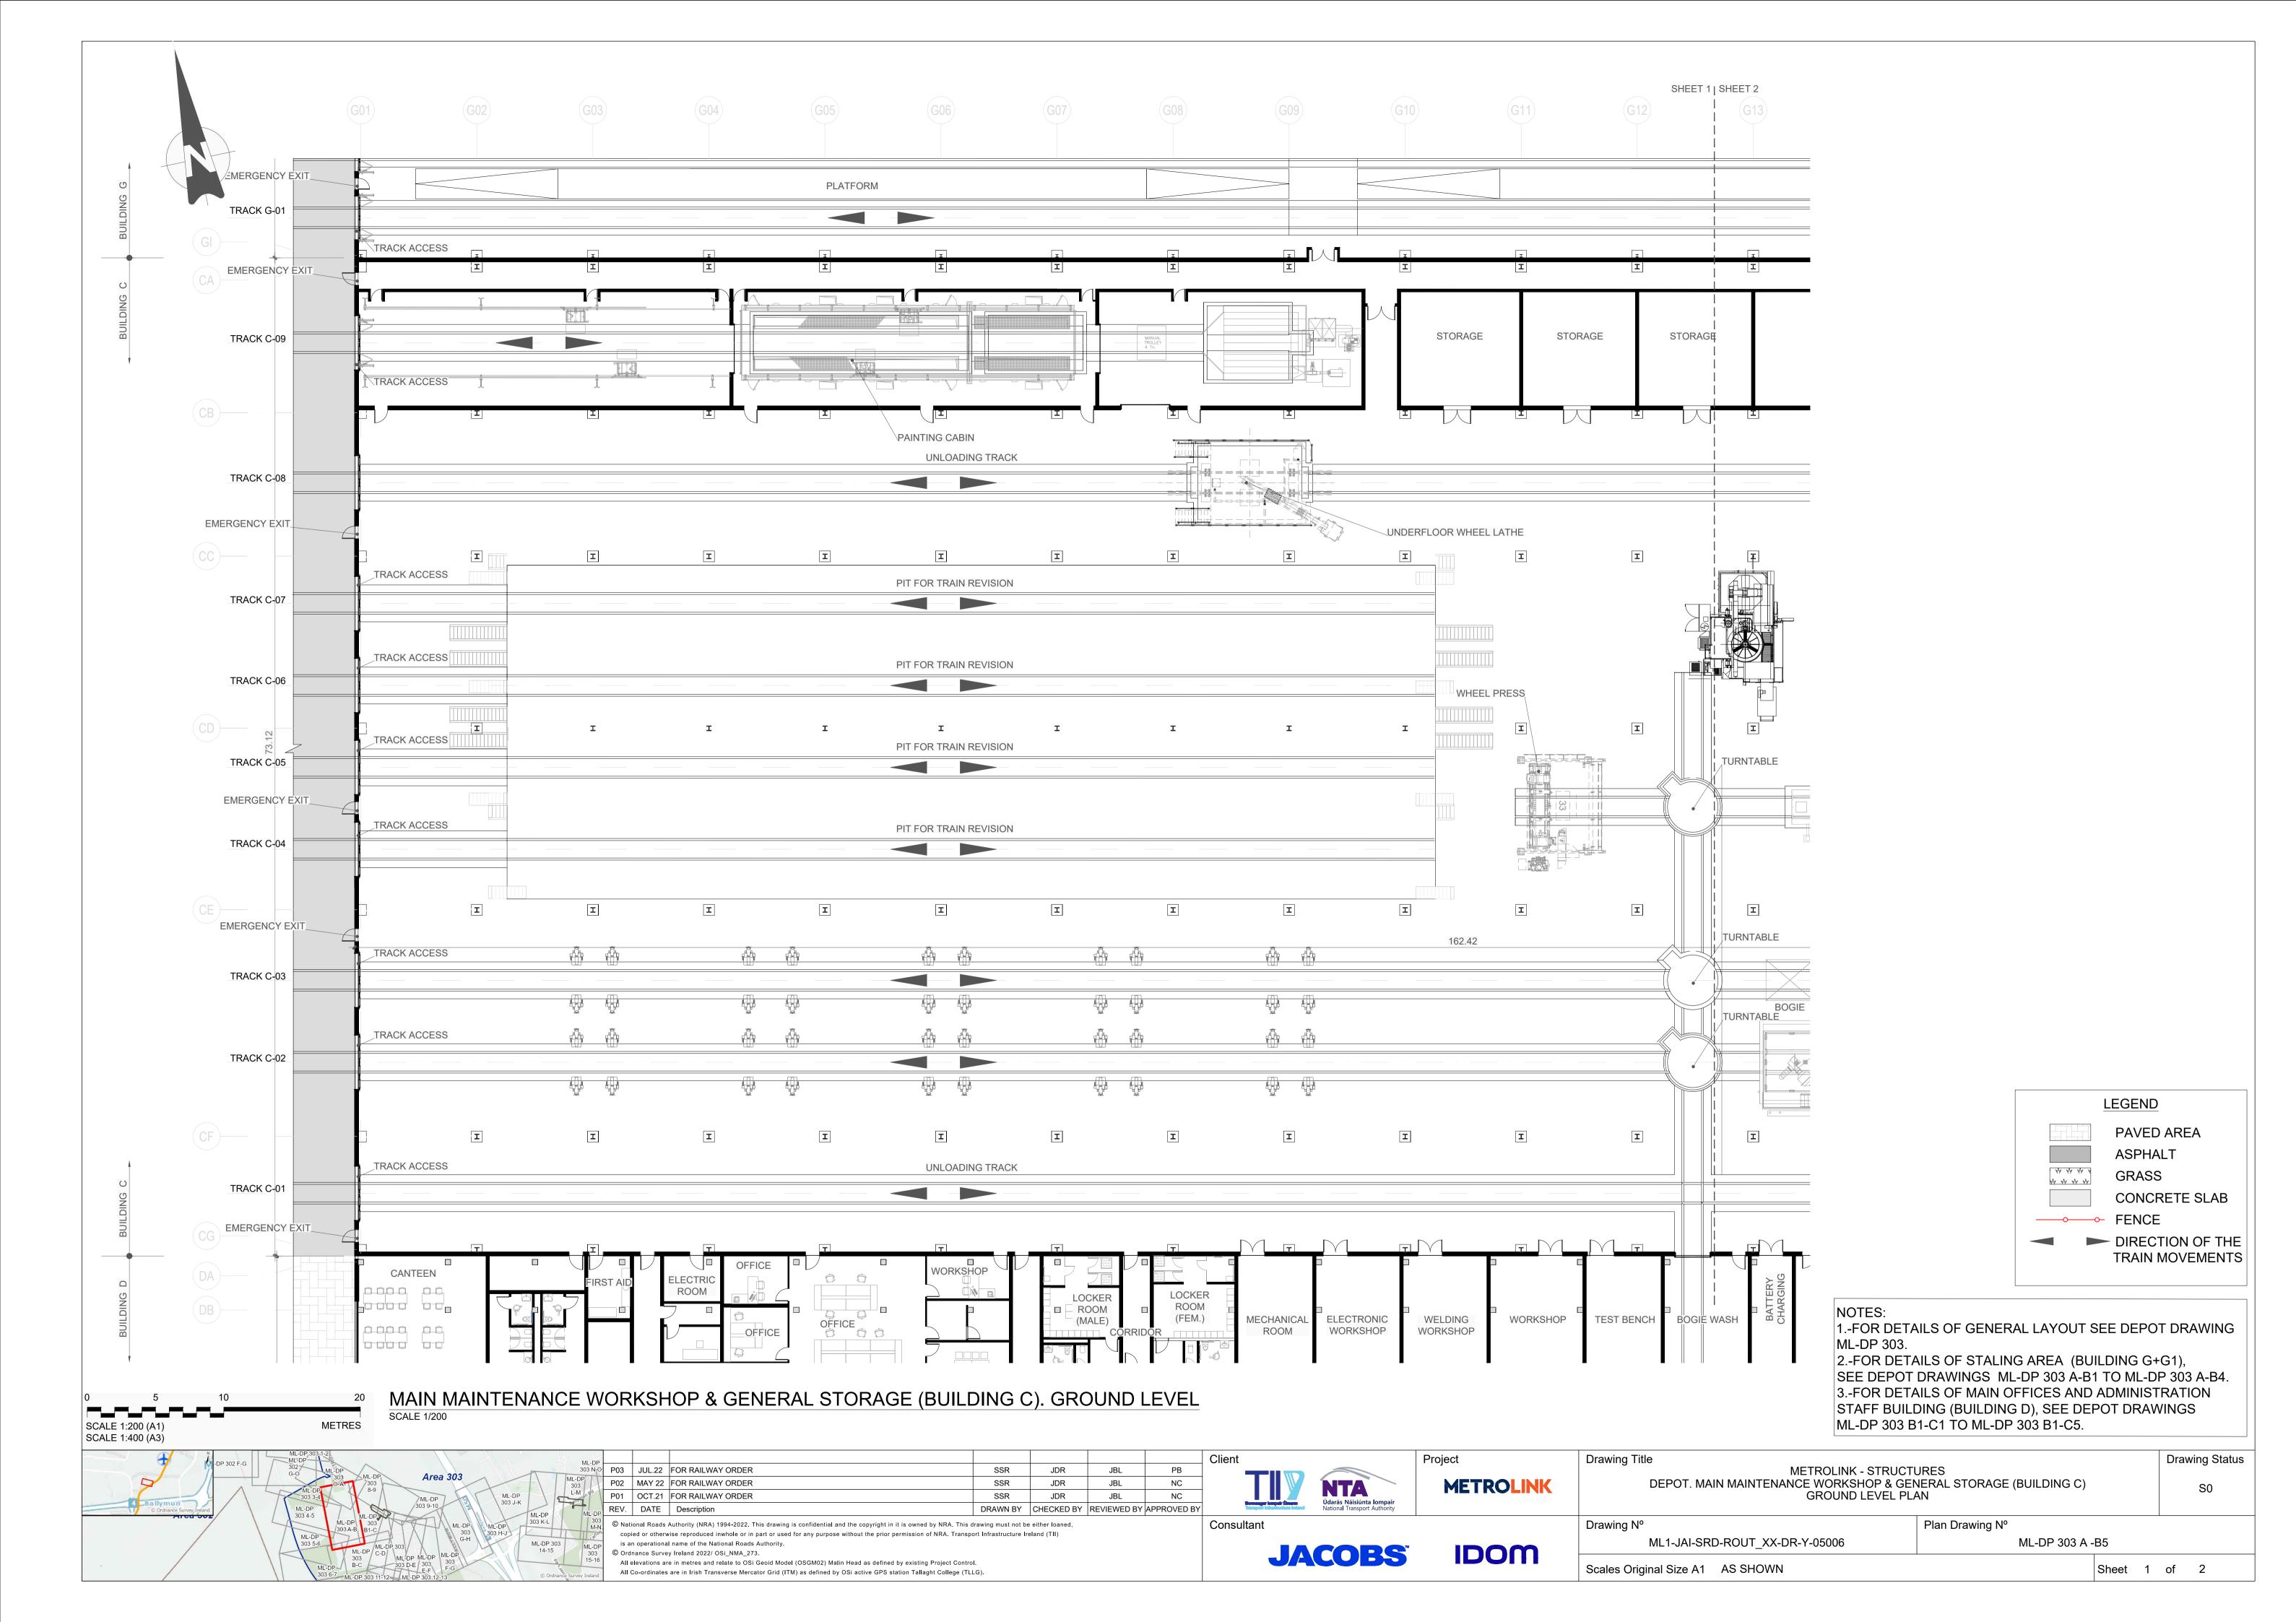


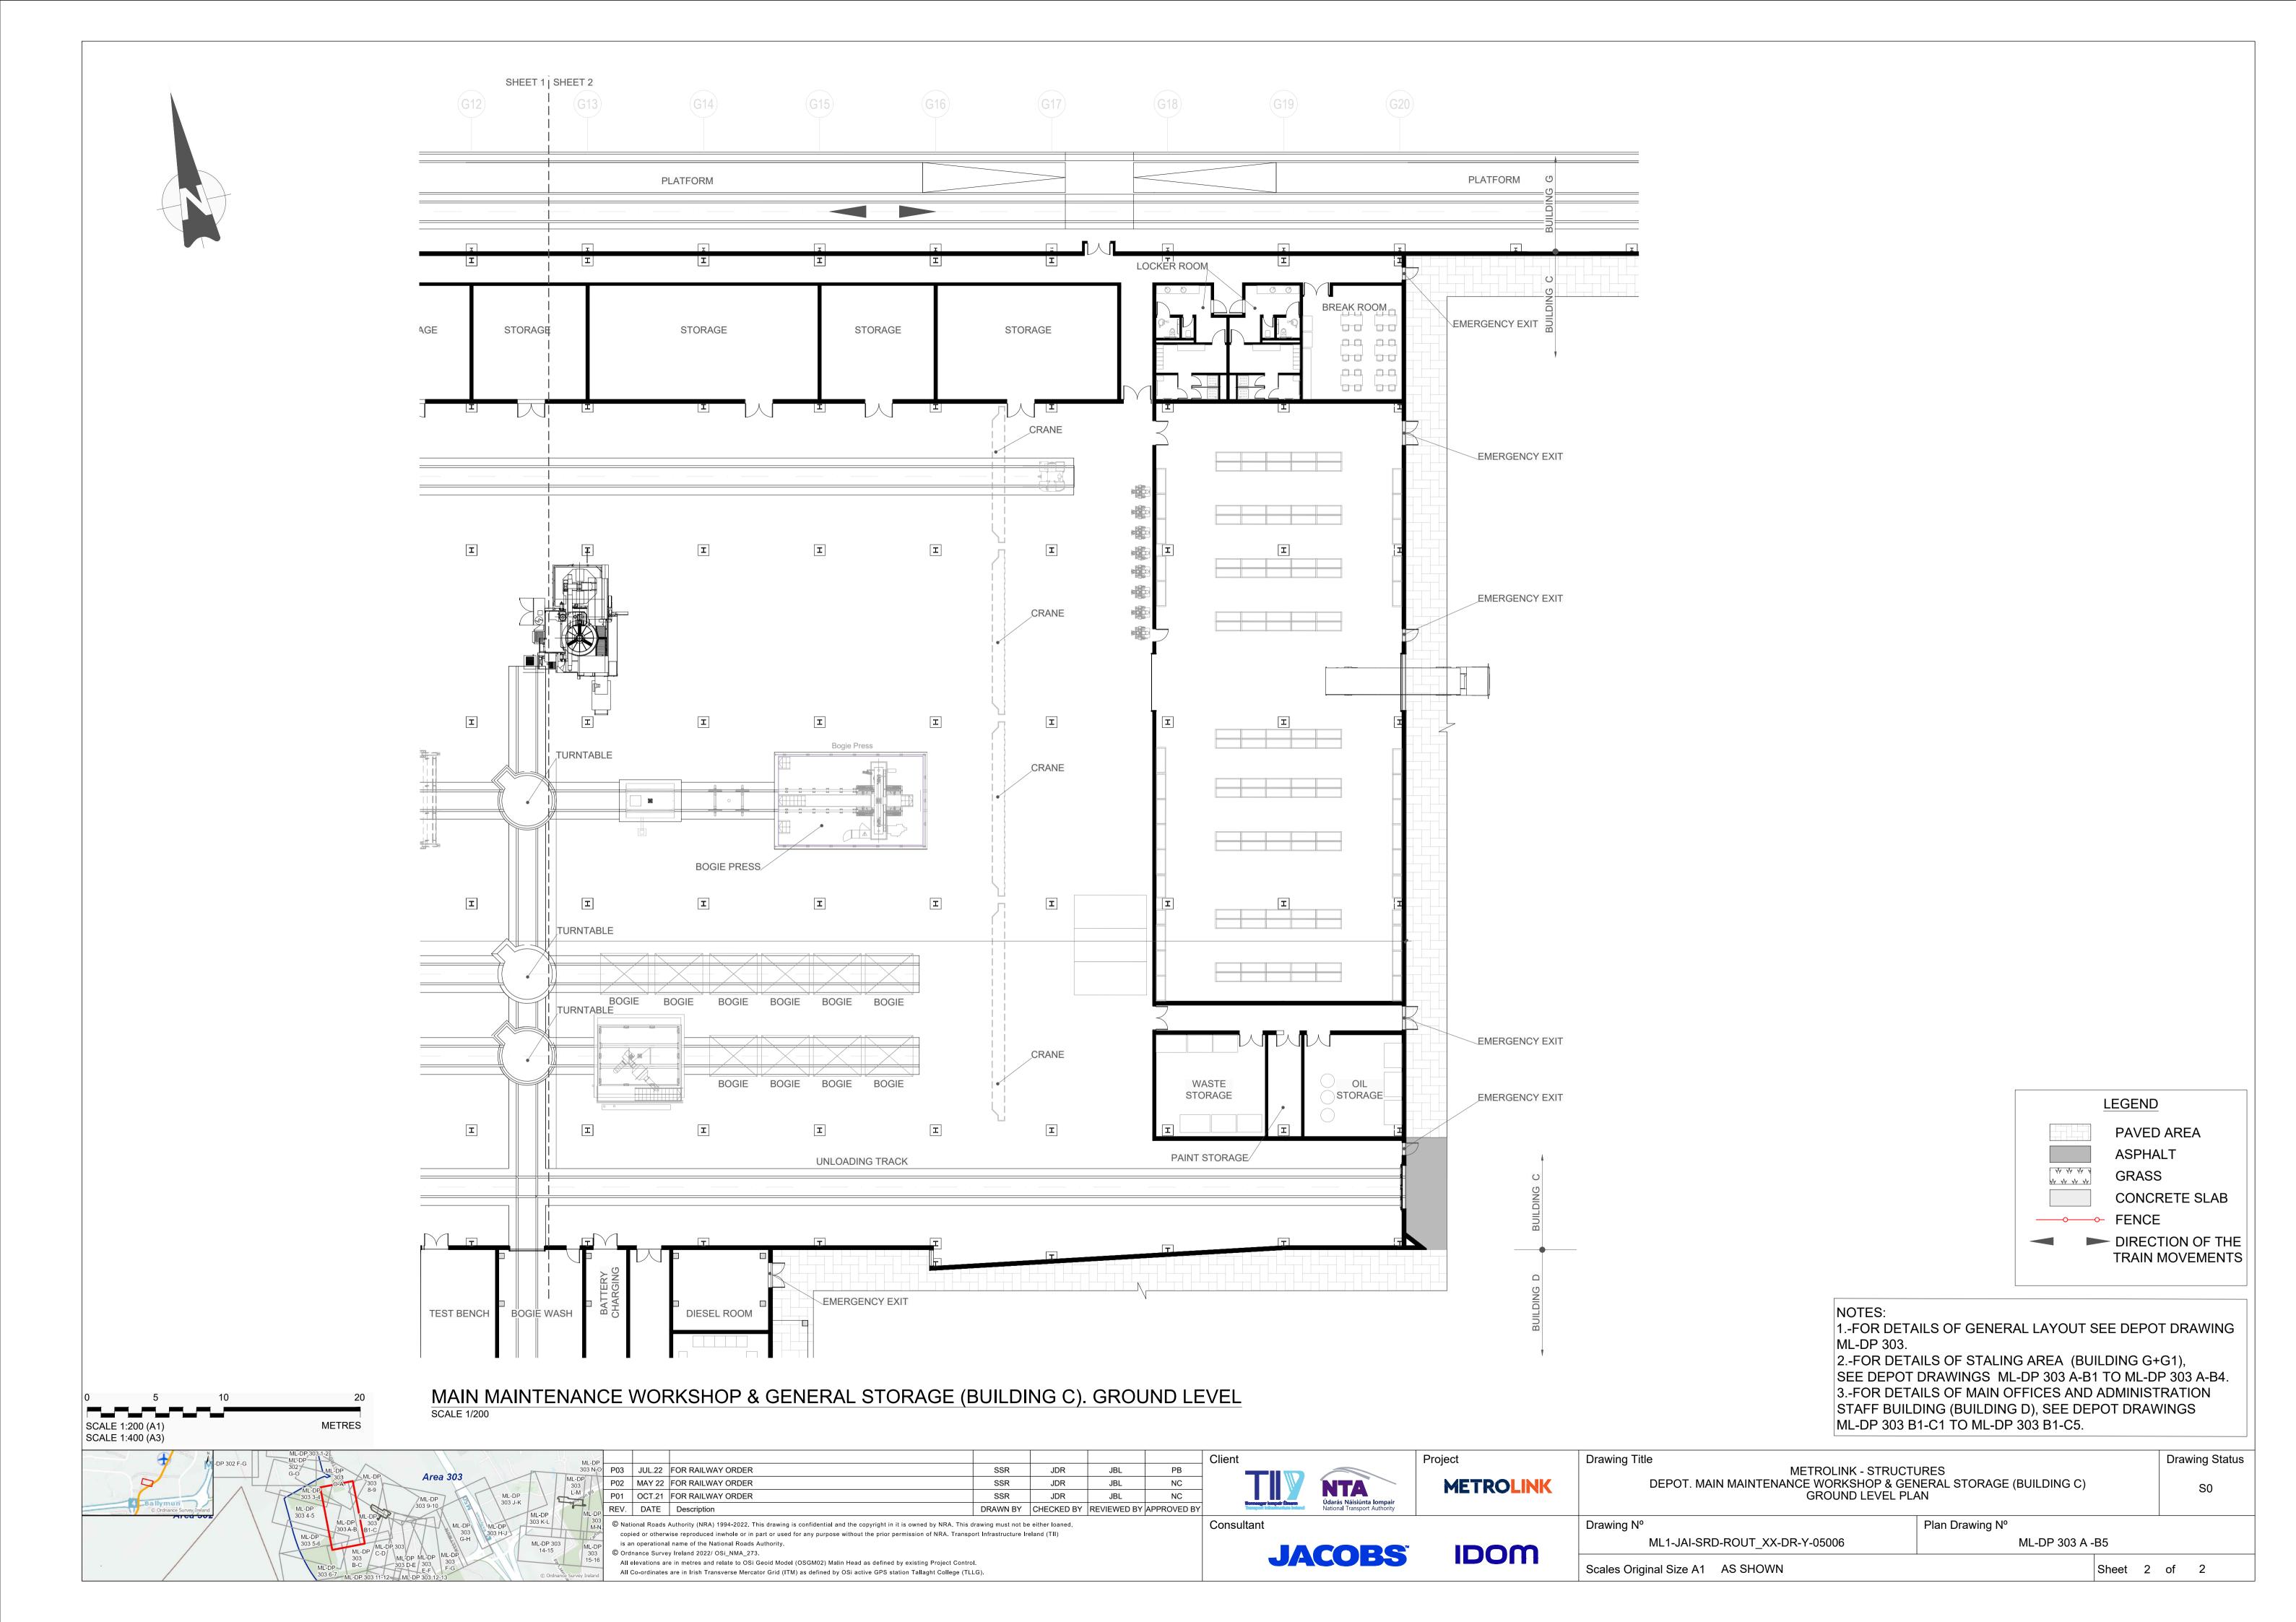

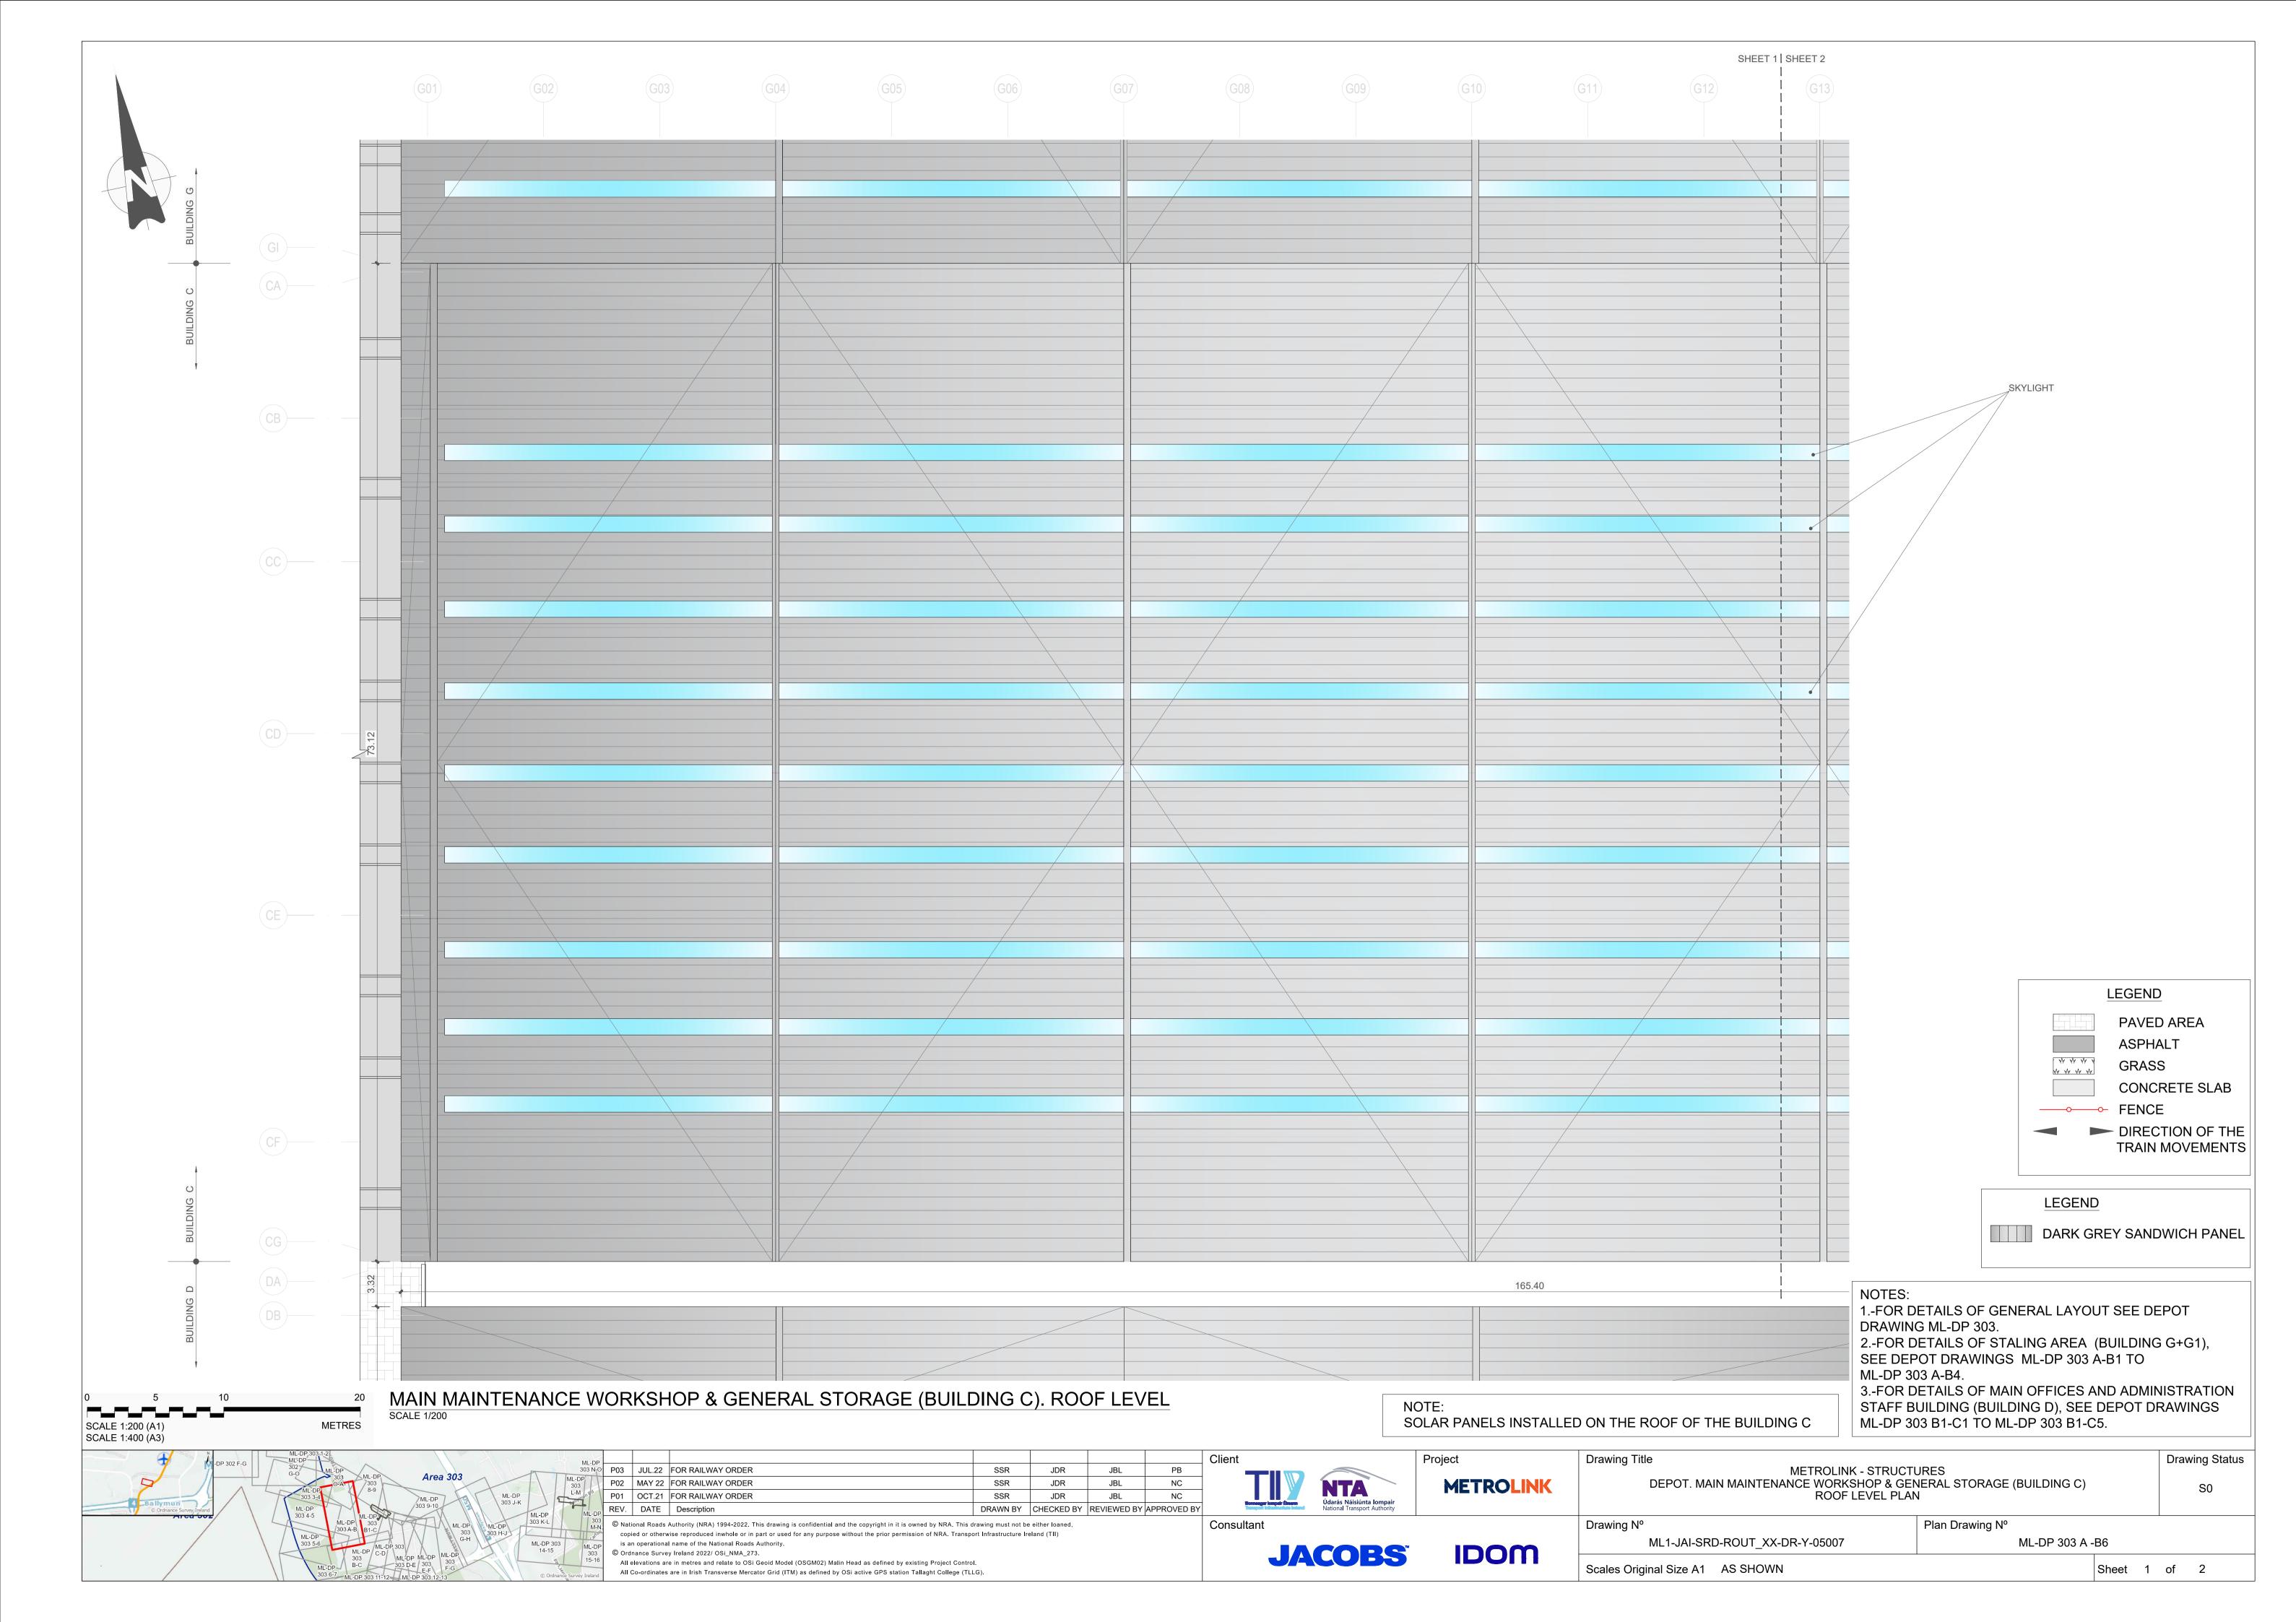

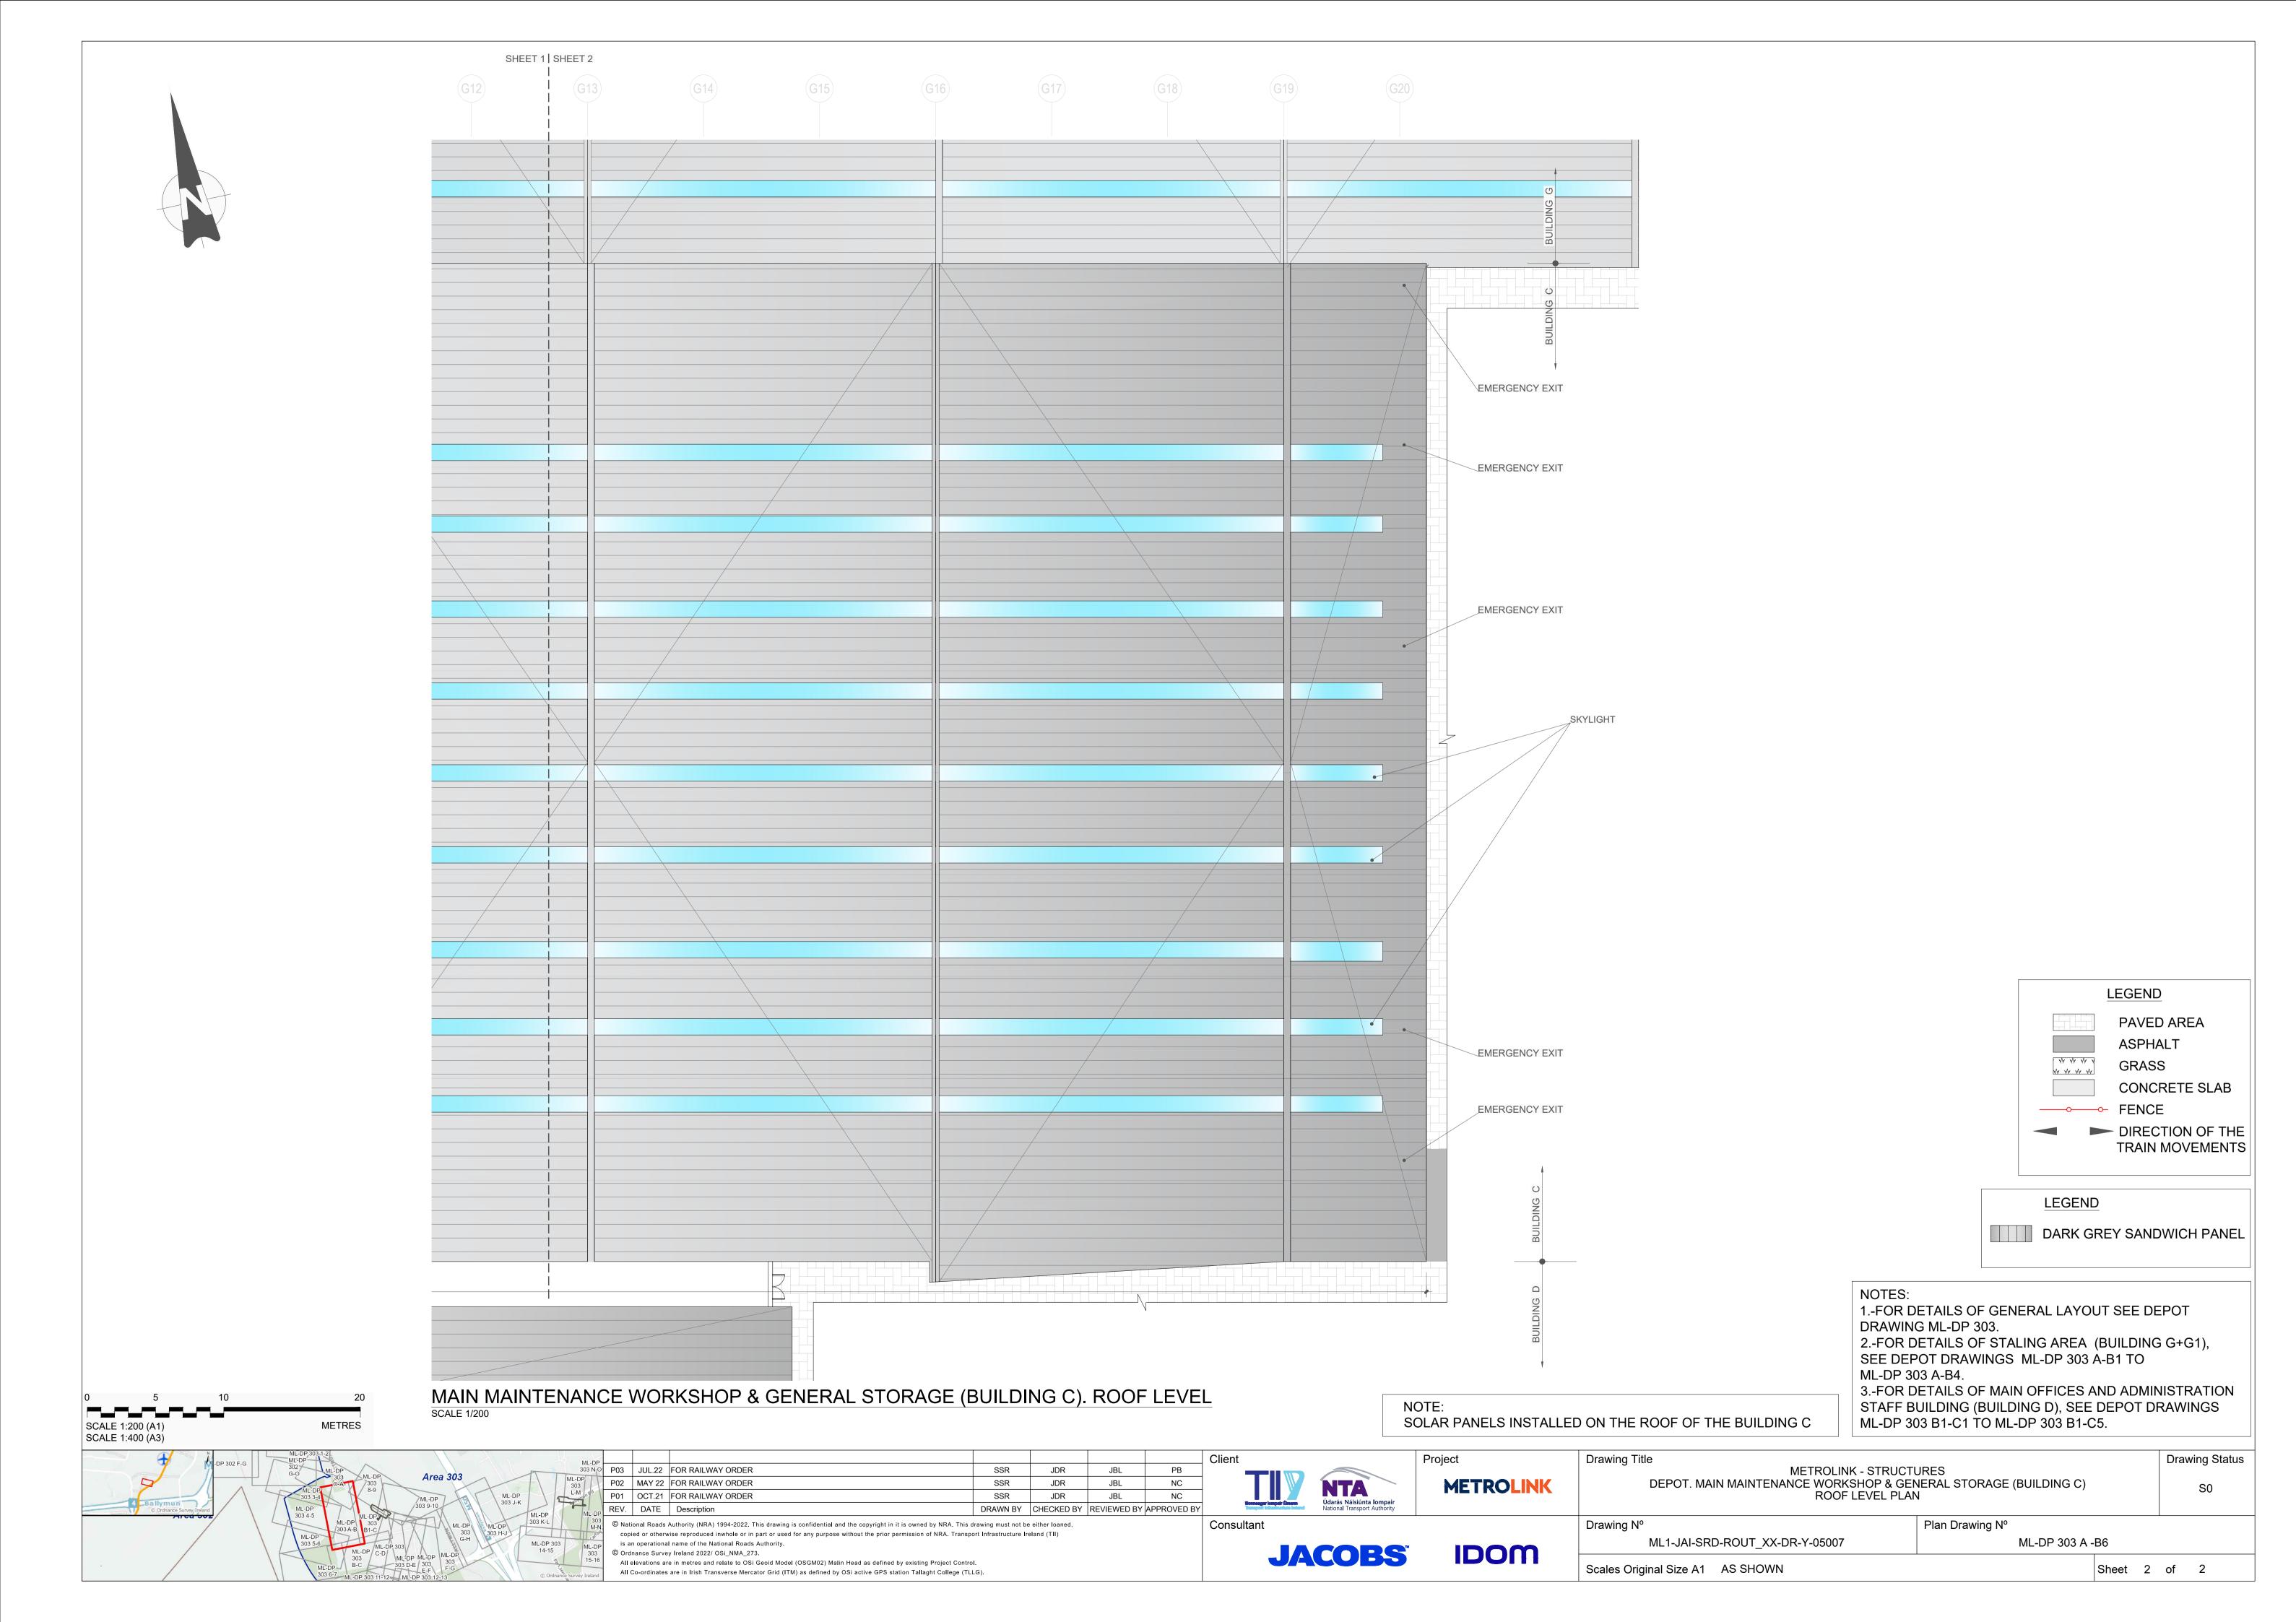




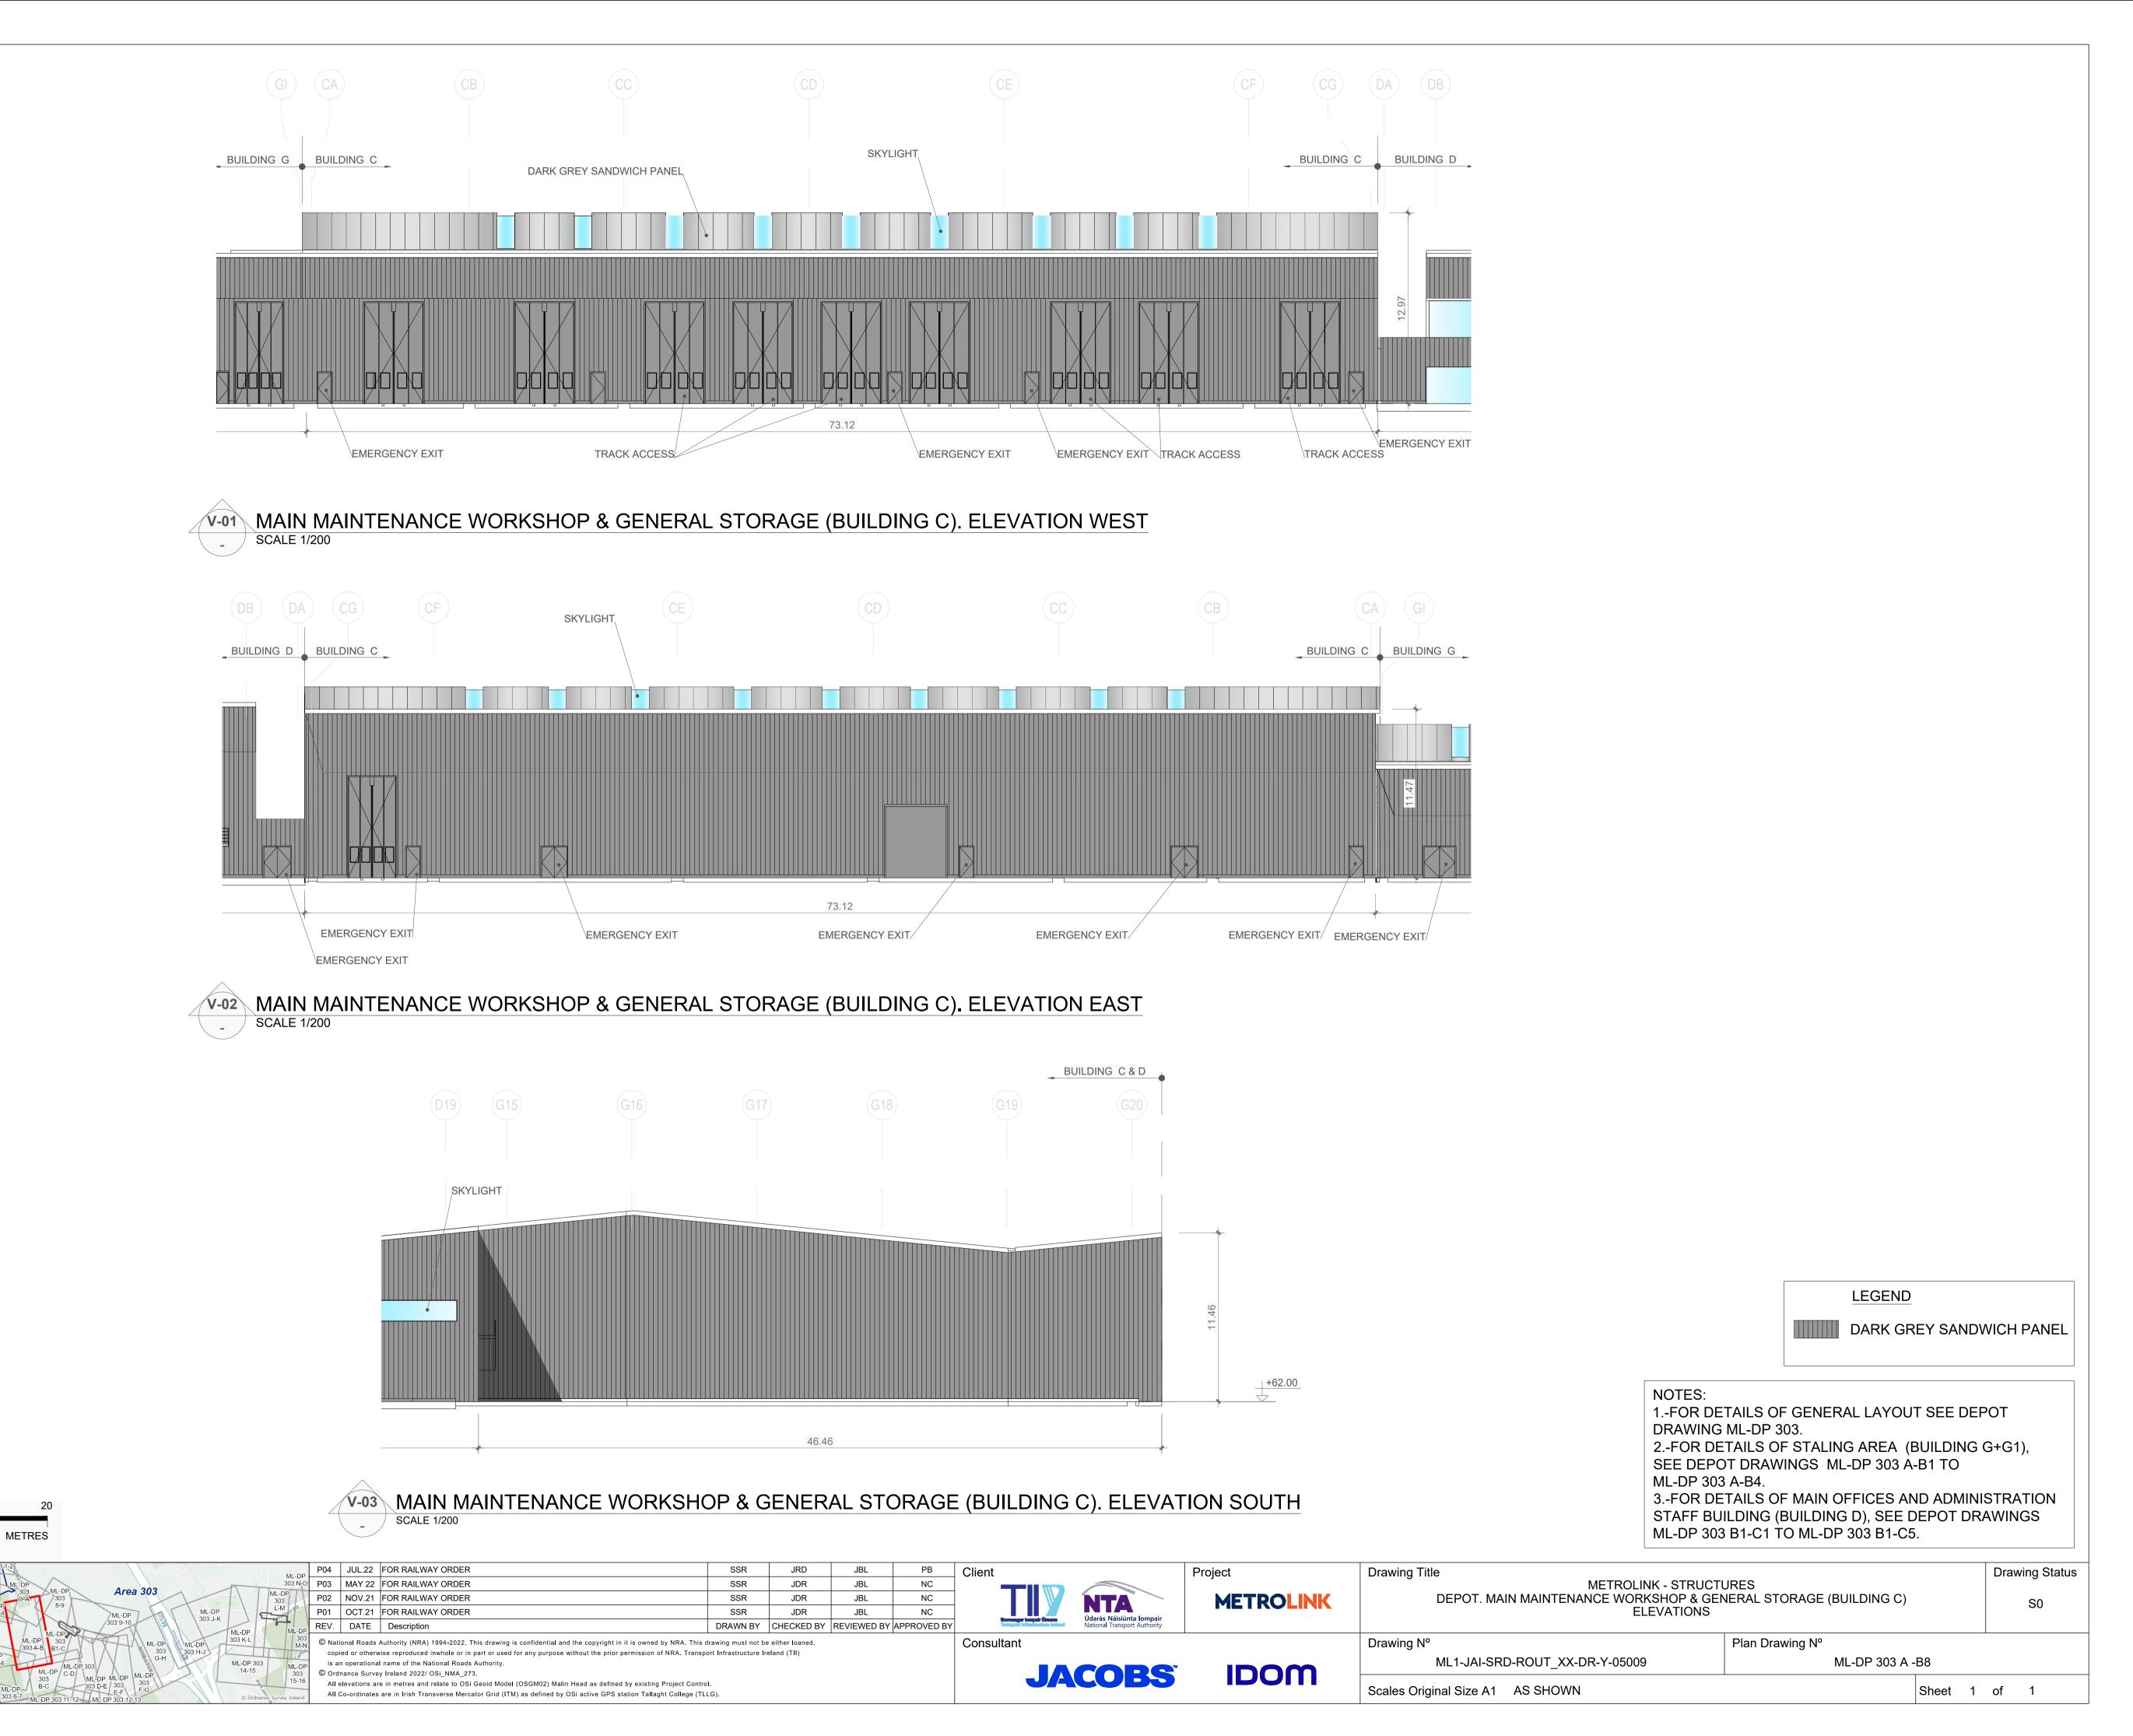


SCALE 1:200 (A1) SCALE 1:400 (A3)



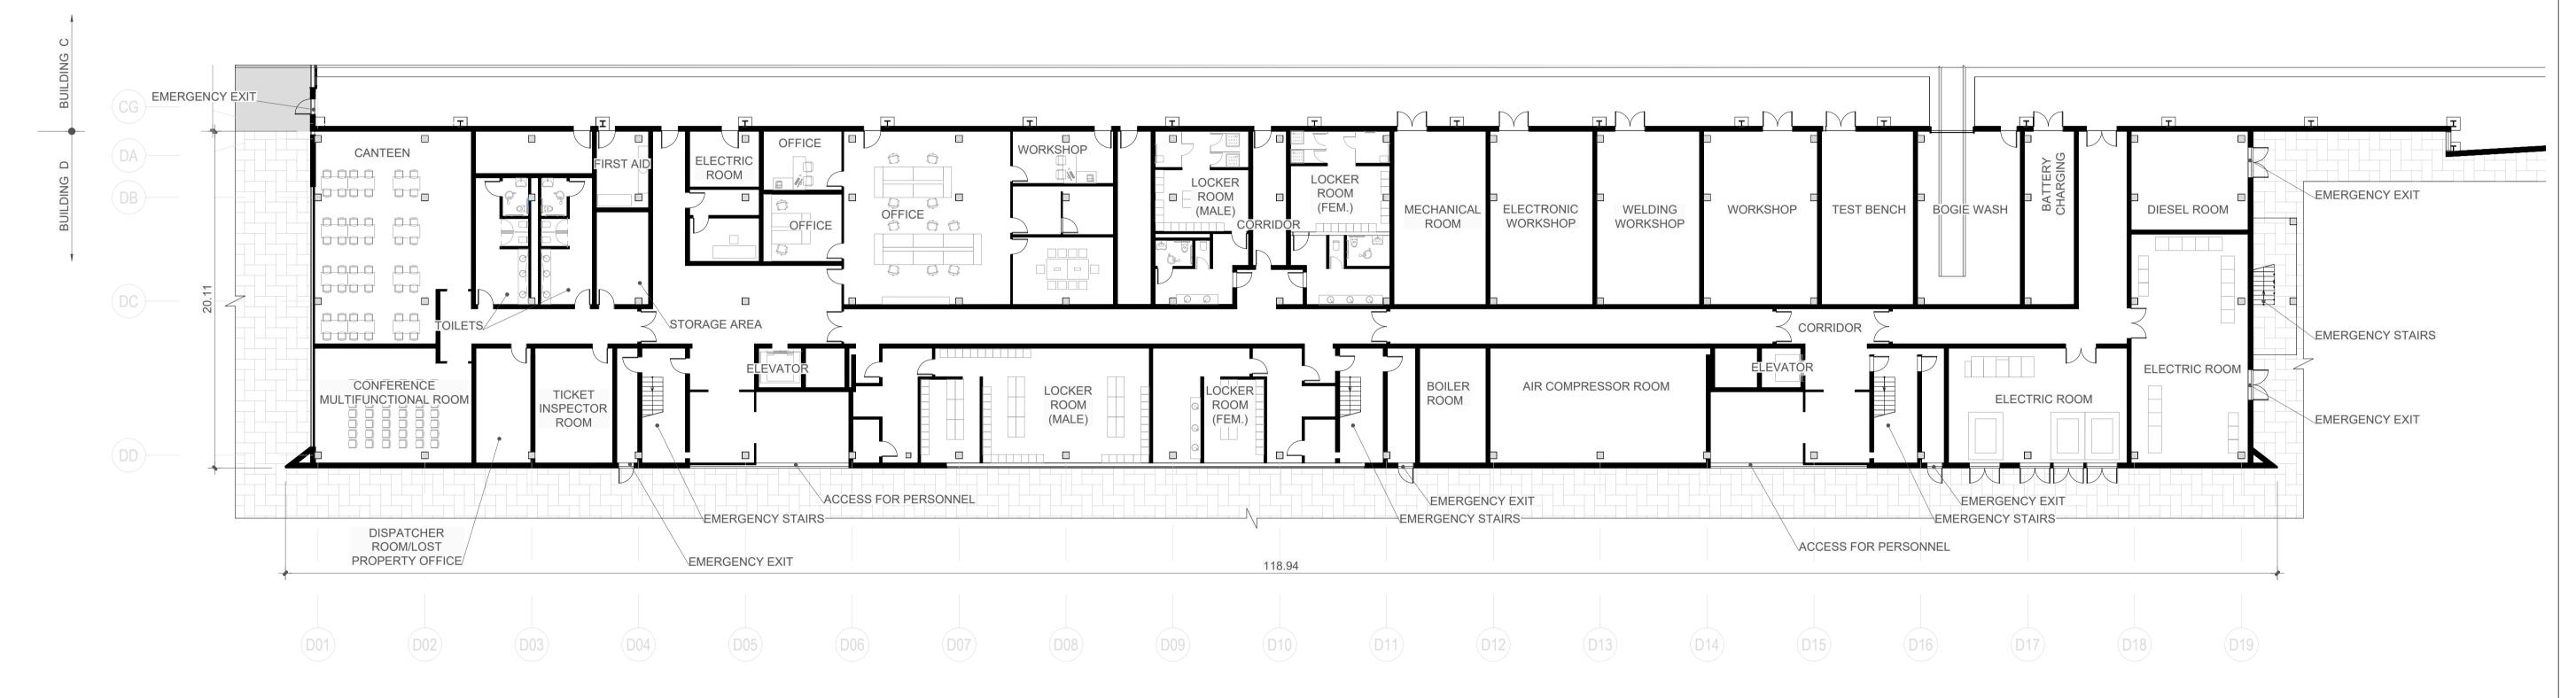

MAIN OFFICES AND ADMINISTRATION/STAFF BUILDING (BUILDING D). GROUND LEVEL

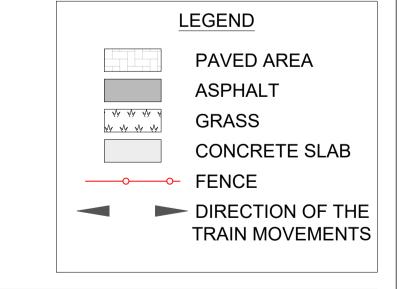

1.-FOR DETAILS OF GENERAL LAYOUT SEE DEPOT DRAWING ML-DP 303.

2.-FOR DETAILS OF MAIN MAINTENANCE WORKSHOP & GENERAL STORAGE (BUILDING C), SEE DEPOT

ML-DP 303 B1-C1

Sheet 1 of 1

DRAWINGS ML-DP A-B5 TO ML-DP A-B8.

Drawing Title

ML1-JAI-SRD-ROUT_XX-DR-Y-05010

Scales Original Size A1 AS SHOWN

Drawing Status METROLINK - STRUCTURES DEPOT. MAIN OFFICES AND ADMINISTRATION STAFF BUILDING (BUILDING D) GROUND LEVEL PLAN Plan Drawing N⁰ Drawing N⁰

SCALE 1:200 (A1) SCALE 1:400 (A3)

P03 JUL.22 FOR RAILWAY ORDER PB P02 MAY 22 FOR RAILWAY ORDER SSR JDR NC JBL P01 OCT.21 FOR RAILWAY ORDER SSR DRAWN BY CHECKED BY REVIEWED BY APPROVED BY

All Co-ordinates are in Irish Transverse Mercator Grid (ITM) as defined by OSi active GPS station Tallaght College (TLLG).

copied or otherwise reproduced inwhole or in part or used for any purpose without the prior permission of NRA. Transport Infrastructure Ireland (TII) is an operational name of the National Roads Authority. © Ordnance Survey Ireland 2022/ OSi_NMA_273. All elevations are in metres and relate to OSi Geoid Model (OSGM02) Malin Head as defined by existing Project Control.


JACOBS

NTA


IDOM

METROLINK




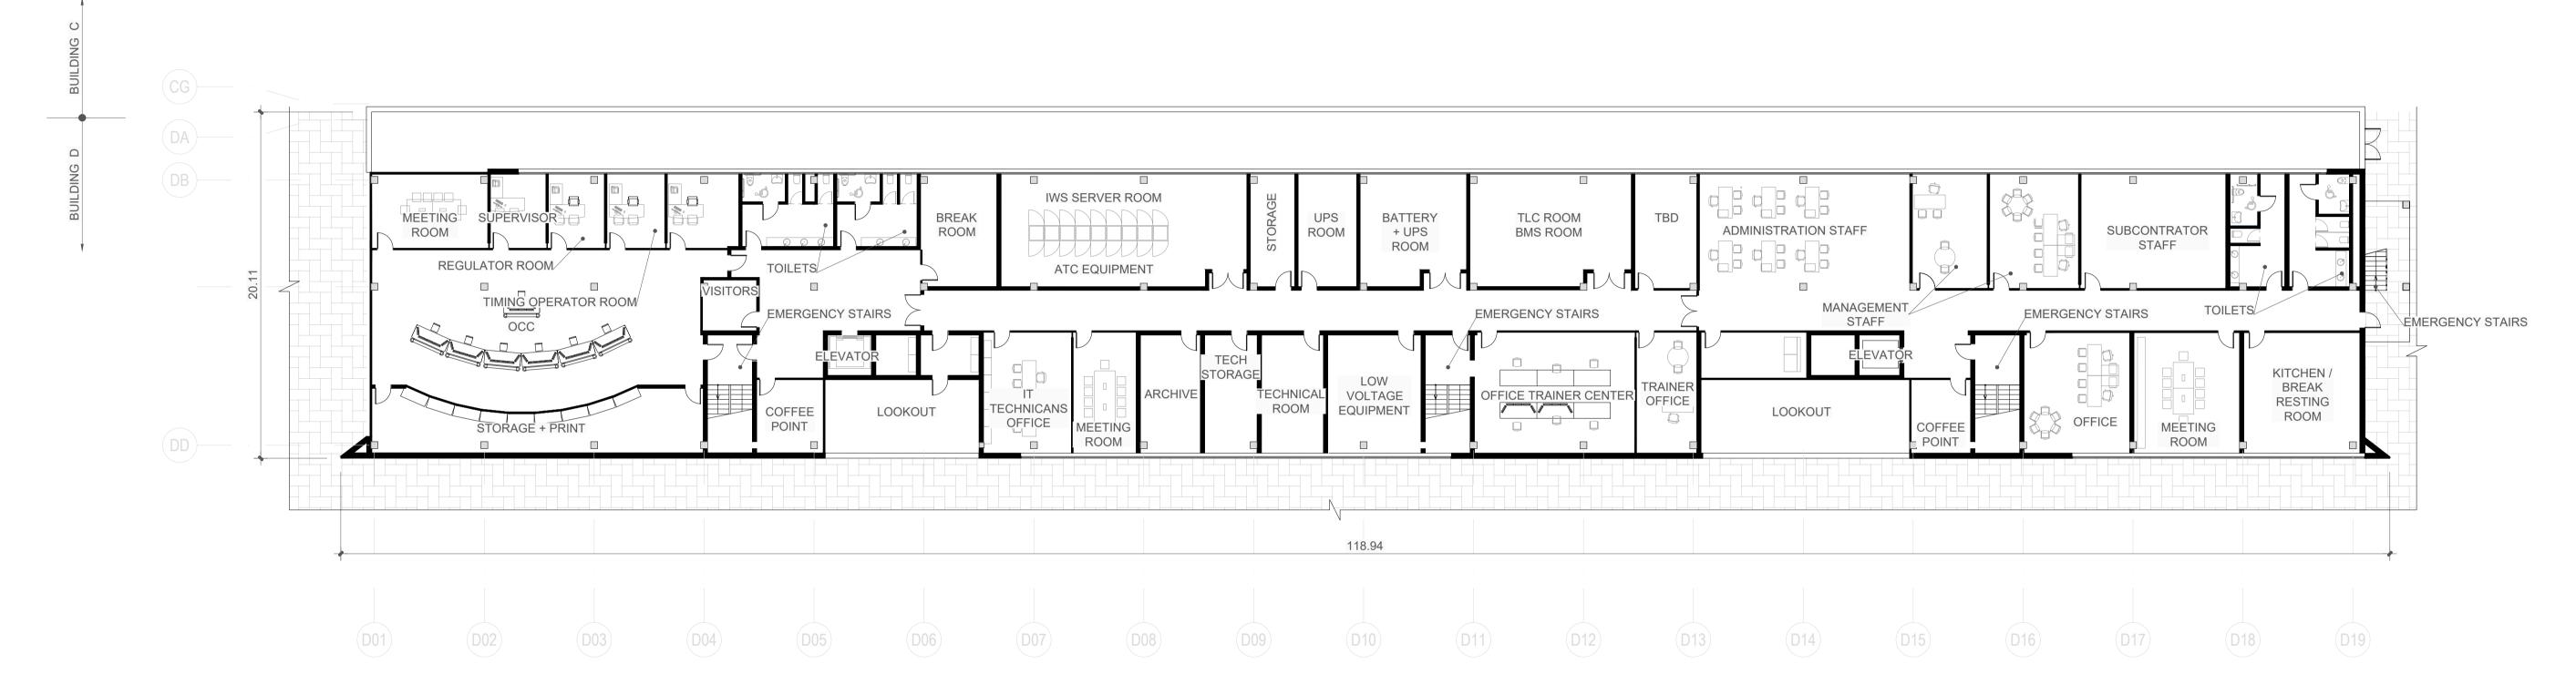


MAIN OFFICES AND ADMINISTRATION STAFF BUILDING (BUILDING D). FIRST LEVEL

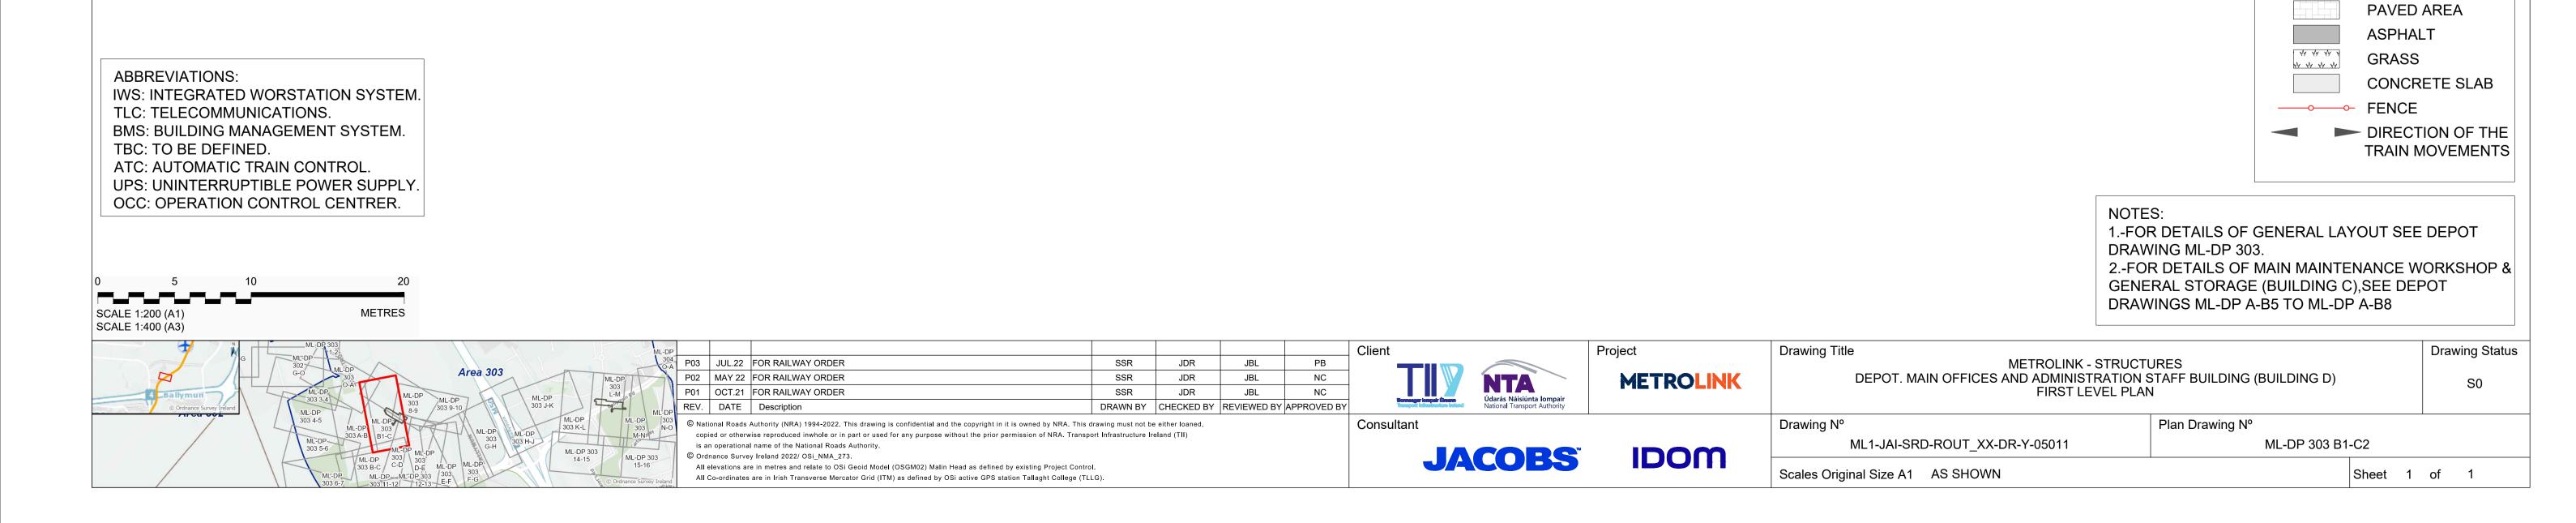


LEGEND

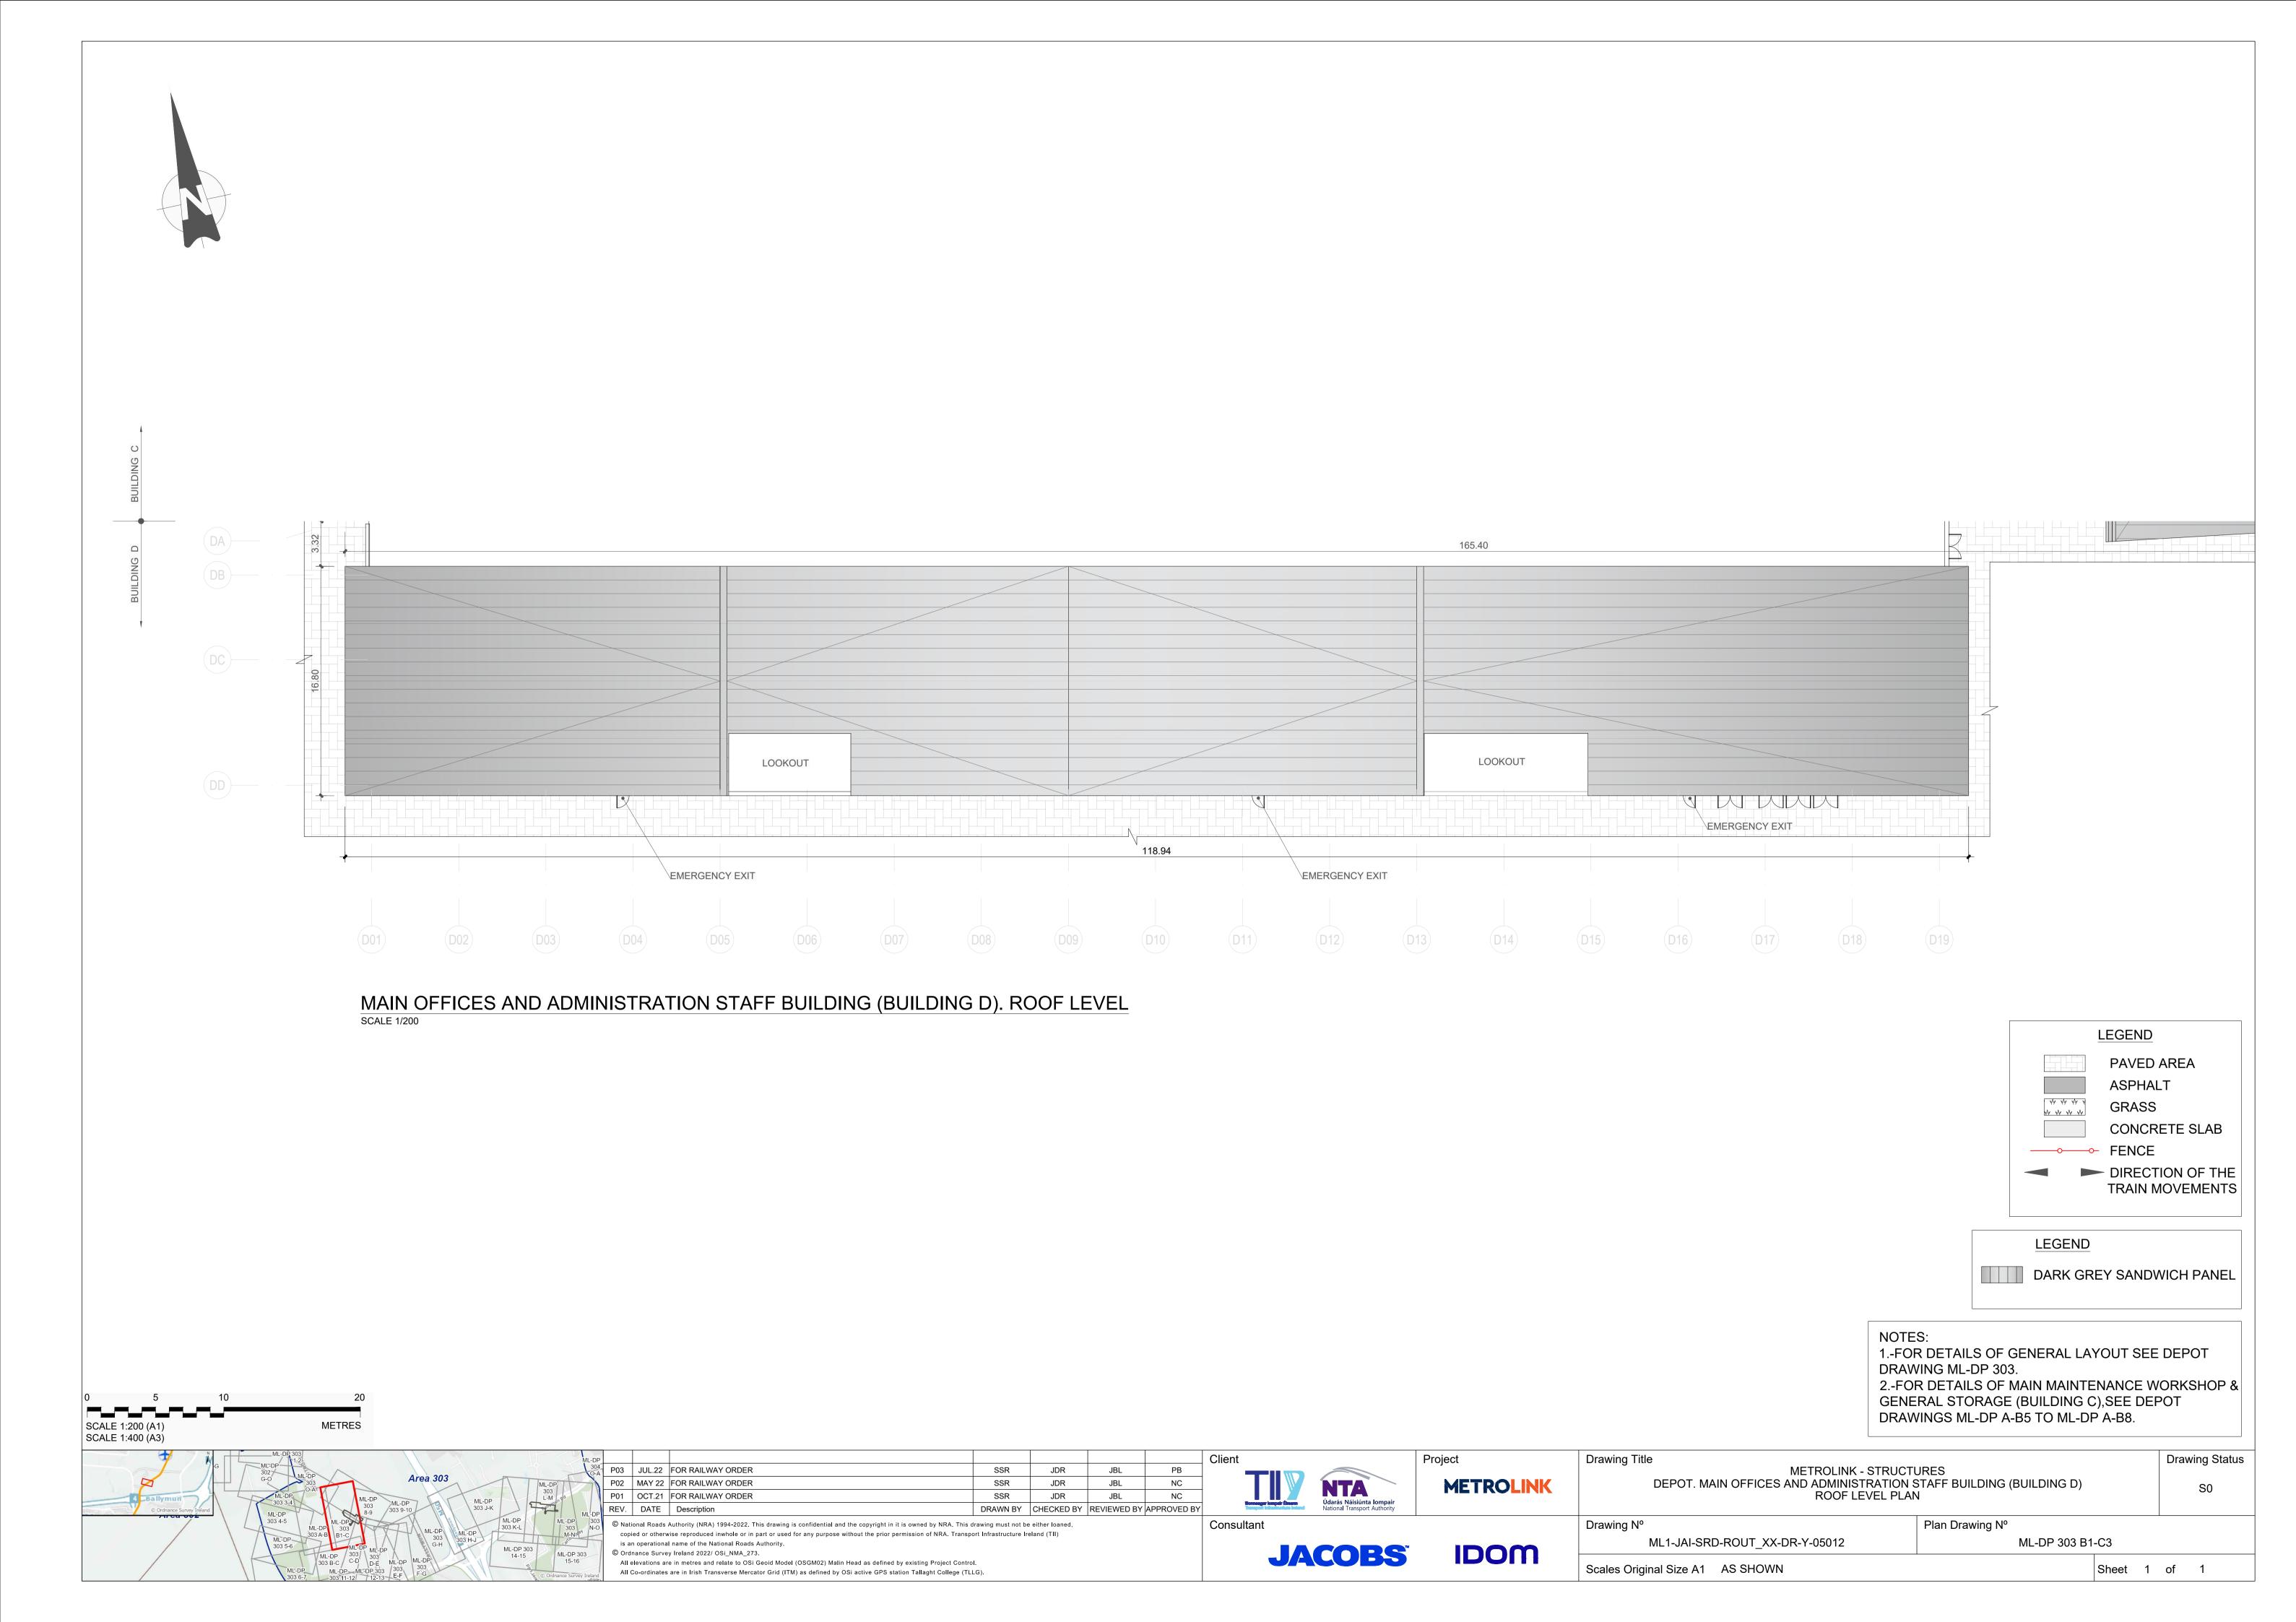


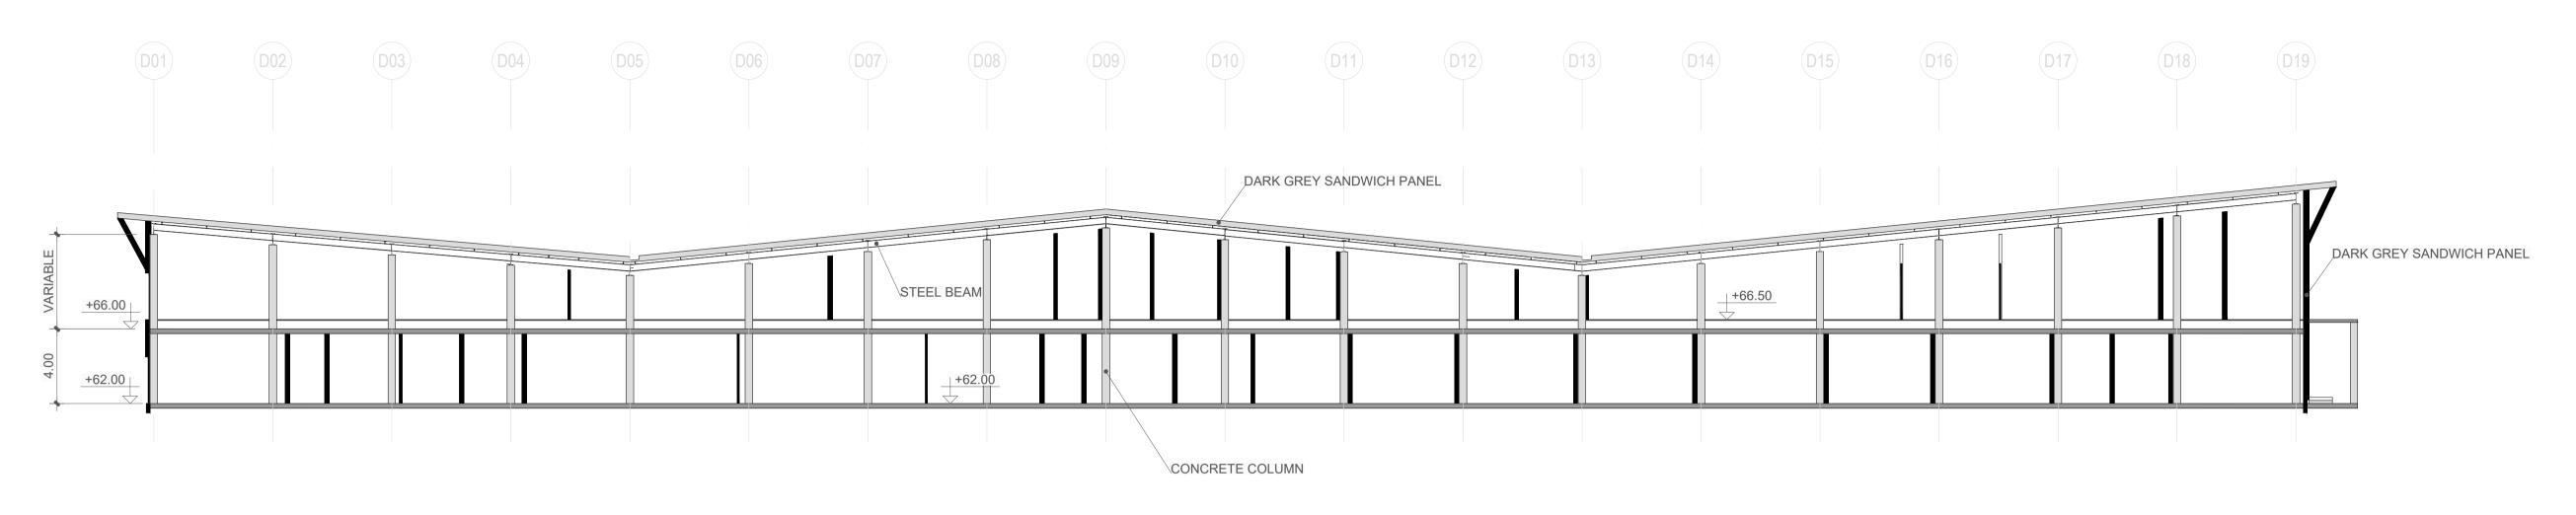

MAIN OFFICES AND ADMINISTRATION STAFF BUILDING (BUILDING D). LONGITUDINAL SECTION

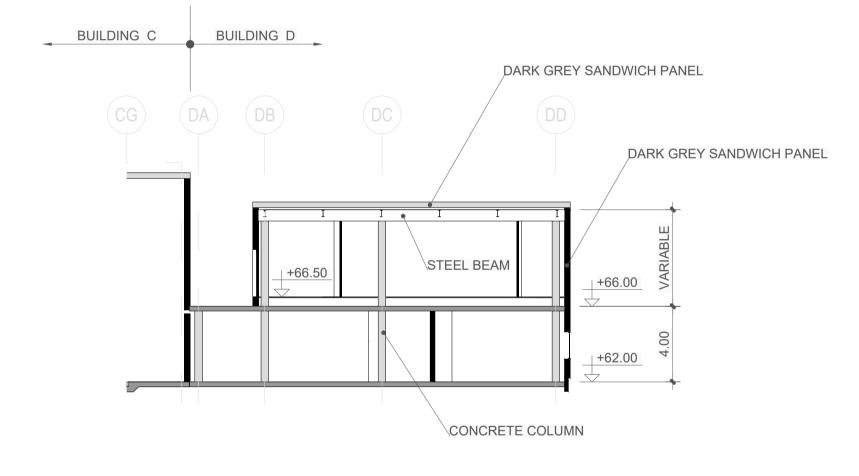

MAIN OFFICES AND ADMINISTRATION STAFF BUILDING (BUILDING D). CROSS SECTION

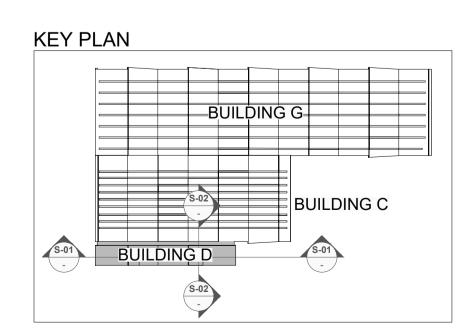

Drawing N⁰

LEGEND PAVED AREA **ASPHALT GRASS** W W W W **CONCRETE SLAB** — FENCE DIRECTION OF THE TRAIN MOVEMENTS

DARK GREY SANDWICH PANEL

Drawing Status

NOTES: 1.-FOR DETAILS OF GENERAL LAYOUT SEE DEPOT DRAWING ML-DP 303. 2.-FOR DETAILS OF MAIN MAINTENANCE WORKSHOP &

LEGEND

GENERAL STORAGE (BUILDING C), SEE DEPOT DRAWINGS ML-DP A-B5 TO ML-DP A-B8.

SCALE 1:400 (A3) P03 MAY 22 FOR RAILWAY ORDER SSR JDR NC P02 NOV.21 FOR RAILWAY ORDER SSR JDR NC JBL P01 OCT.21 FOR RAILWAY ORDER SSR DRAWN BY CHECKED BY REVIEWED BY APPROVED BY REV. DATE Description is an operational name of the National Roads Authority

© Ordnance Survey Ireland 2022/ OSi_NMA_273.

All Co-ordinates are in Irish Transverse Mercator Grid (ITM) as defined by OSi active GPS station Tallaght College (TLLG).

SCALE 1:200 (A1)

Údarás Náisiúnta lompair National Transport Authority


JACOBS


METROLINK


IDOM

Drawing Title METROLINK - STRUCTURES DEPOT. MAIN OFFICES AND ADMINISTRATION STAFF BUILDING (BUILDING D) SECTIONS

Plan Drawing Nº ML1-JAI-SRD-ROUT_XX-DR-Y-05013 ML-DP 303 B1-C4 Scales Original Size A1 AS SHOWN Sheet 1 of 1

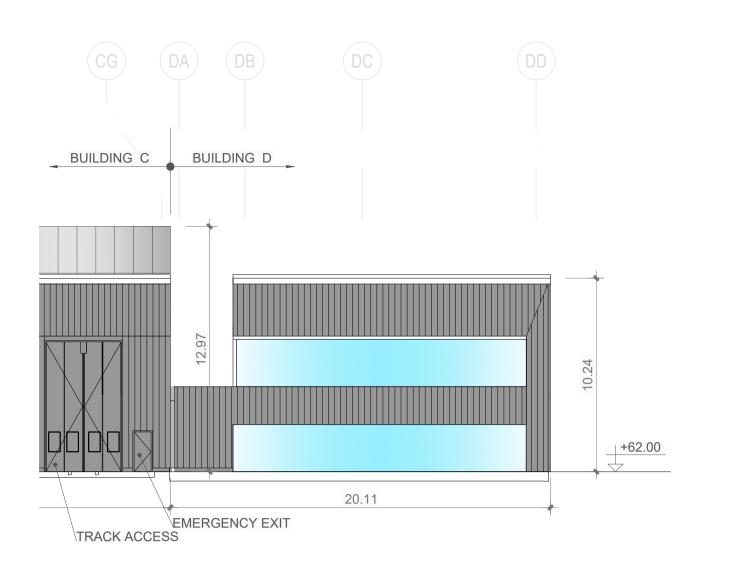

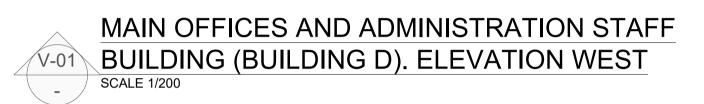

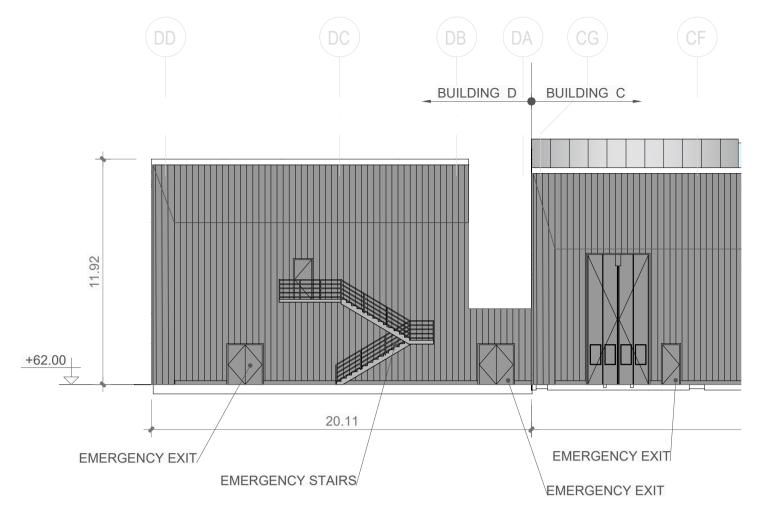


MAIN OFFICES AND ADMINISTRATION STAFF
BUILDING (BUILDING D). ELEVATION EAST
SCALE 1/200


KEY PLAN

LEGEND


DARK GREY SANDWICH PANEL

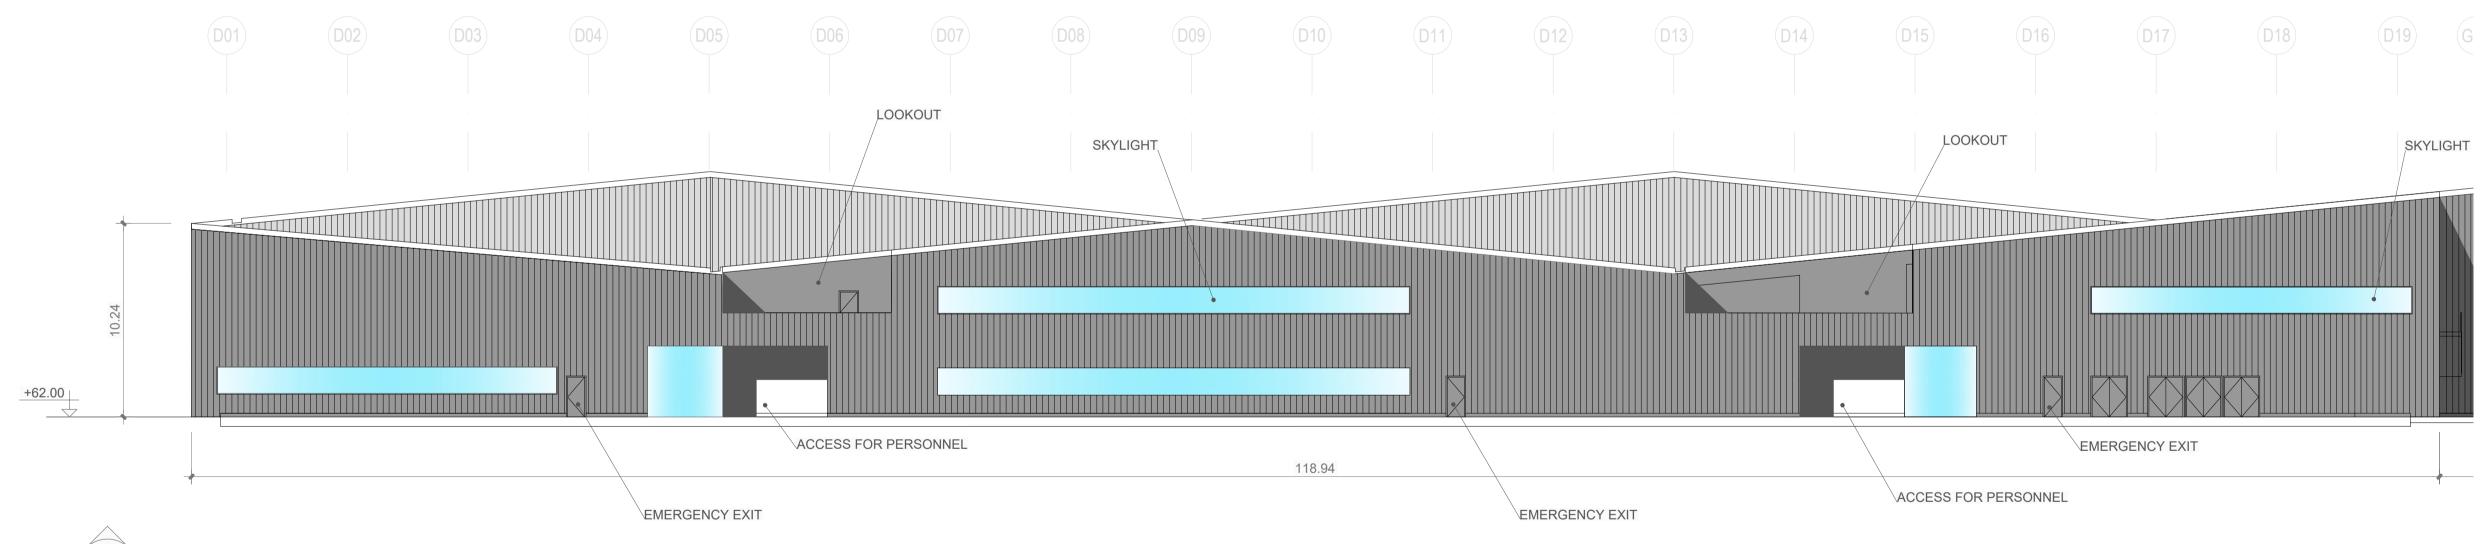


MAIN OFFICES AND ADMINISTRATION STAFF BUILDING (BUILDING D). ELEVATION SOUTH SCALE 1/200

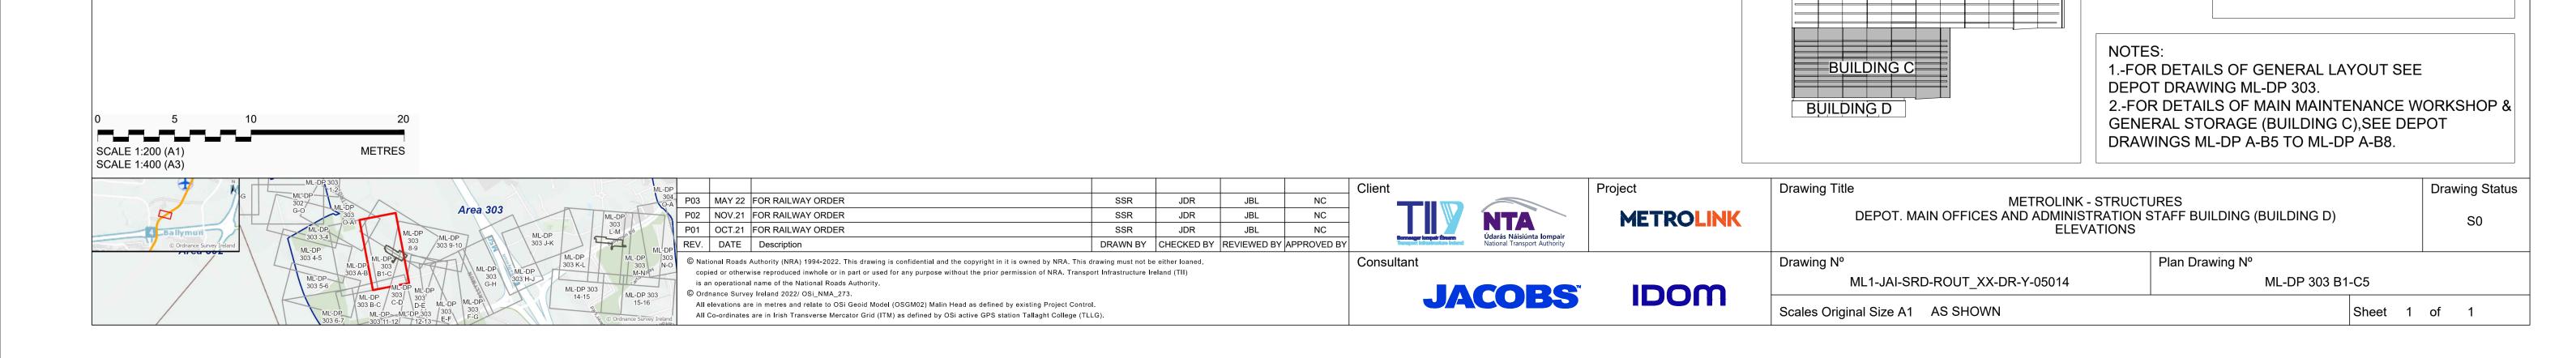



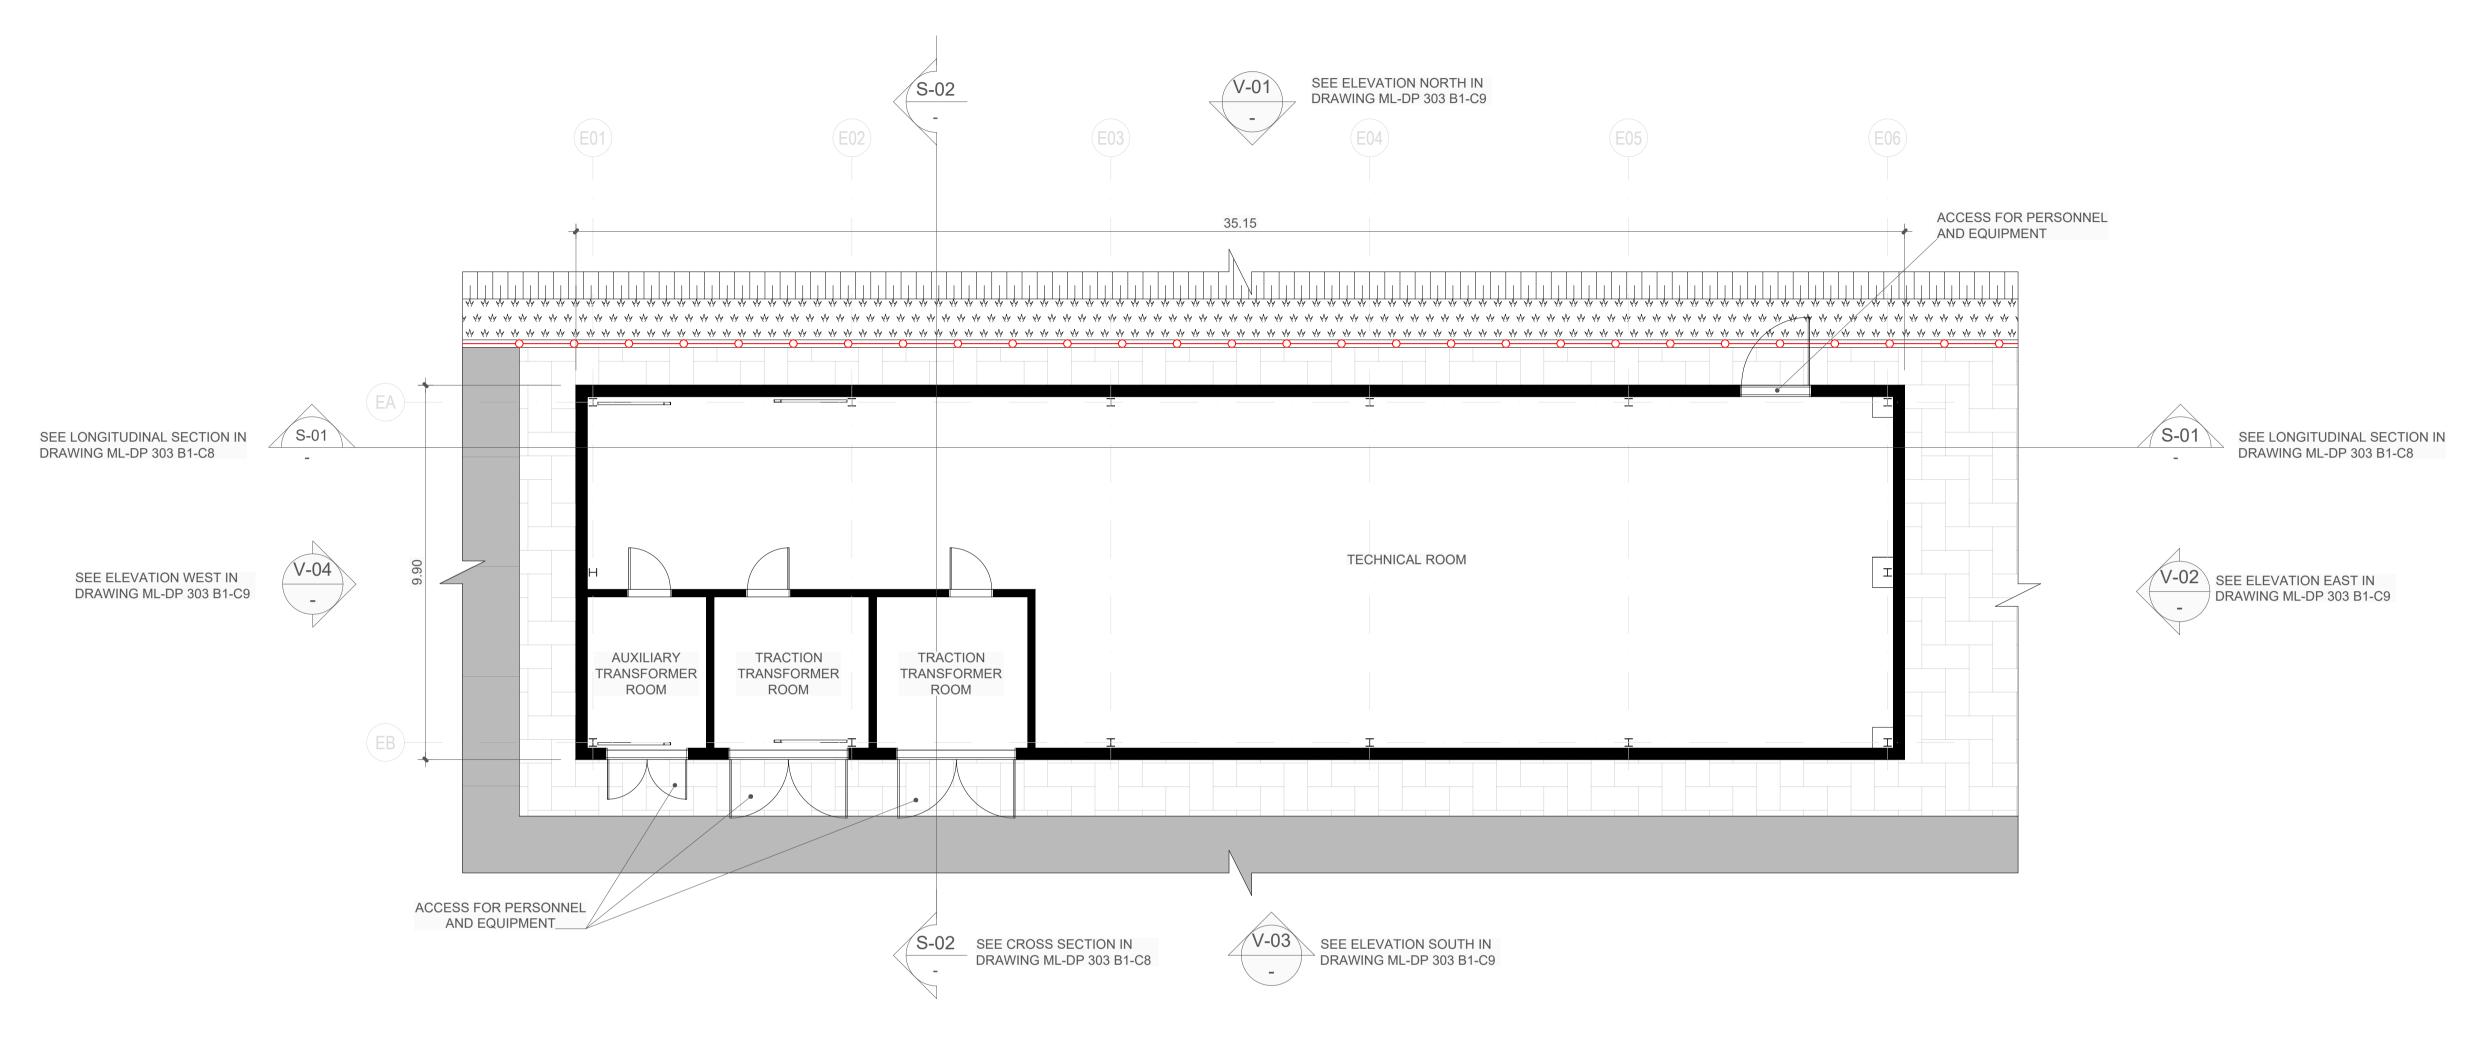



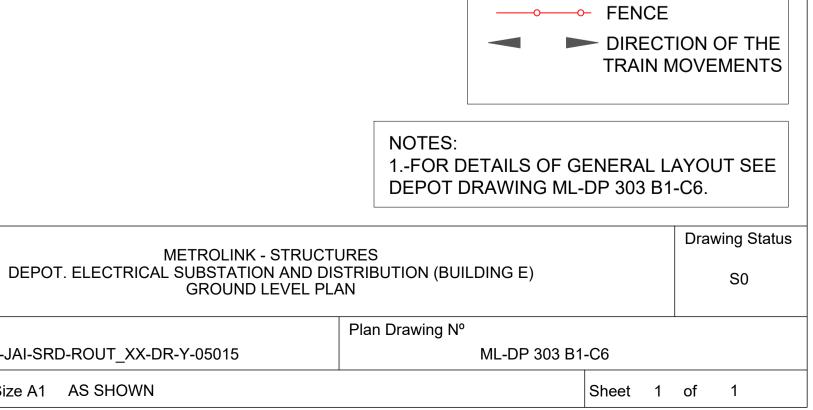

LEGEND

PAVED AREA

CONCRETE SLAB

ASPHALT

GRASS

W W W W

SCALE 1:100 (A1) SCALE 1:200 (A3) SSR P03 JUL.22 FOR RAILWAY ORDER PB P02 MAY 22 FOR RAILWAY ORDER SSR JDR NC JBL P01 OCT.21 FOR RAILWAY ORDER SSR DRAWN BY CHECKED BY REVIEWED BY APPROVED BY copied or otherwise reproduced inwhole or in part or used for any purpose without the prior permission of NRA. Transport Infrastructure Ireland (TII)

is an operational name of the National Roads Authority.

All elevations are in metres and relate to OSi Geoid Model (OSGM02) Malin Head as defined by existing Project Control.

All Co-ordinates are in Irish Transverse Mercator Grid (ITM) as defined by OSi active GPS station Tallaght College (TLLG).

JACOBS

Údarás Náisiúnta lompair National Transport Authority

IDOM


METROLINK


Drawing Title

Plan Drawing N⁰ Drawing Nº ML1-JAI-SRD-ROUT_XX-DR-Y-05015 Scales Original Size A1 AS SHOWN


METROLINK - STRUCTURES

GROUND LEVEL PLAN

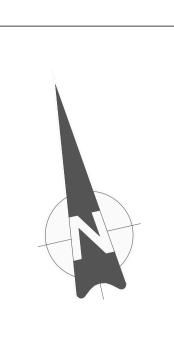

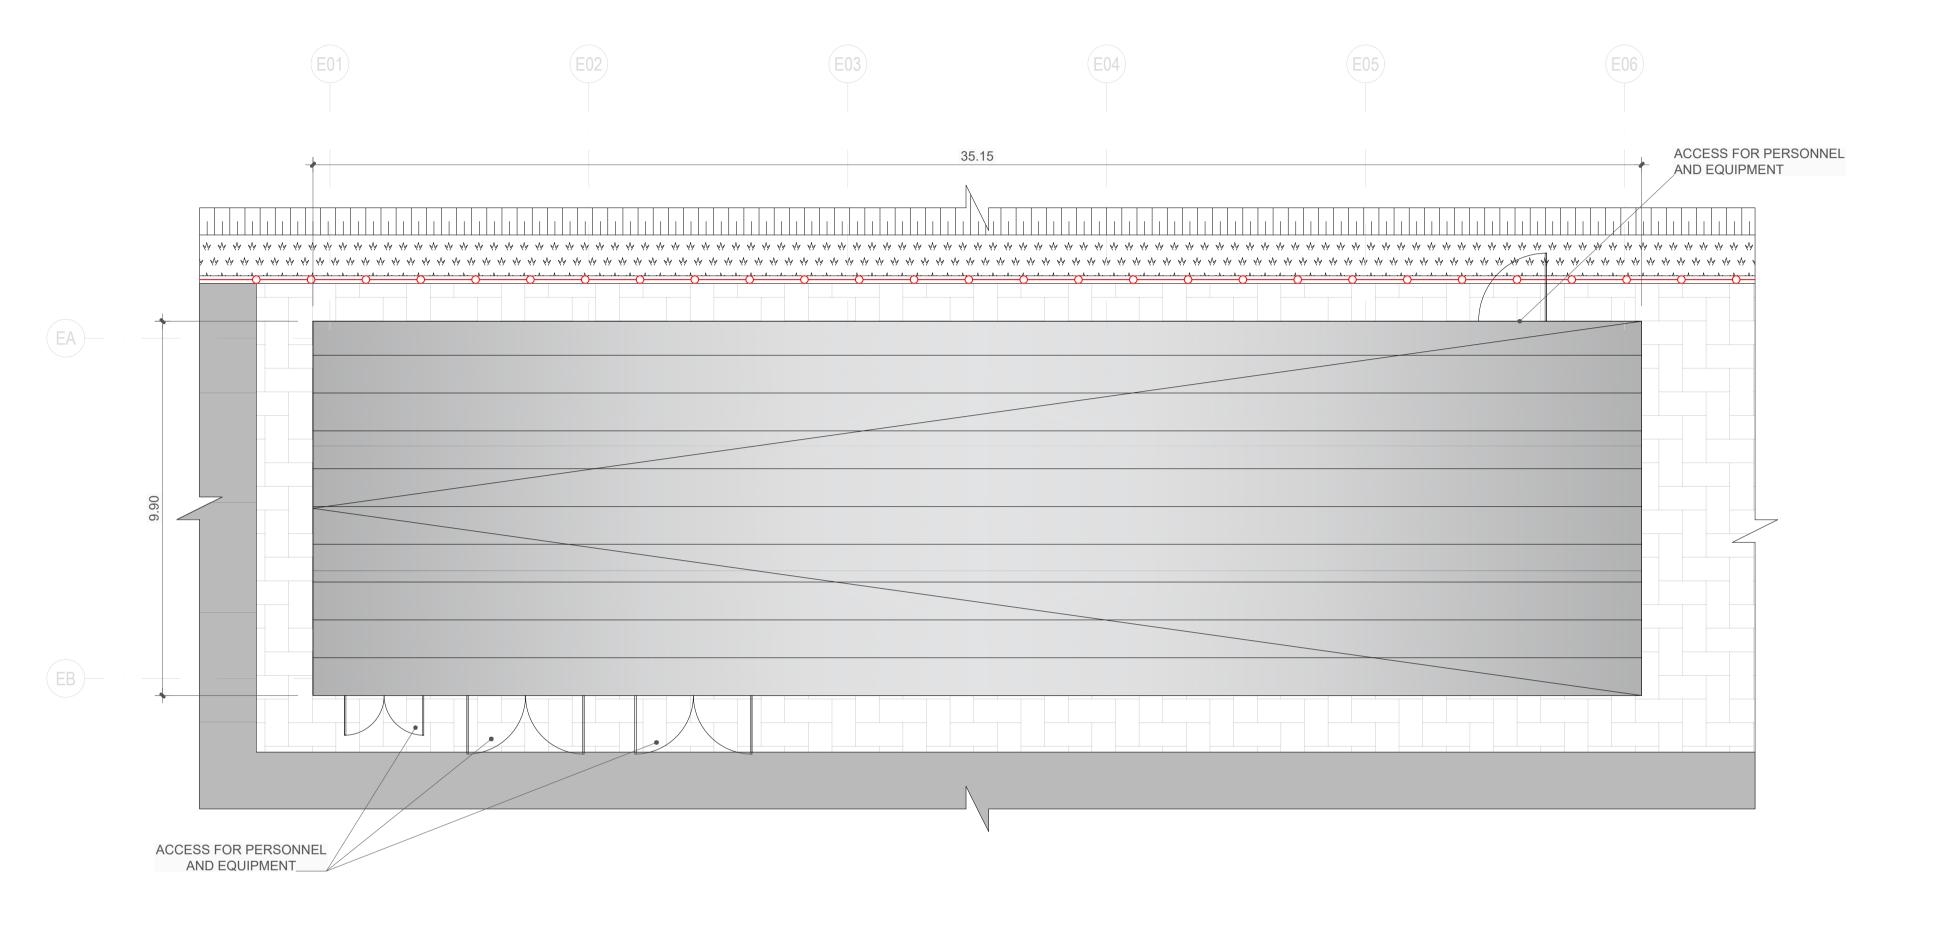

ELECTRICAL SUBSTATION AND DISTRIBUTION (BUILDING E). ROOF LEVEL

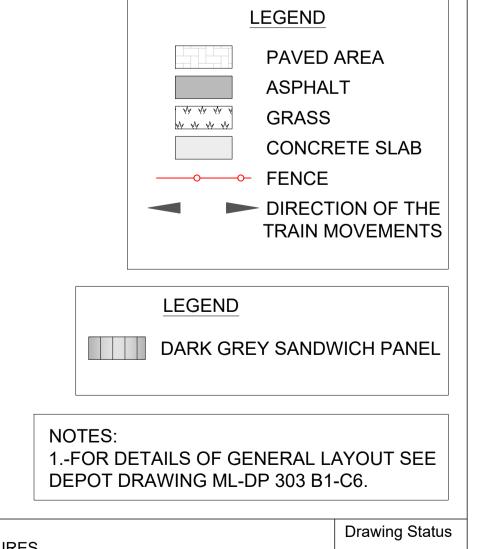

SCALE 1:100 (A1)
SCALE 1:200 (A3)

ML-DP 102

Area 303

ML-DP 303

© National Roads Authority (NRA) 1994-2022. This drawing is confidential and the copyright in it is owned by NRA. This drawing must not be either loaned, copied or otherwise reproduced inwhole or in part or used for any purpose without the prior permission of NRA. Transport Infrastructure Ireland (TII) is an operational name of the National Roads Authority.

All elevations are in metres and relate to OSi Geoid Model (OSGM02) Malin Head as defined by existing Project Control.

All Co-ordinates are in Irish Transverse Mercator Grid (ITM) as defined by OSi active GPS station Tallaght College (TLLG).

Vidarás Náisiúnta lompair National Transport Authority

JACOBS

METROLINK

IDOM

Drawing Title


METROLINK - STRUCTURES
DEPOT. ELECTRICAL SUBSTATION AND DISTRIBUTION (BUILDING E)
ROOF LEVEL PLAN


Drawing N°


Plan Drawing N°


Drawing N° Plan Drawing N° ML1-JAI-SRD-ROUT_XX-DR-Y-05016 ML-DP 303 B1-C7


Scales Original Size A1 AS SHOWN Sheet 1 of 1

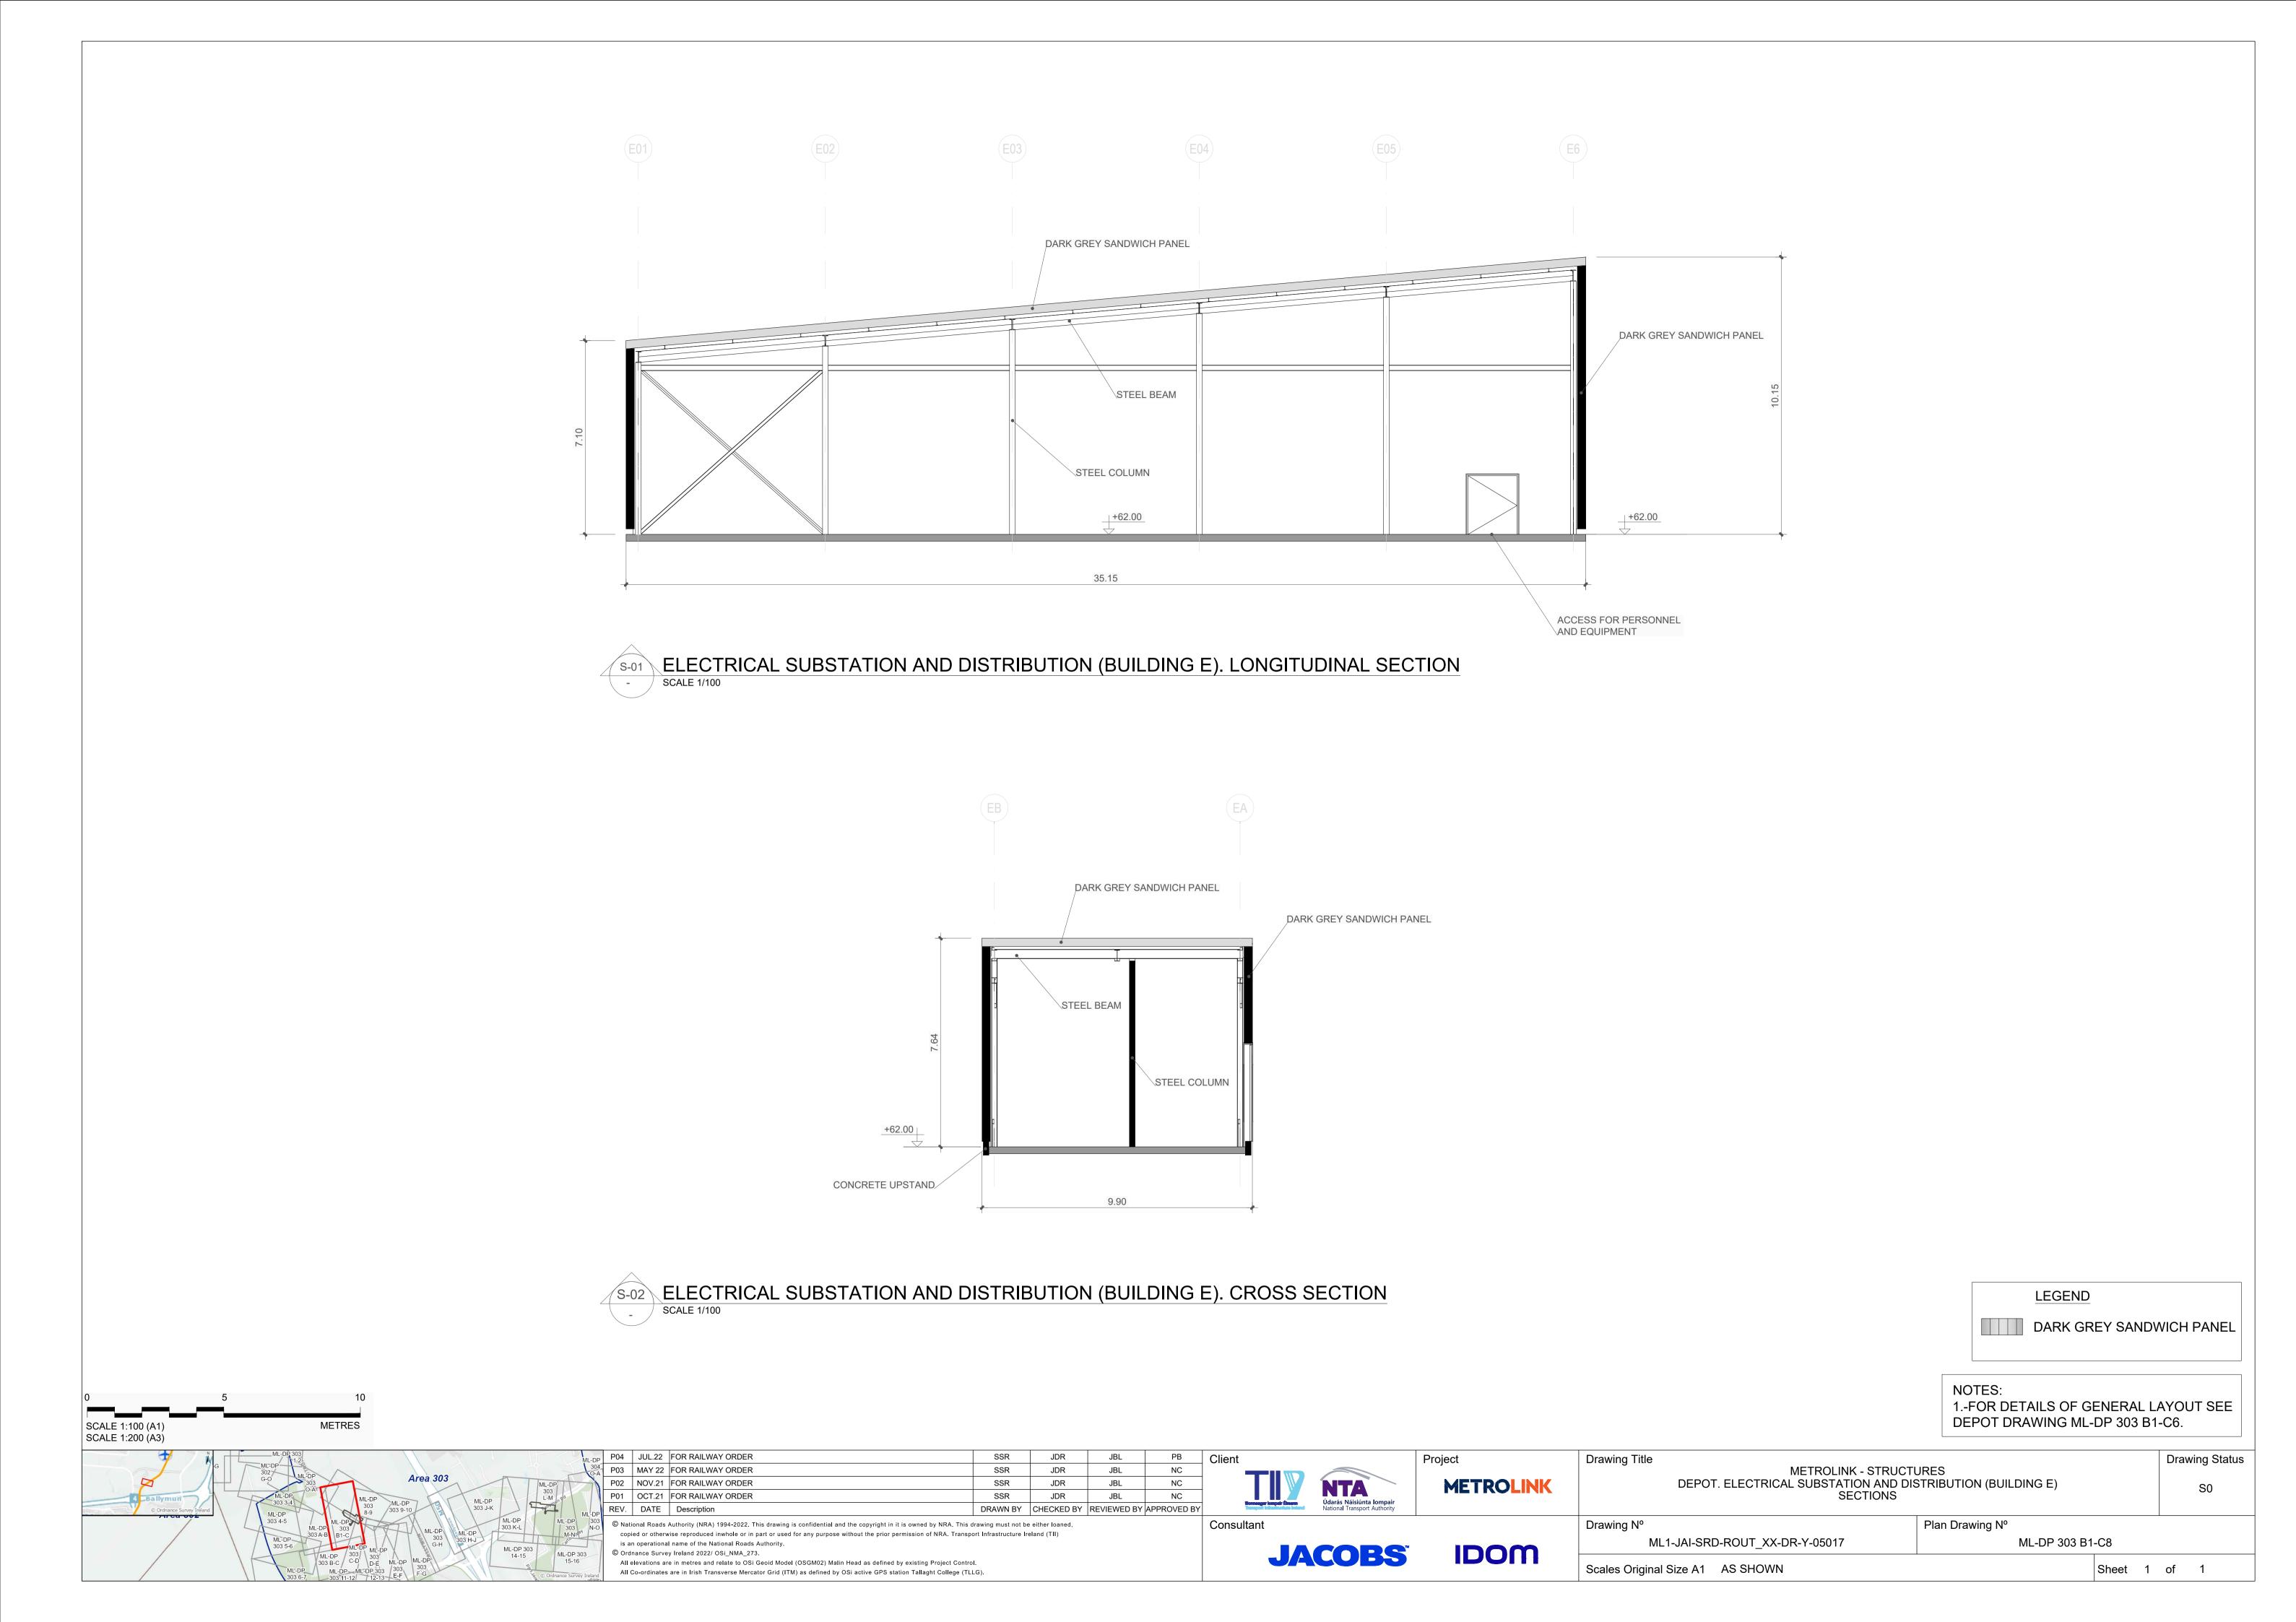


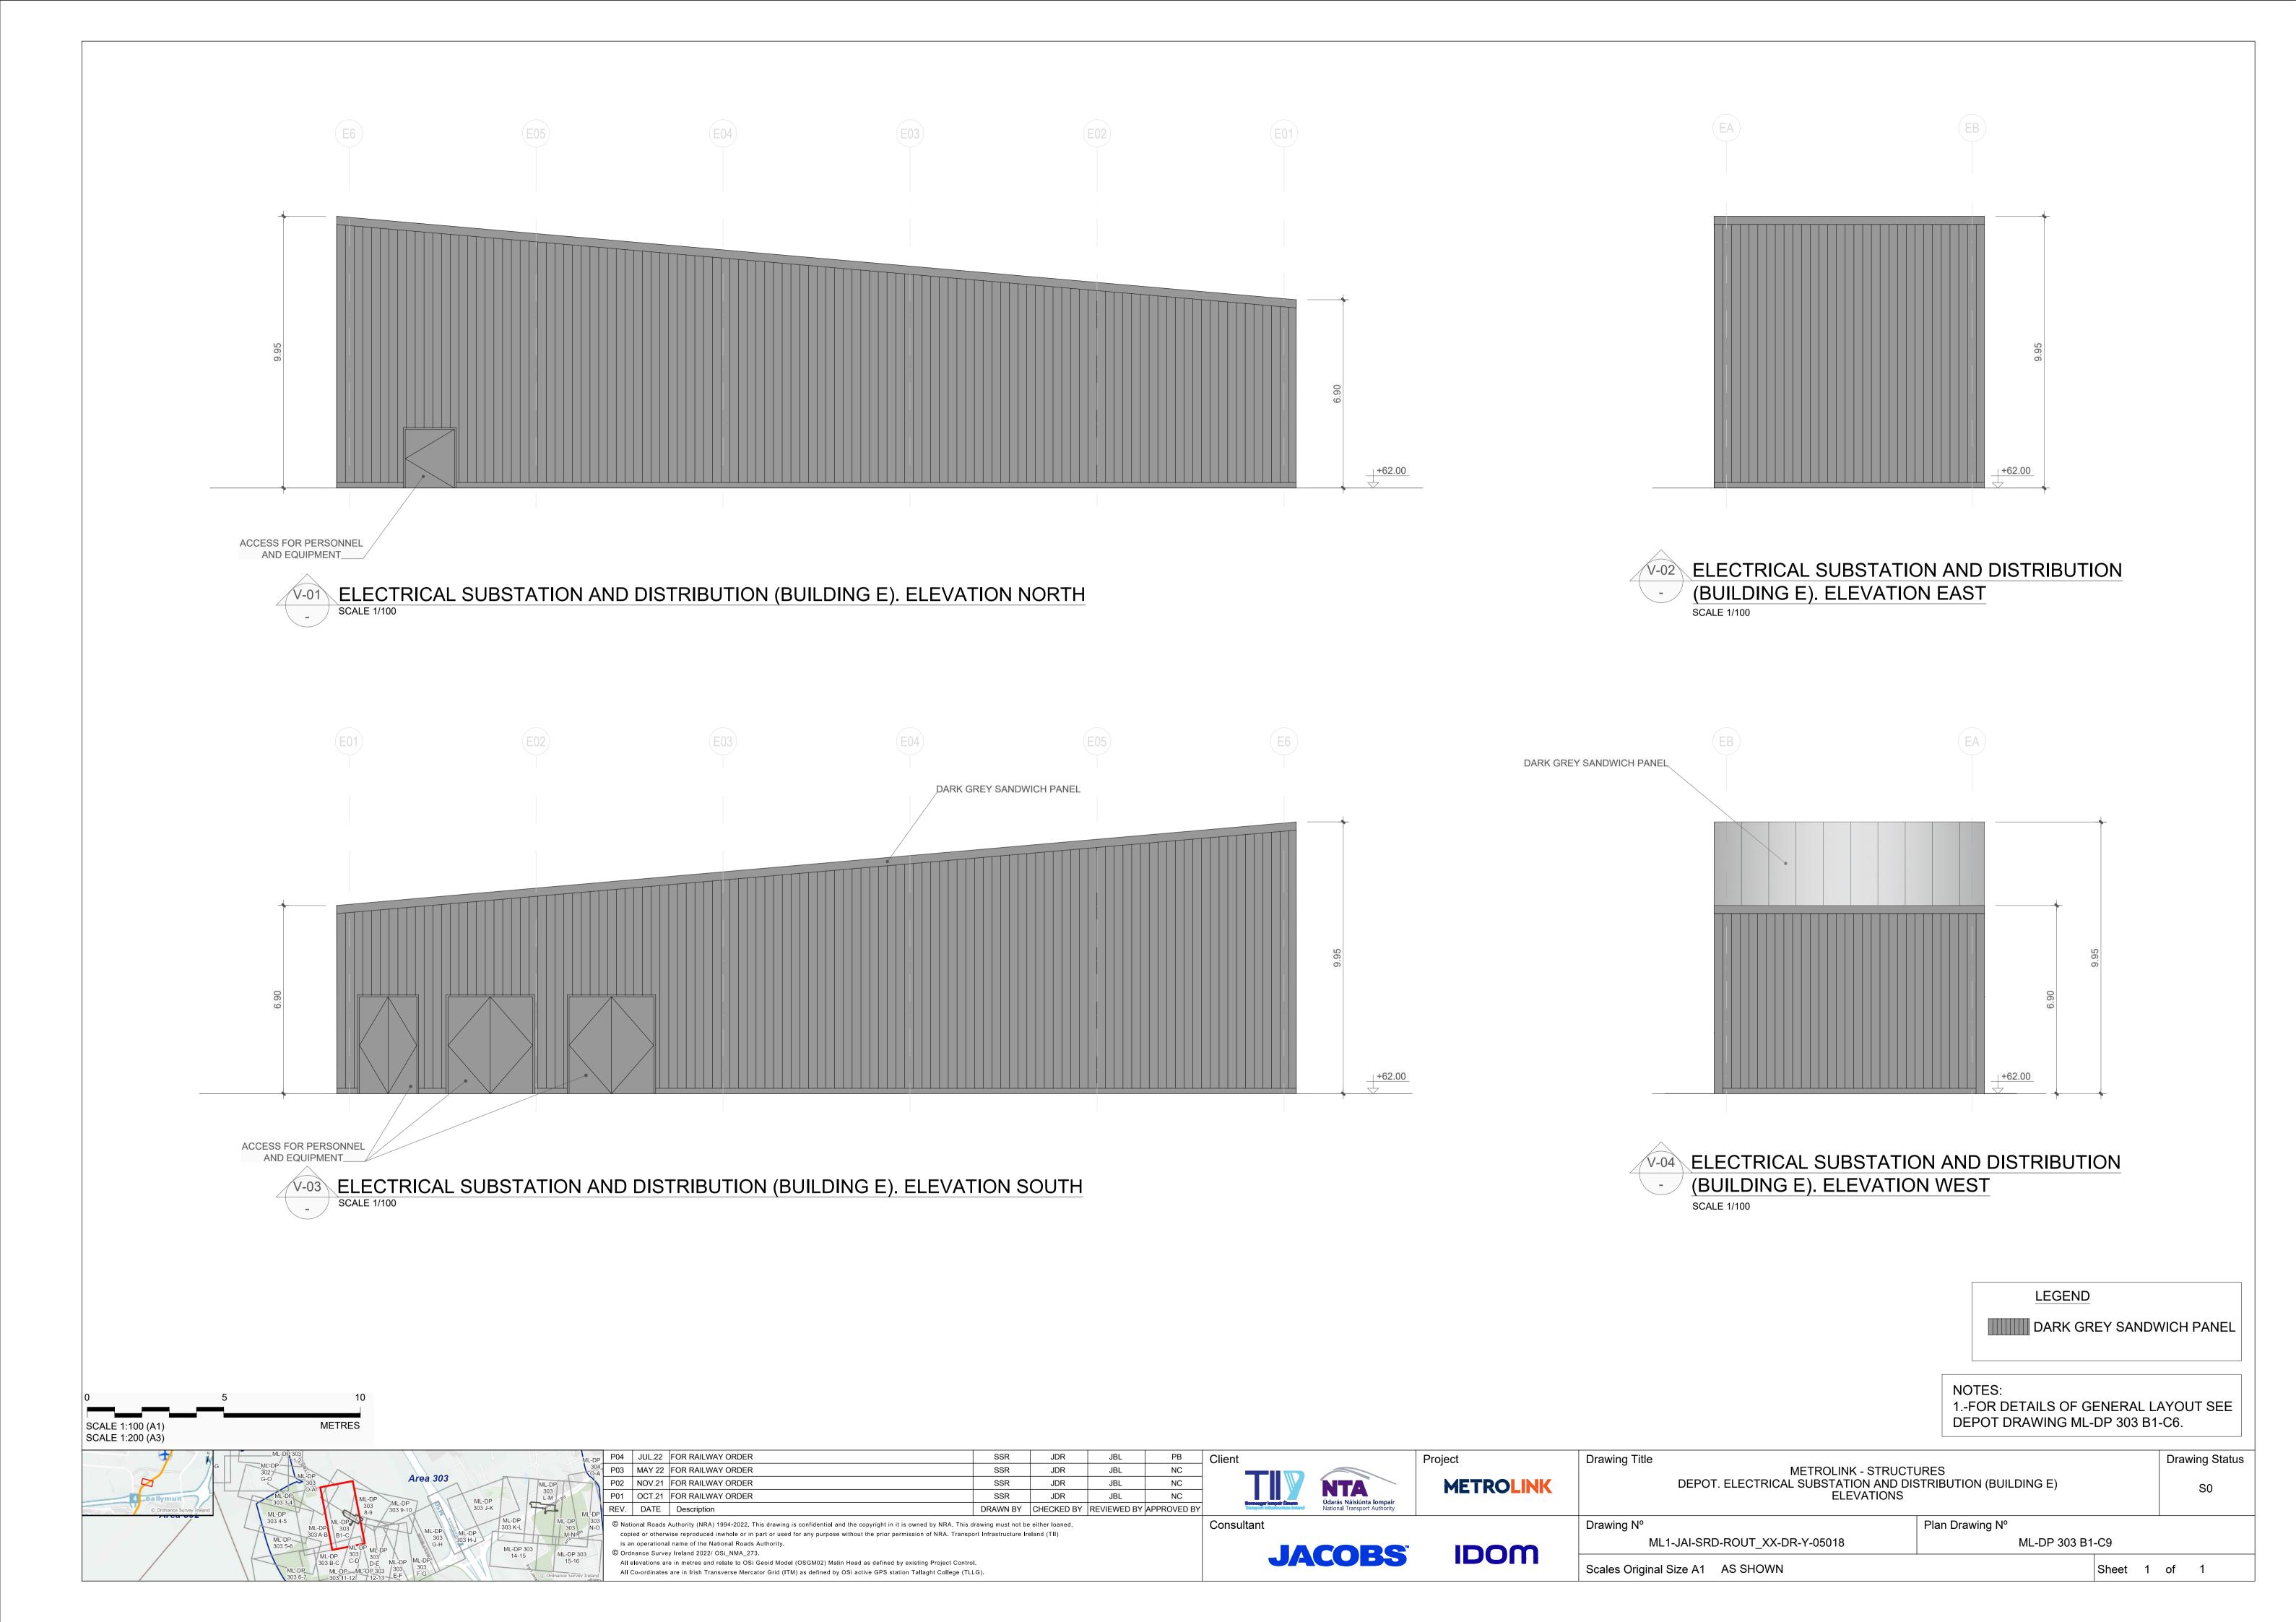


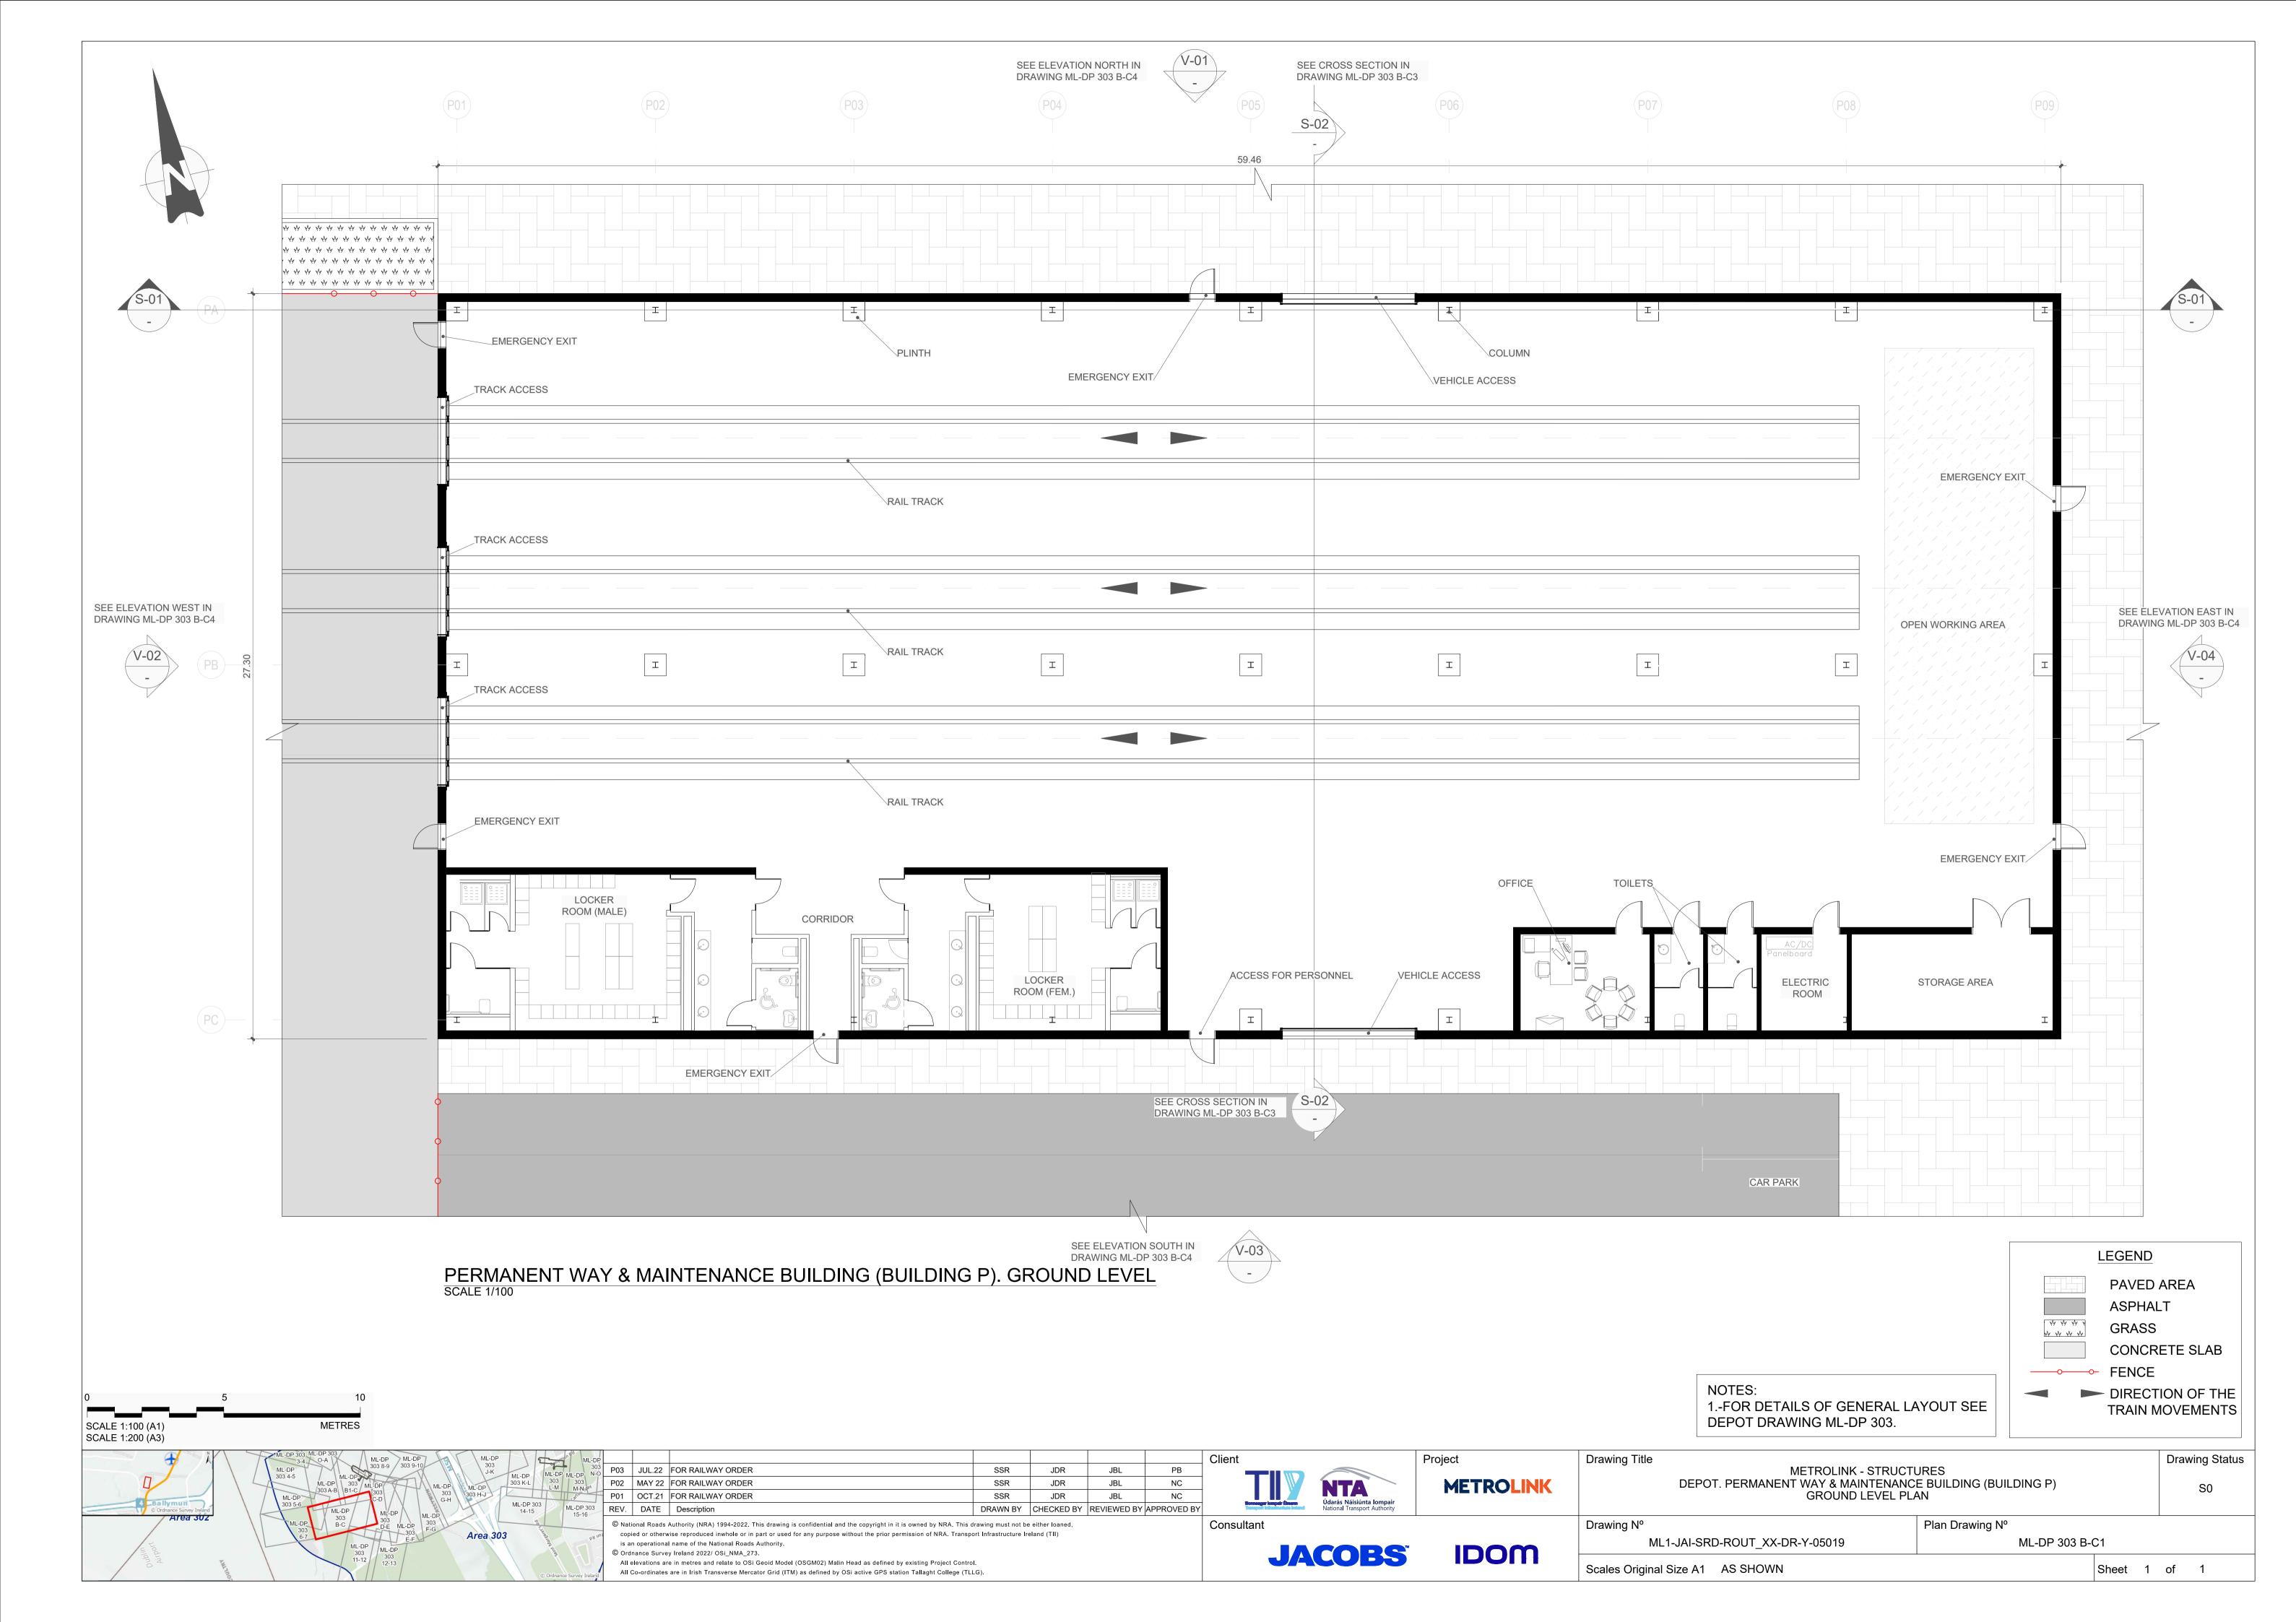

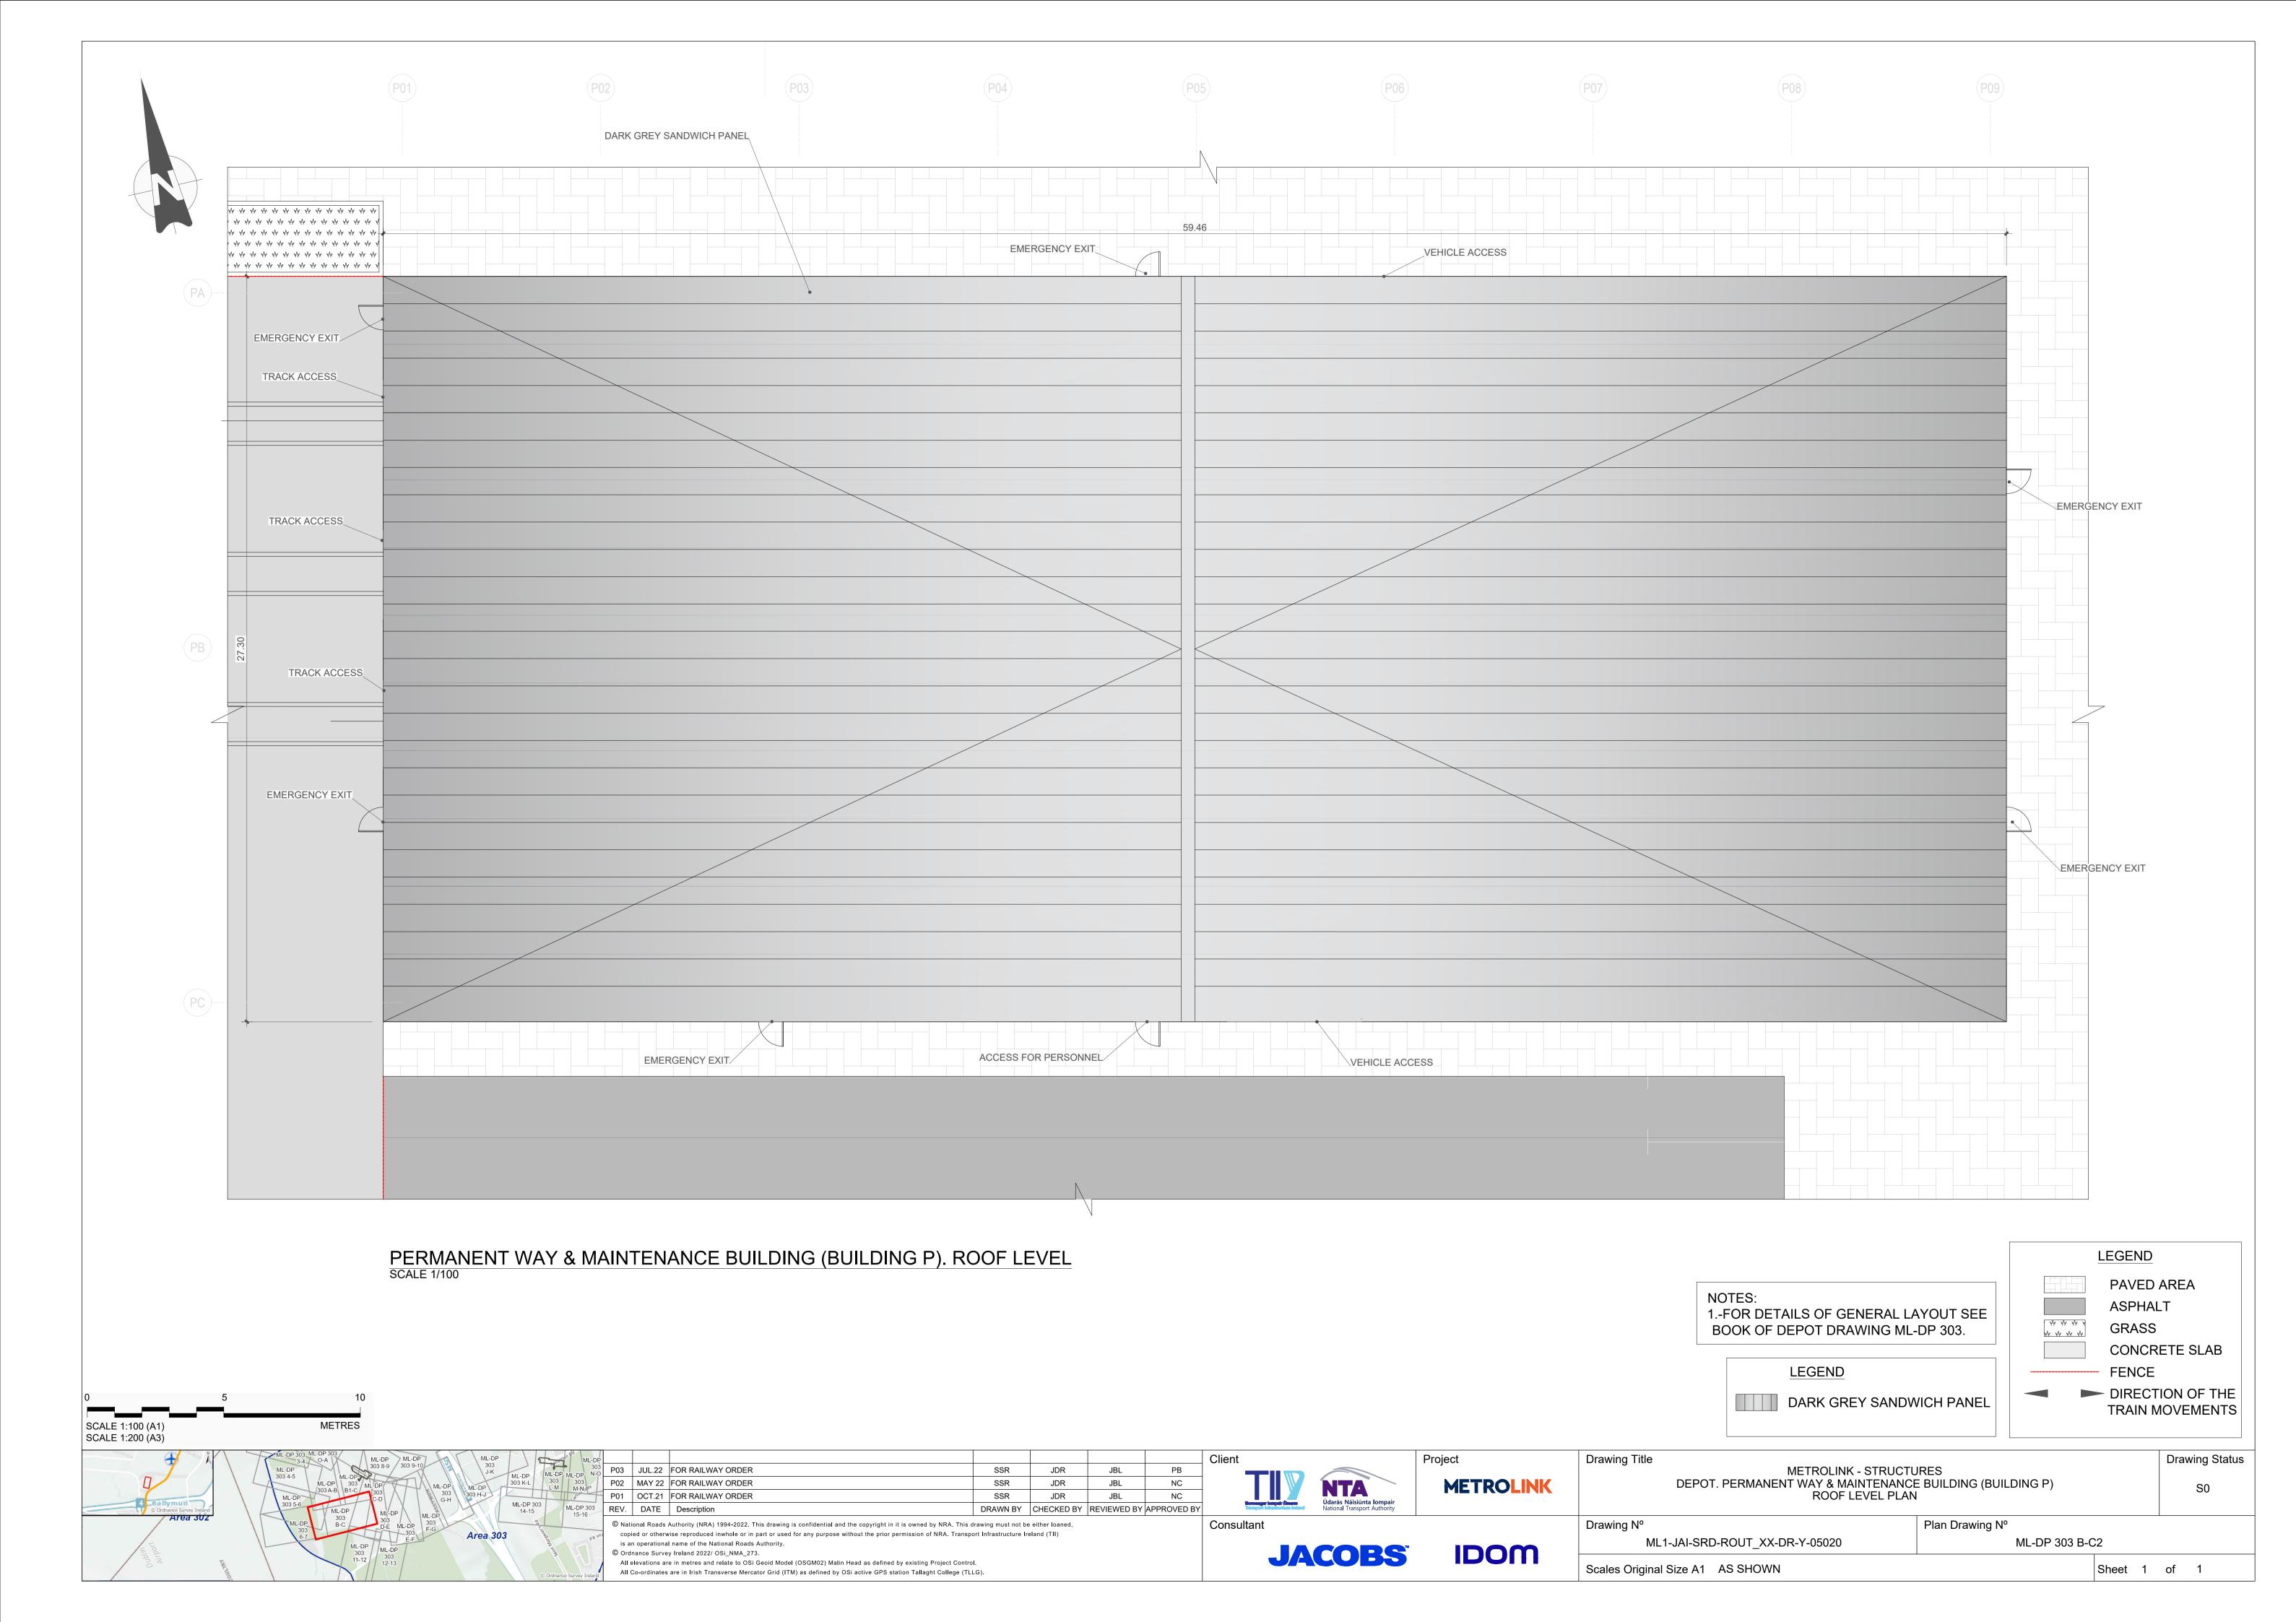

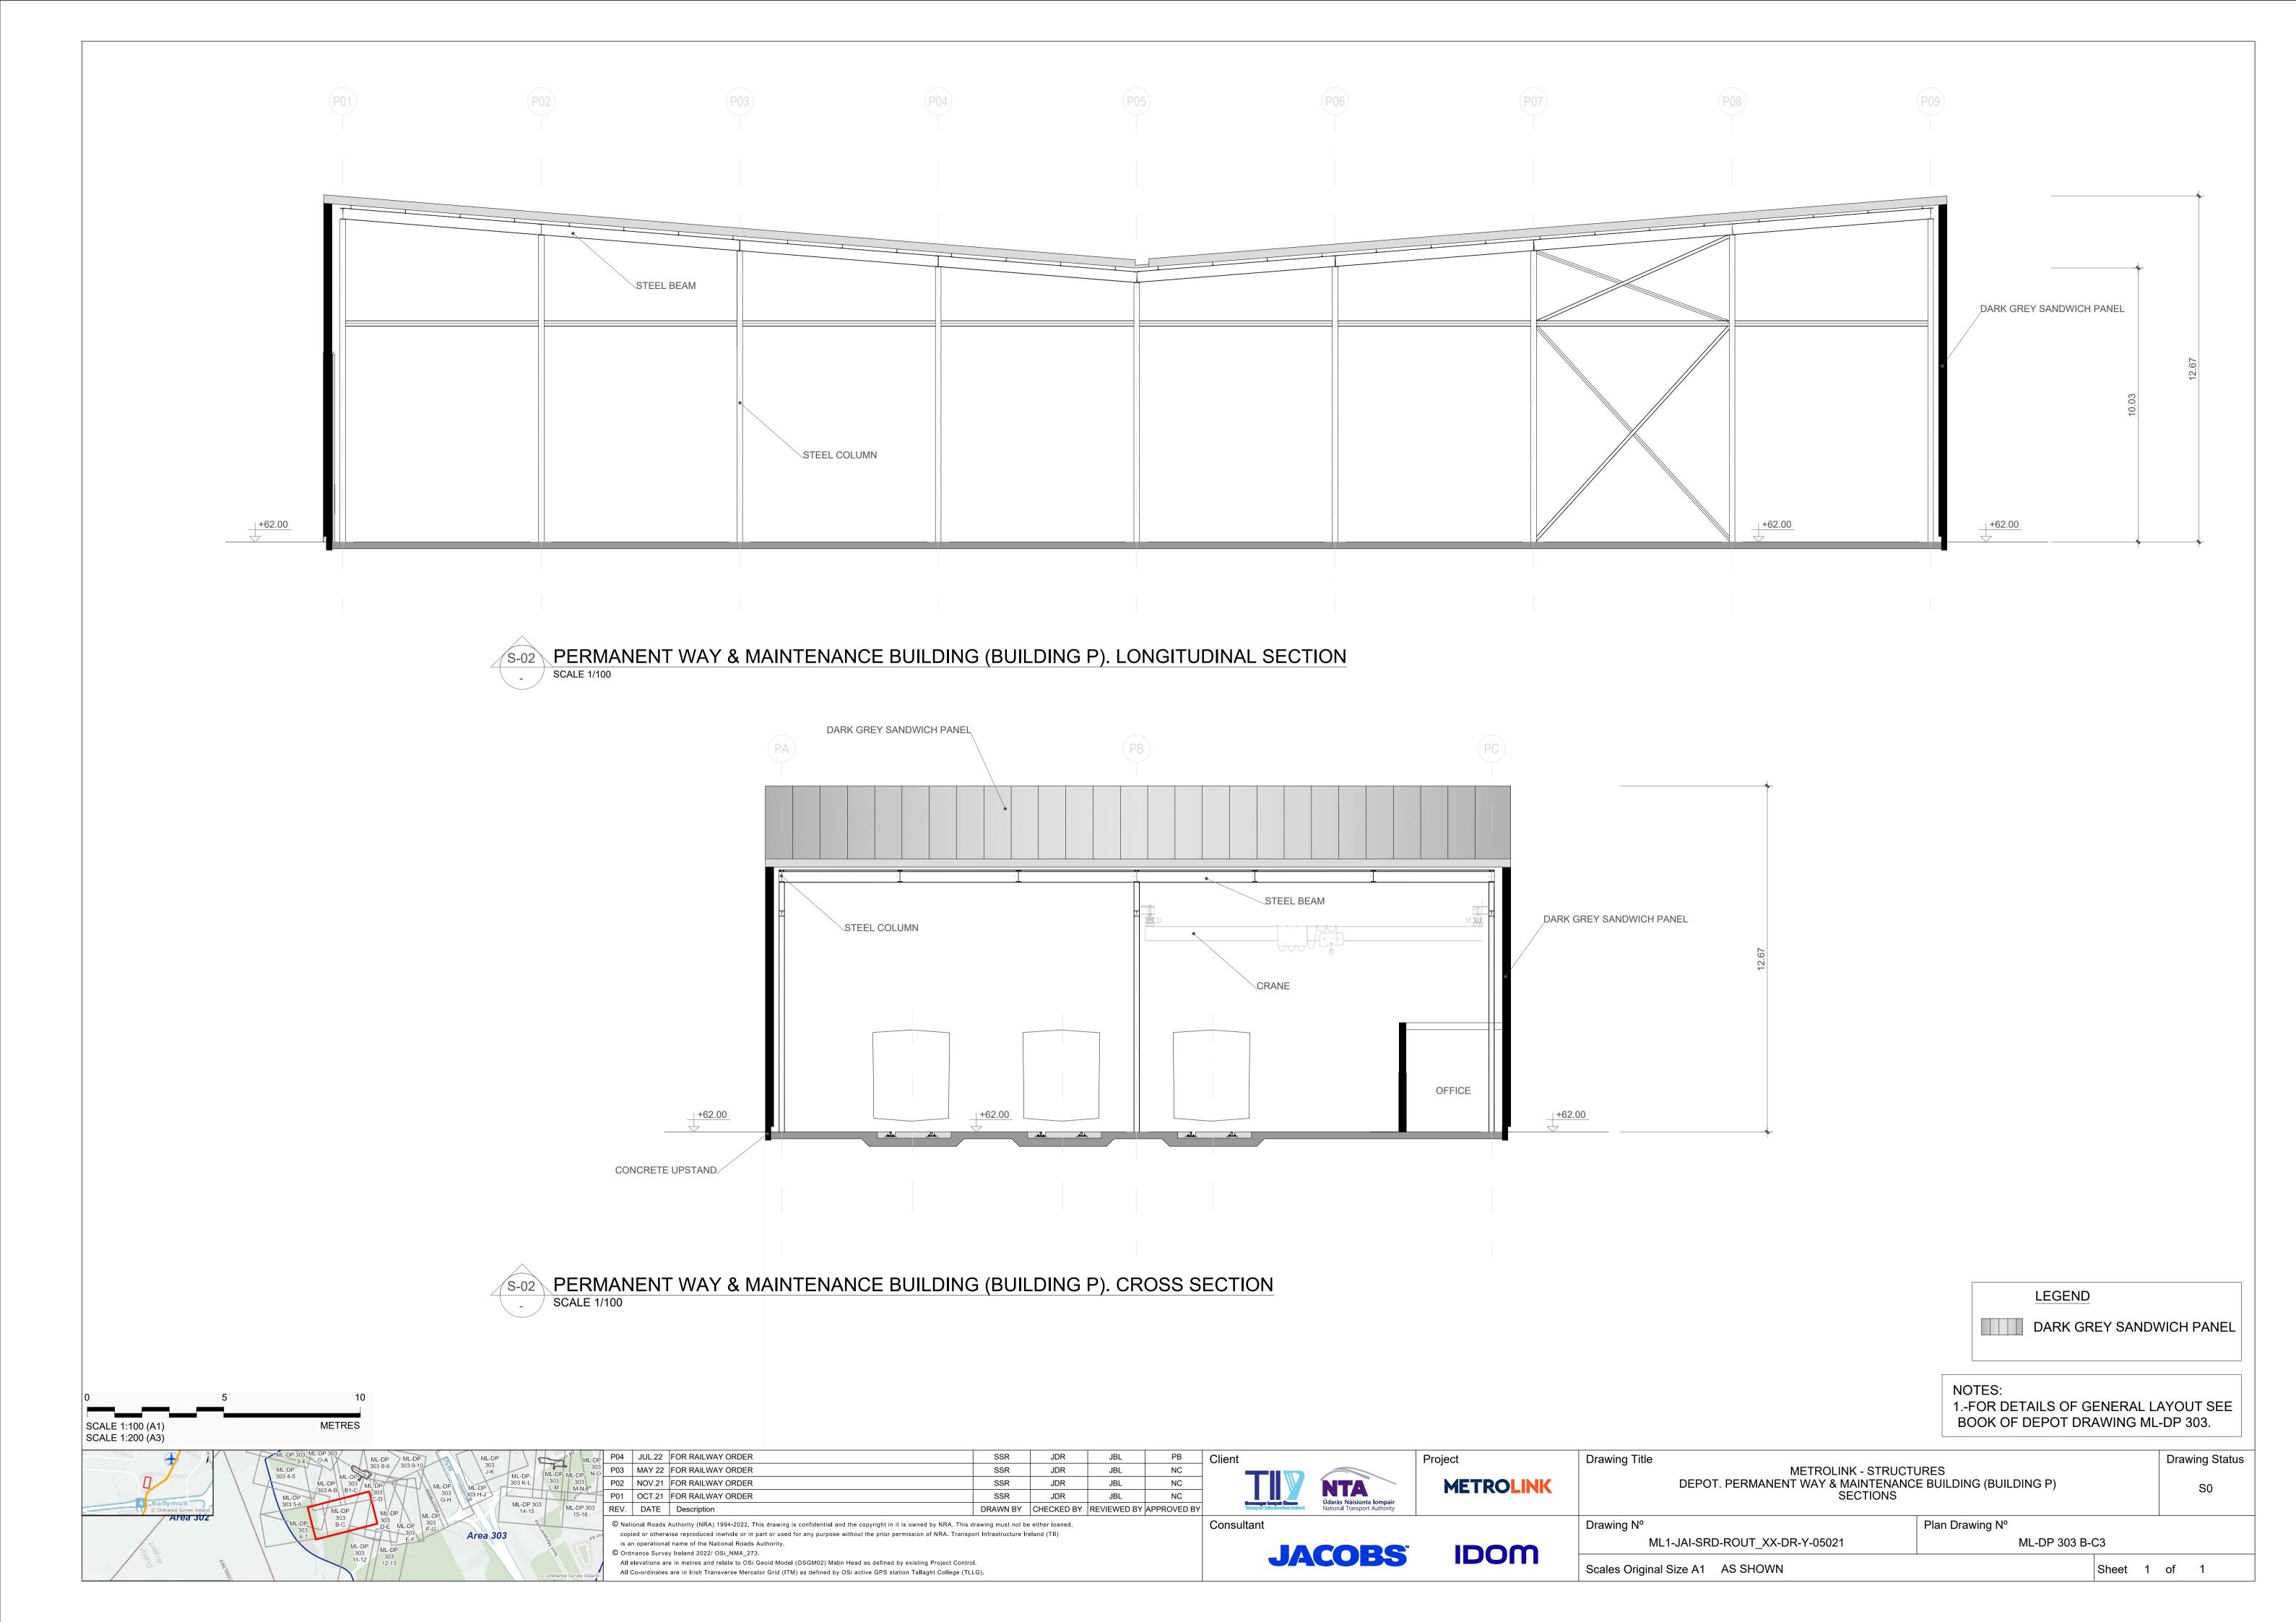

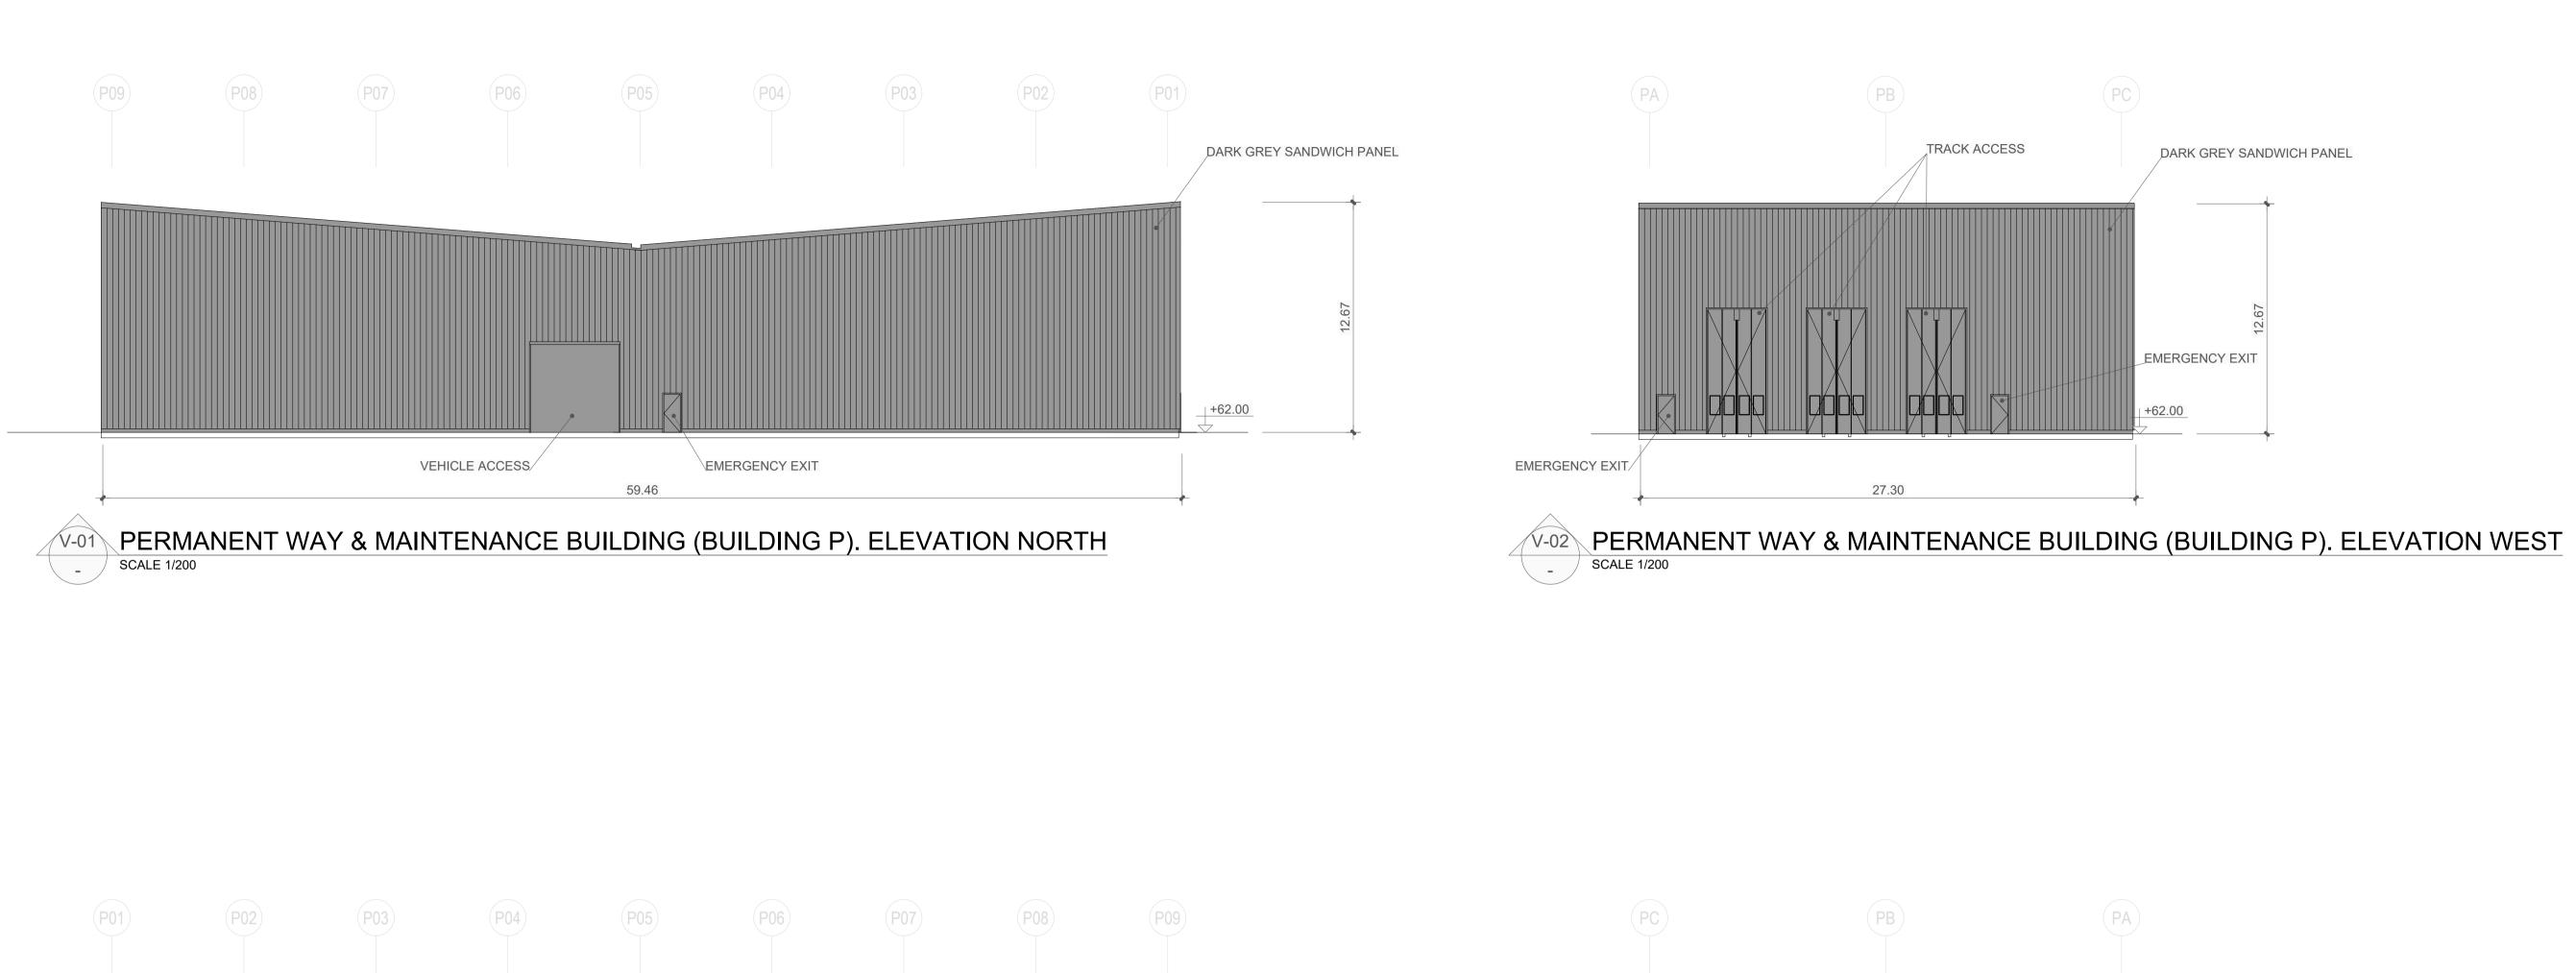

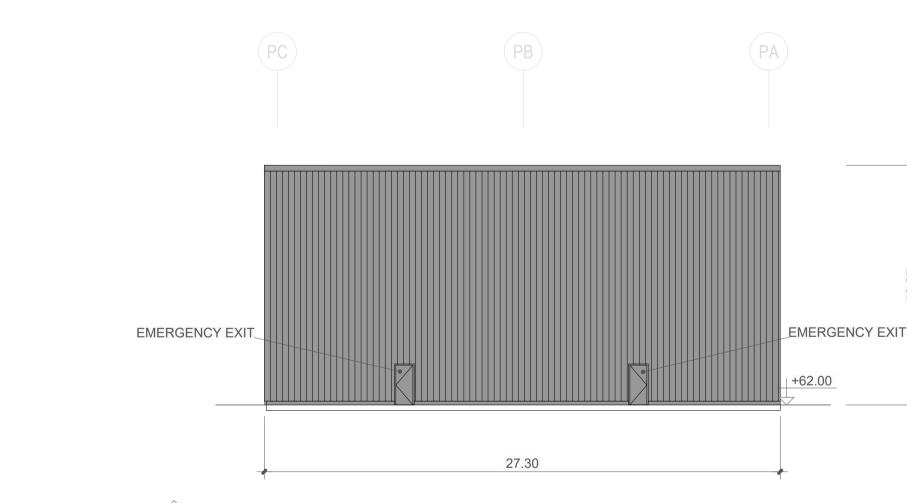

TRACK ACCESS


27.30

DARK GREY SANDWICH PANEL

EMERGENCY EXIT

+62.00



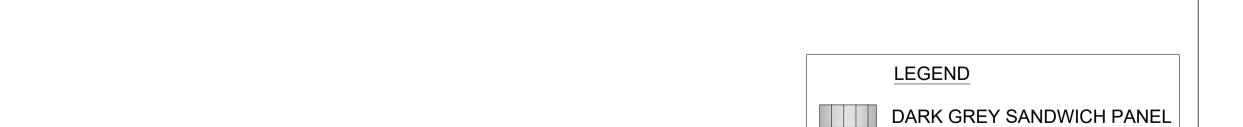


V-04 PERMANENT WAY & MAINTENANCE BUILDING (BUILDING P). ELEVATION EAST

NOTES: 1.-FOR DETAILS OF GENERAL LAYOUT SEE BOOK OF DEPOT DRAWING ML-DP 303.

SCALE 1:100 (A1) SCALE 1:200 (A3) Drawing Status P04 JUL.22 FOR RAILWAY ORDER SSR JDR PB Client JBL Drawing Title METROLINK - STRUCTURES P03 MAY 22 FOR RAILWAY ORDER NC Údarás Náisiúnta lompair National Transport Authority **METROLINK** DEPOT. PERMANENT WAY & MAINTENANCE BUILDING (BUILDING P) ELEVATIONS NC P02 NOV.21 FOR RAILWAY ORDER JBL NC SSR JBL P01 OCT.21 FOR RAILWAY ORDER DRAWN BY CHECKED BY REVIEWED BY APPROVED BY REV. DATE Description Plan Drawing N⁰ Drawing Nº ML1-JAI-SRD-ROUT_XX-DR-Y-05022 ML-DP 303 B-C4 is an operational name of the National Roads Authority. **JACOBS** IDOM Scales Original Size A1 AS SHOWN Sheet 1 of 1 All Co-ordinates are in Irish Transverse Mercator Grid (ITM) as defined by OSi active GPS station Tallaght College (TLLG).

+62.00

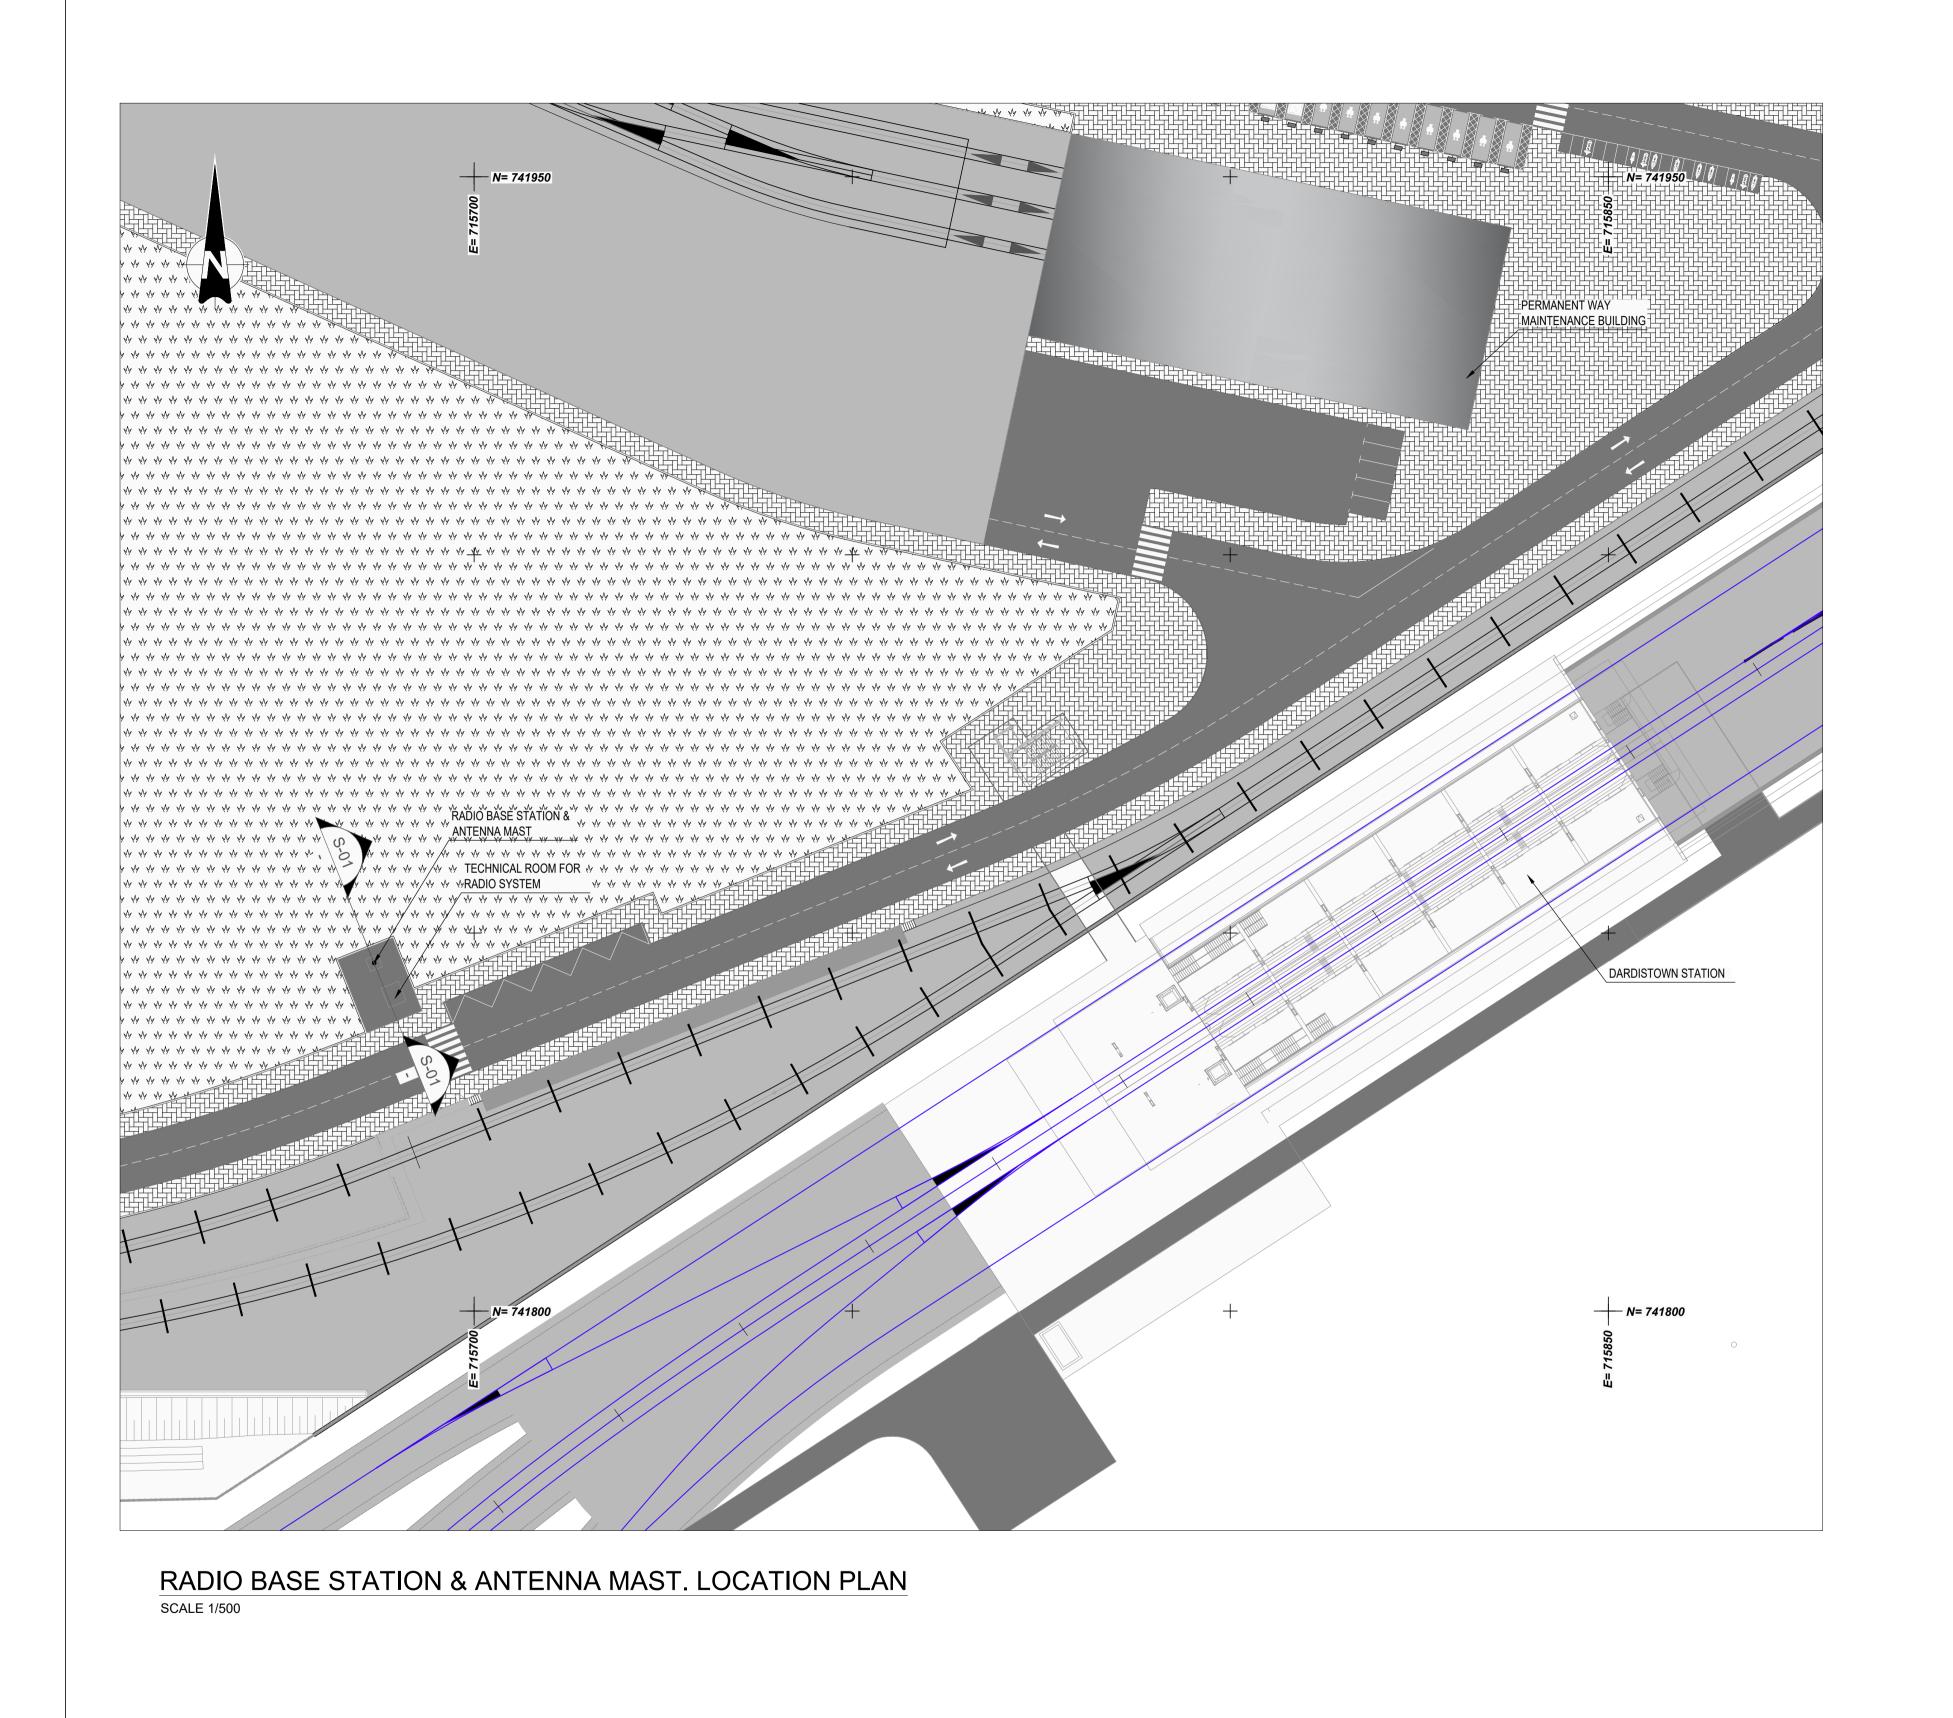

A LIGHT SIGNAL SHALL BE PLACED ON TOP OF THE ANTENNA. RADIO BASE STATION & ANTENNA MAST TECHNICAL ROOM FOR RADIO SYSTEM



SCALE 1:100 (A1) SCALE 1:200 (A3)

SCALE 1:500 (A1)
SCALE 1:1000 (A3)

METRES

SCALE 1:500 (A1)
SCALE 1:1000 (A3)

METRES

SCALE 1:1000 (A3)

METRES

SCALE 1:500 (A1)
SCALE 1:1000 (A3)

METRES

SCALE 1:500 (A1)

D Ordnance Survey Ireland 2022/ OSi_NMA_273.

All Co-ordinates are in Irish Transverse Mercator Grid (ITM) as defined by OSi active GPS station Tallaght College (TLLG).

Client

The second language favorer (National Transport Authority)

Project

METROLINK

Drawing Title

METROLINK - COMMUNICATIONS
RADIO BASE STATION & ANTENNA
LOCATION PLAN & SECTION

METRES

NTENNA
STION

Plan Drawing N°

ML PM 202.0


Drawing Status


JACOBS


IDOM


Drawing N° Plan Drawing N° ML1-JAI-SRD-ROUT_XX-DR-Y-09002 ML-RM 303 0

Scales Original Size A1 AS SHOWN Sheet 1 of 1

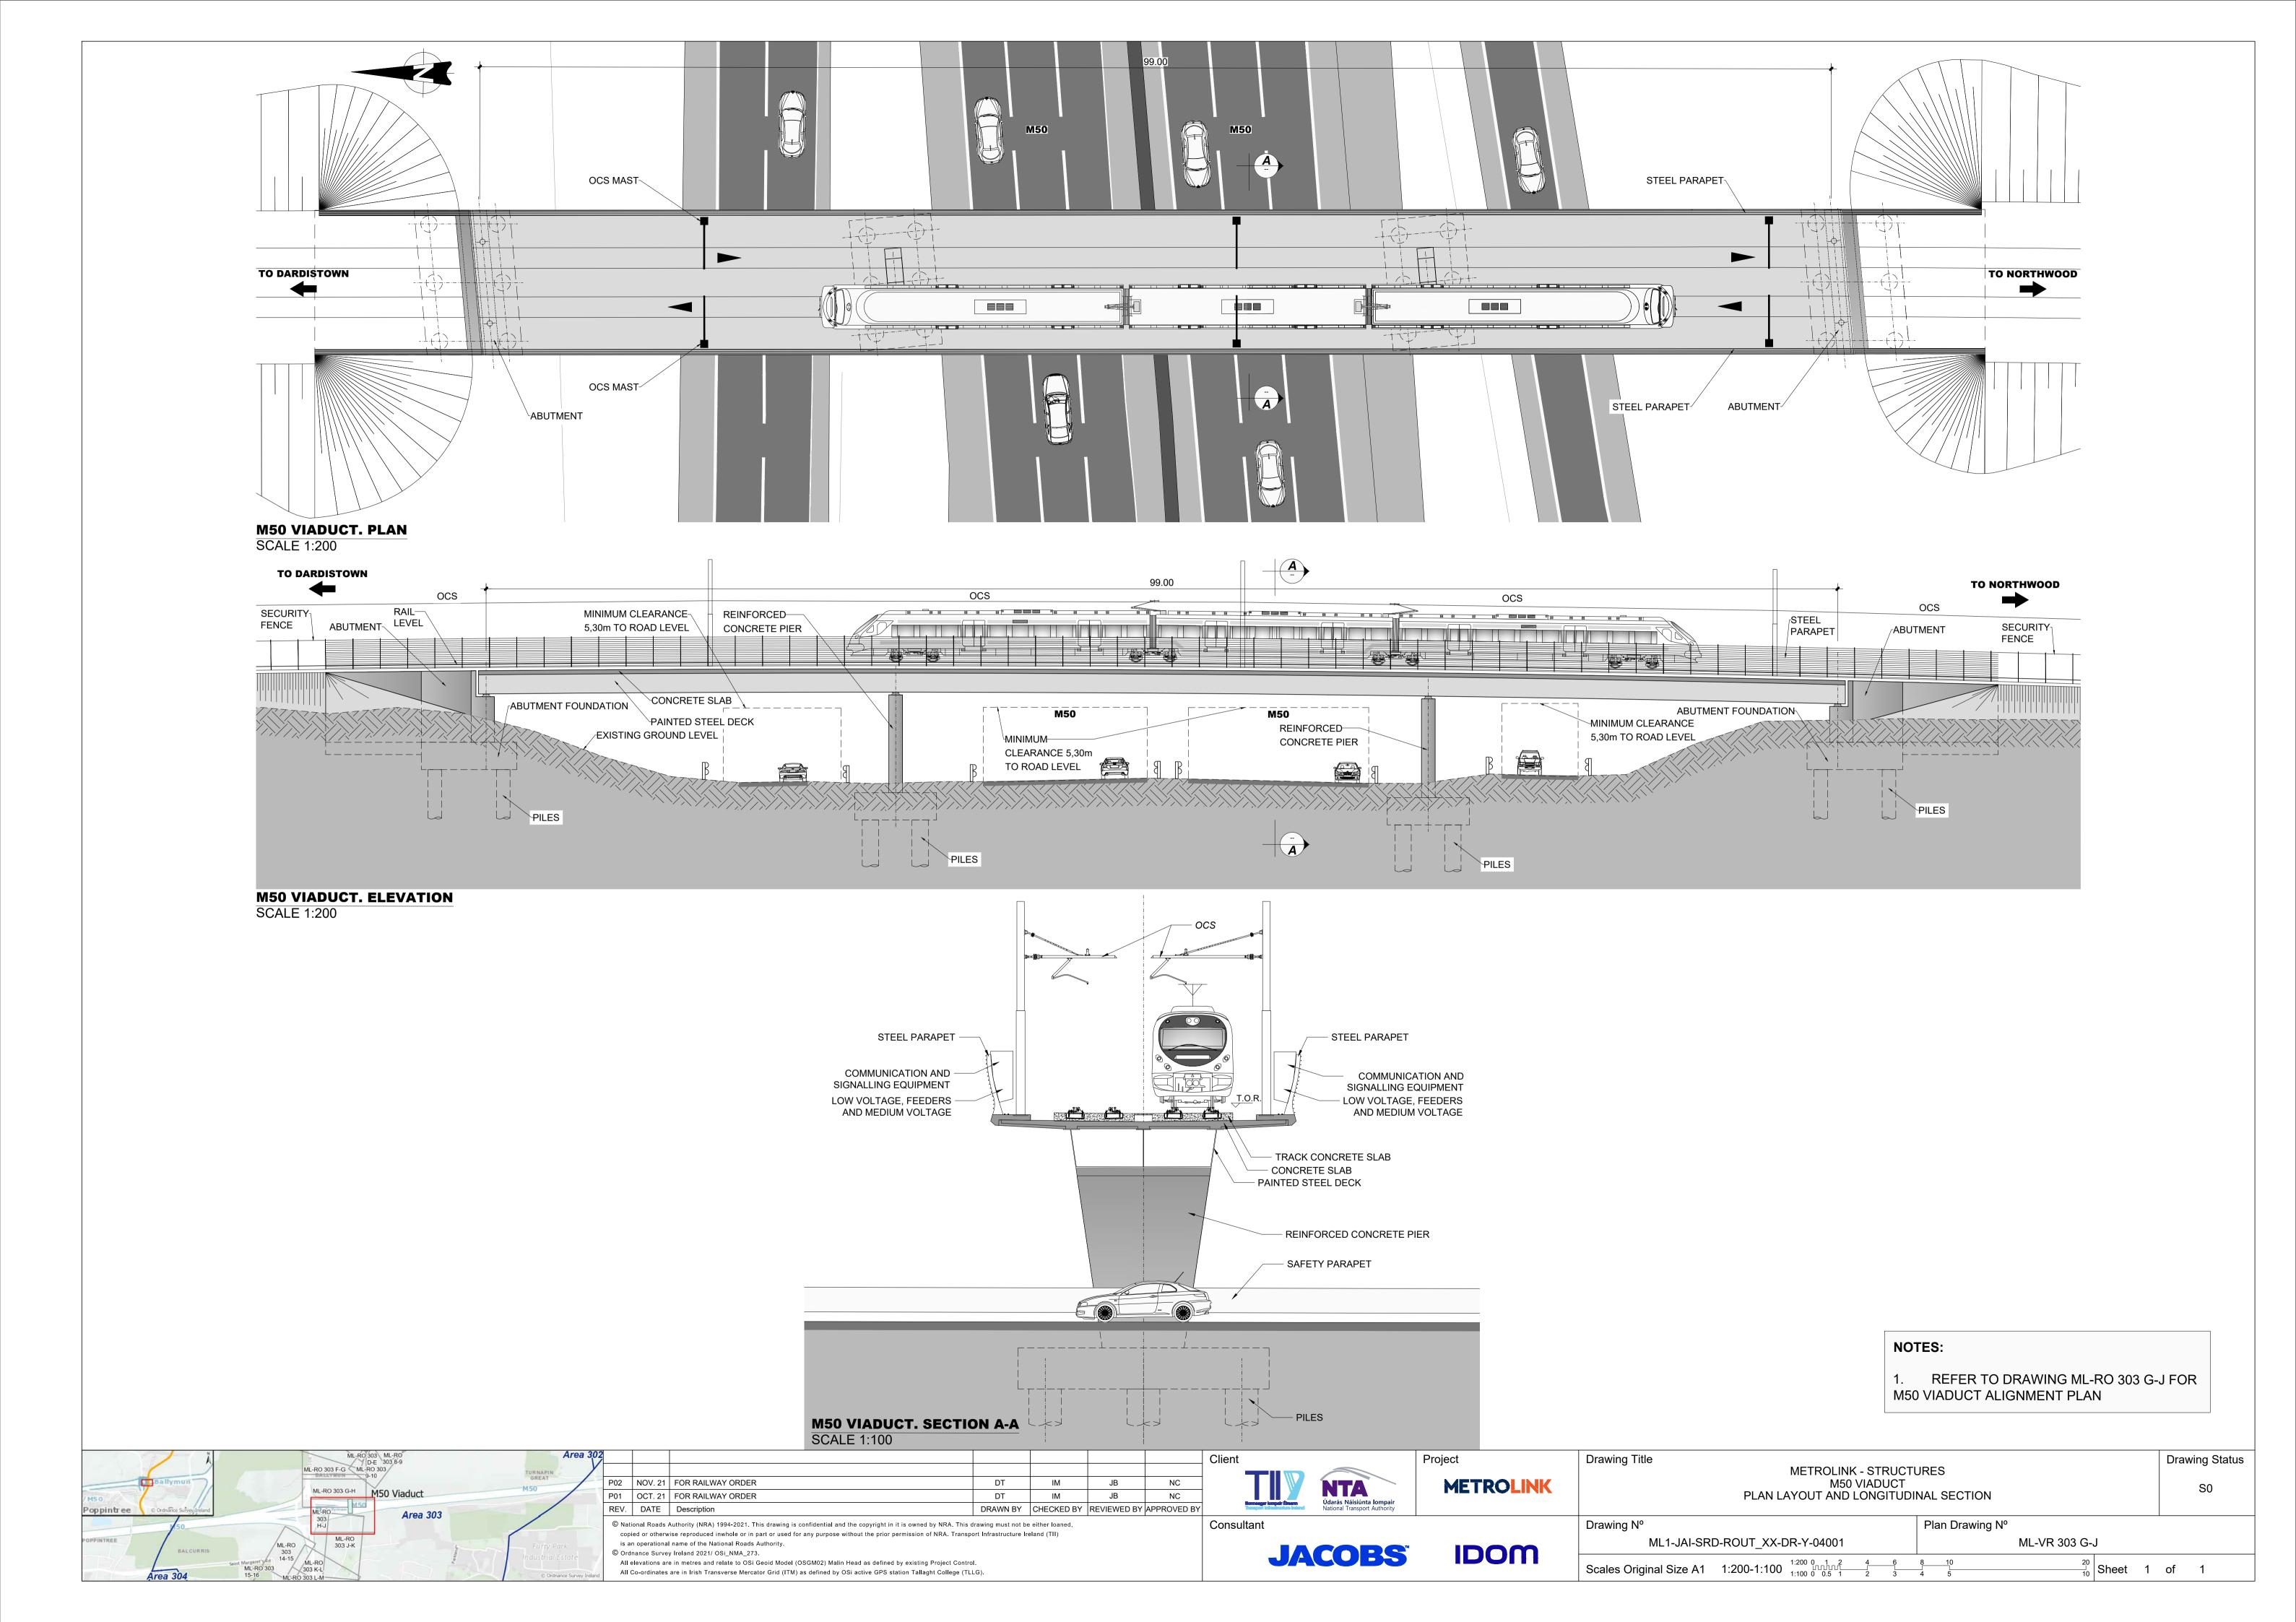

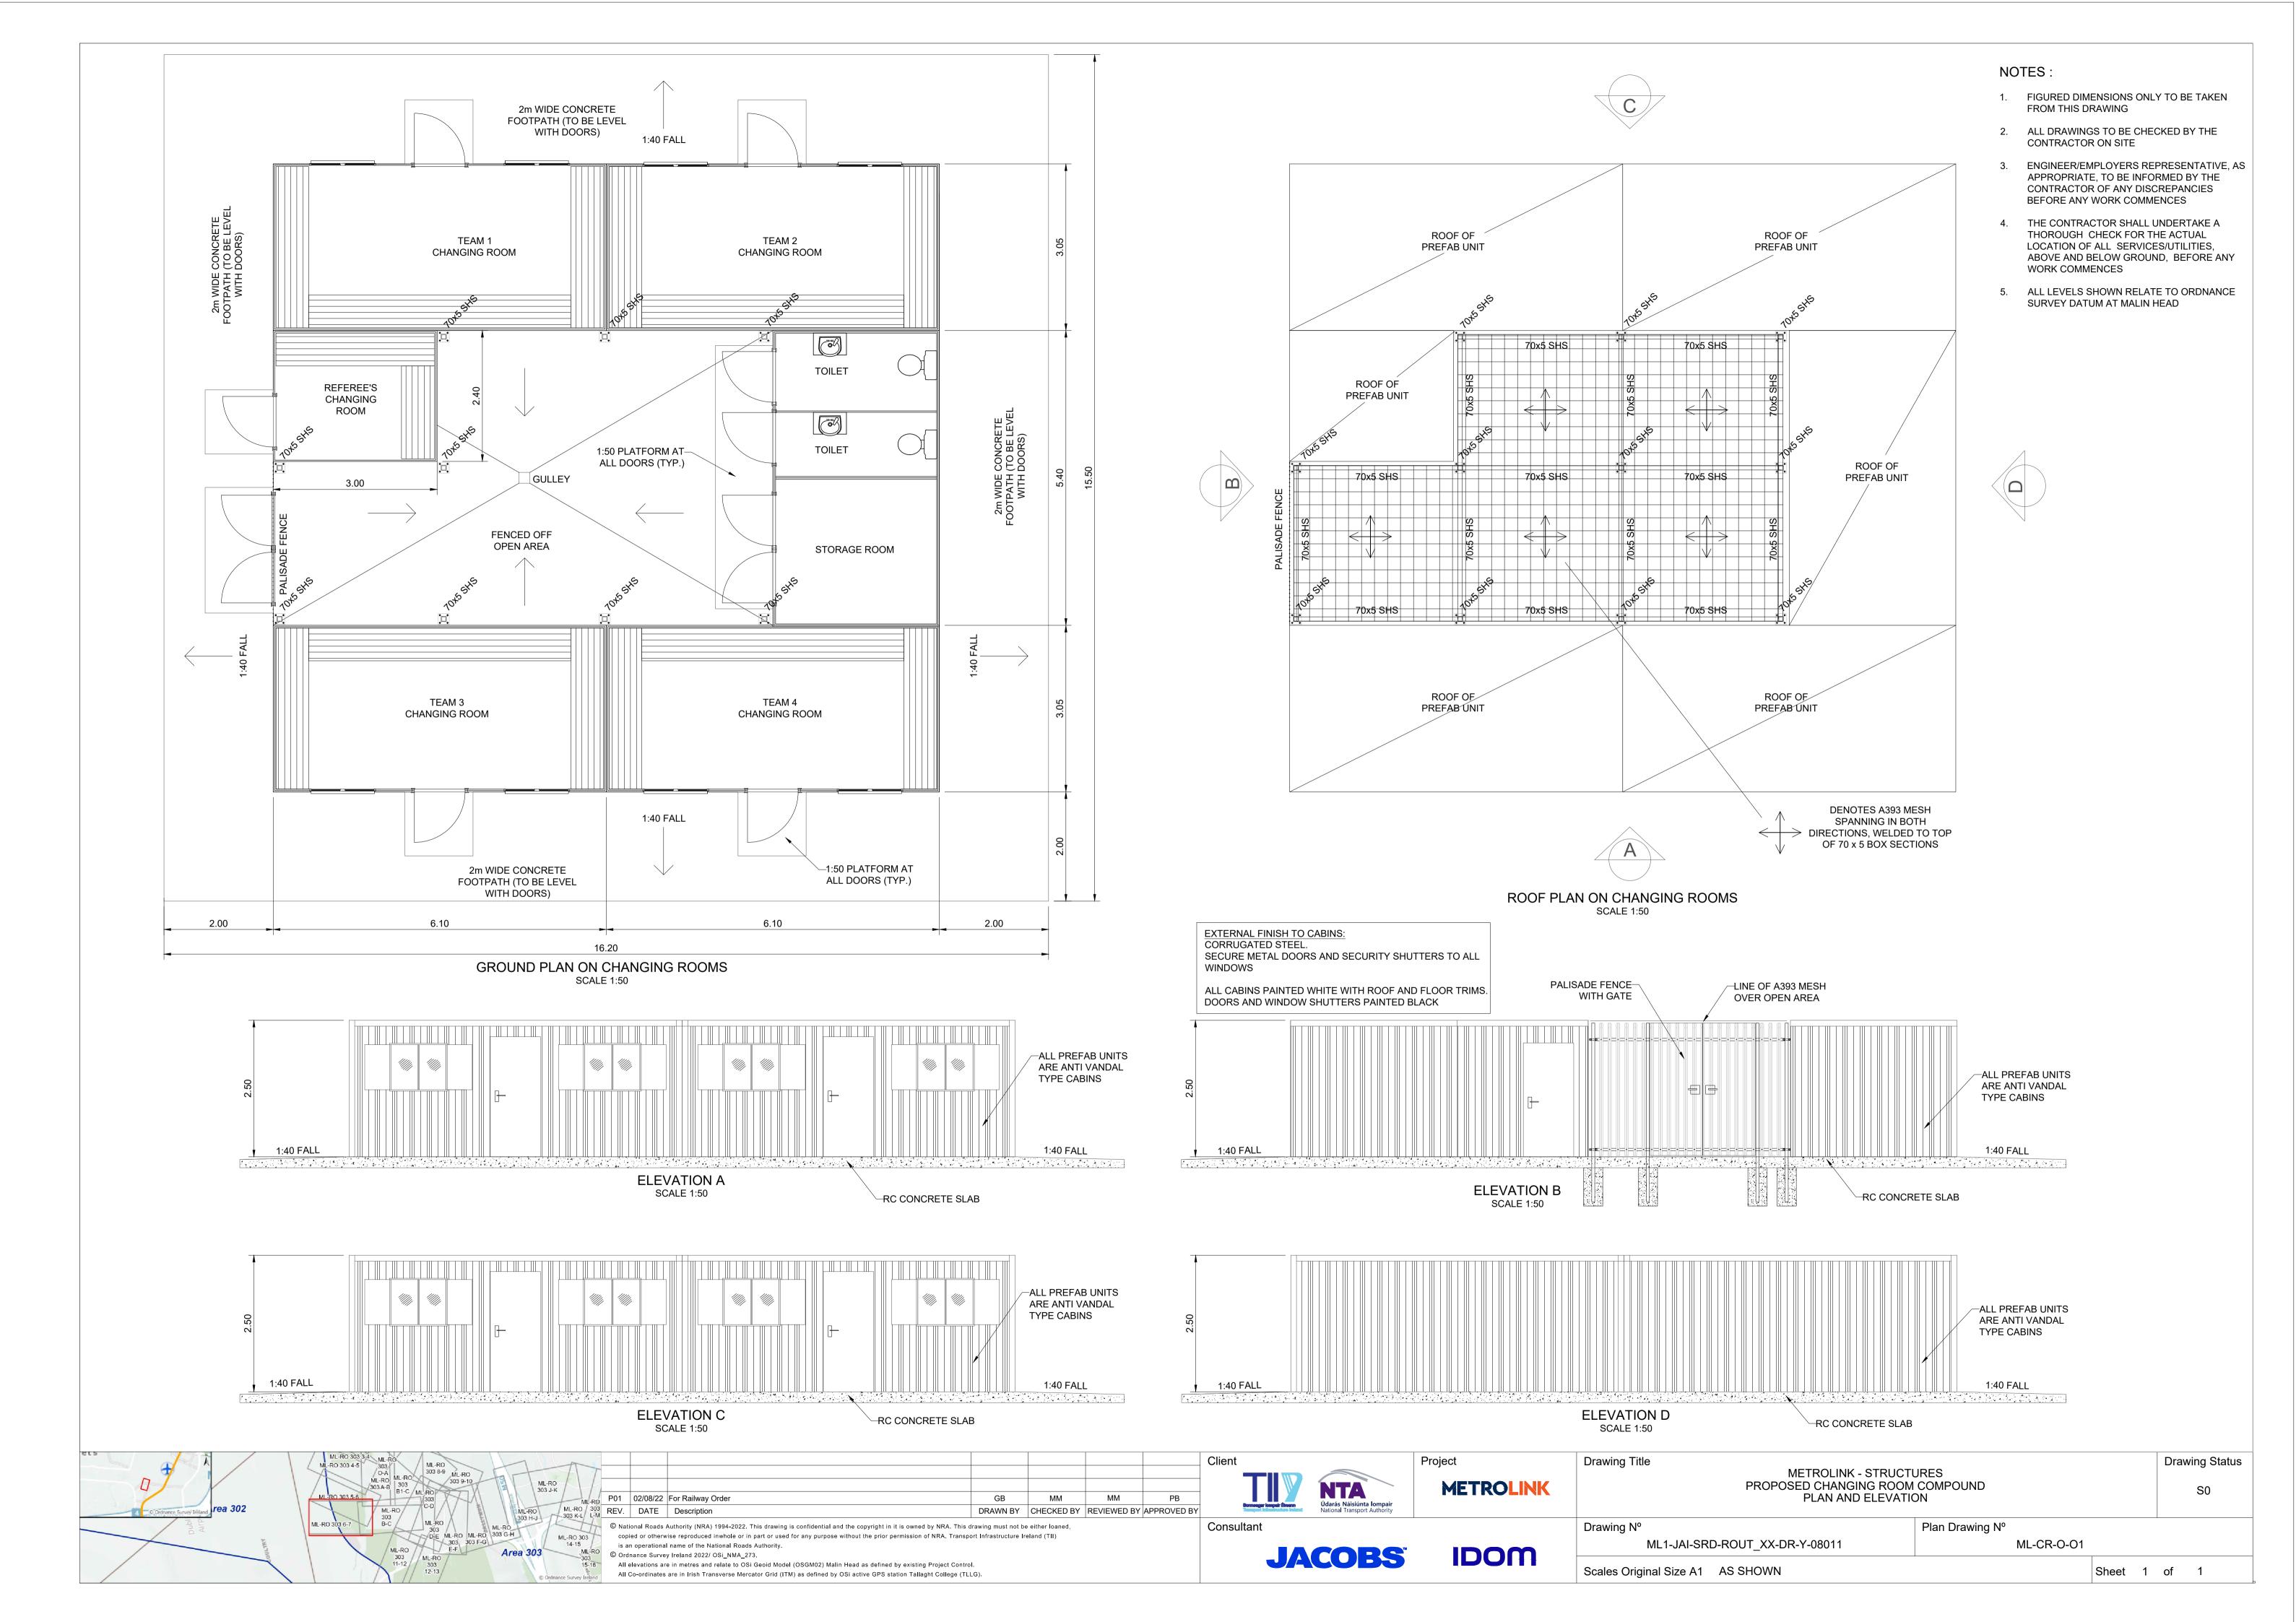


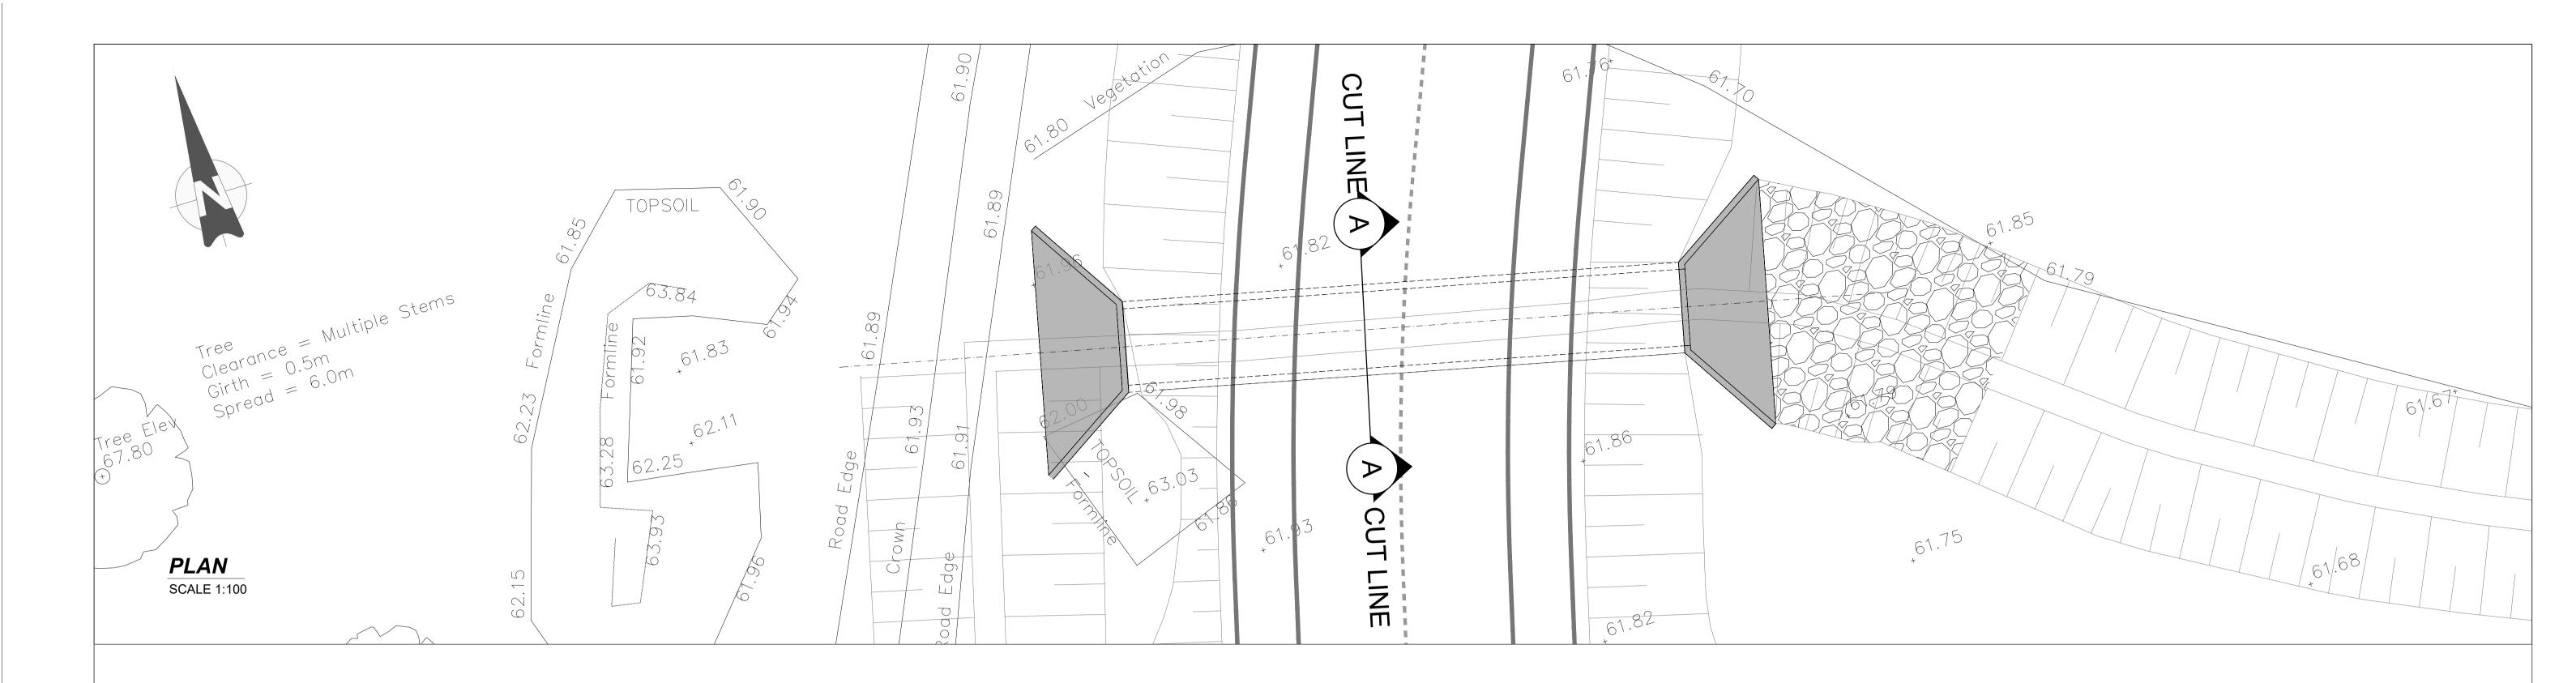

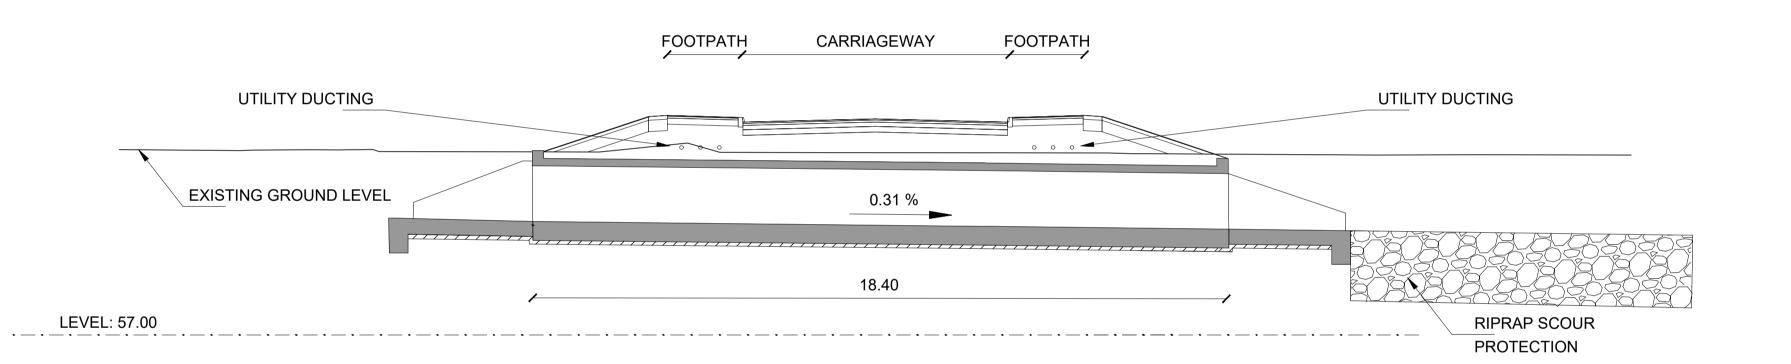

TYPICAL LONGITUDINAL SECTION

SCALE 1:100

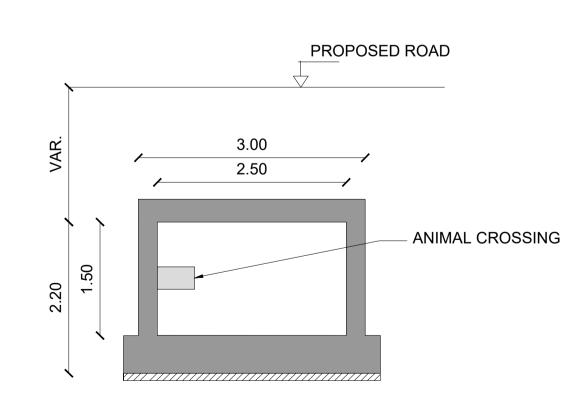

SECTION A-A

SCALE 1:50

NOTE:

REFER TO DRAWING ML-RO 303 6-7 FOR CULVERT ALIGNMENT PLAN

